

April 2023

London Luton Airport Expansion

Planning Inspectorate Scheme Ref: TR020001

Volume 4 Plans and Sections

4.09 General Arrangement Drawings (Part 2 of 3)



The Planning Act 2008

The Infrastructure Planning (Applications: Prescribed Forms and Procedure) Regulations 2009

London Luton Airport Expansion Development Consent Order 202x

4.09 General Arrangement Drawings (Part 2 of 3)

Regulation number:	Regulation 5(2)(o)
Planning Inspectorate Scheme Reference:	TR020001
Document Reference:	TR020001/APP/4.09
Author:	Luton Rising

Version	Date	Status of Version
Issue 1	February 2023	Application issue
Revision 1	April 2023	Additional submissions (amended following section 51 advice)

London Luton Airport Expansion Development Consent Order

General Arrangement Drawings

Contents

		Page
1	General Arrangement Drawings	2
1.1	Purpose of this document	2
1.2	Scope and format of the General Arrangements Drawings	2
1.3	General Arrangement Drawings list	2

London Luton Airport Expansion Development Consent Order

1 GENERAL ARRANGEMENT DRAWINGS

1.1 Purpose of this document

1.1.1 Luton Rising (a trading name of London Luton Airport Limited), owners of London Luton Airport (the Applicant) has submitted an application under section 37 of the Planning Act 2008 for an order to grant development consent for the expansion of London Luton Airport (the Proposed Development).

- 1.1.2 This document is part of a suite of documents which forms part of the application for development consent. A full description of all the application documents is provided in the Introduction to the Application) [TR020001/APP/1.03] which also forms part of the suite of application documents.
- 1.1.3 This document is included in the application to comply with Regulation 5(2)(o) of the Infrastructure Planning (Applications: Prescribed Forms and Procedures) Regulations 2009 ("the 2009 Regulations"), which requires:
 - i. 5(2)(o) 'any other plans, drawings and sections necessary to describe the proposals for which development consent is sought, showing details of design, external appearance, and the preferred layout of buildings or structures, drainage, surface water management, means of vehicular and pedestrian access, any car parking to be provided, and means of landscaping'
- 1.1.4 As this document is part of the application documentation, it should be read alongside, and is informed by, the other application documents. In particular, the plans should be read alongside Schedule 1 of the draft Order [TR020001/APP/2.01] and the Works Plans [TR020001/APP/4.04].

1.2 Scope and format of the General Arrangements Drawings

- 1.2.1 The purpose of the General Arrangement Drawings is to illustrate what certain parts of the Proposed Development might look like. This includes showing indicative floorplans and elevations of terminal and ancillary buildings as well as structures such as the surface movement radar.
- 1.2.2 The information shown on these drawings is in line with the preliminary design status of the Proposed Development and is therefore indicative. Parameters for the various works are provided for in the draft Order [TR020001/APP/2.01] and any detailed design will be in accordance with those parameters and the other constraints imposed by the draft Order.
- 1.2.3 Drawings showing road junction mitigation works that will be necessary as a result of the Proposed Development are shown in the Offsite Highway Works Plans [TR020001/APP/4.13]. They are also shown in the Transport Assessment [TR020001/APP/7.02] because they contain information which is necessary to inform the approach to that assessment. An explanation of why these plans are needed and what they entail can be found in the Transport Assessment.

1.3 General Arrangement Drawings list

General Arrangement Plans and Engineering Drawings and Sections Drawing Name	Drawing Number	Work No.
Assessment Phase 1 Earthworks Proposed Indicative Landform	LLADCO-3C-ARP-WHS-BEW-DR-GT-0401	1a
Assessment Phase 2a Earthworks Proposed Indicative Landform	LLADCO-3C-ARP-WHS-BEW-DR-GT-0403	1a
Assessment Phase 2b Earthworks Proposed Indicative Landform	LLADCO-3C-ARP-WHS-BEW-DR-GT-0405	1a
Indicative Surface Movement Radar Plan & Section	LLADCO-3C-ACM-AIR-MSC-DR-CE-0001	2a(02)
Indicative Fire Training Ground Plan & Section	LLADCO-3C-ACM-AIR-FTR-DR-CE-0001	2d
Indicative Engine Run-Up Bay Plan & Section	LLADCO-3C-ACM-AIR-ENG-DR-CE-0001	2f,2g
Indicative General Arrangement Terminal 1 New Pier C & External Canopy - Plan & Section	LLADCO-3C-IDM-STR-TR1-DR-AR-0001	3a
Indicative General Arrangement Terminal 1 South Extension	LLADCO-3C-IDM-STR-TR1-DR-AR-0004	3a(03)
Indicative General Arrangement Terminal 1 North Extensions	LLADCO-3C-IDM-STR-TR1-DR-AR-0007	3a(02) / 3a(04)
Indicative General Arrangement Terminal 1 Baggage Hall Extensions Plan & Section	LLADCO-3C-IDM-STR-TR1-DR-AR-0008	3a(05)
Indicative Terminal 2 General Arrangement Overall Zone Use Level 00 Assessment Phase 2a	LLADCO-3C-ACM-AIR-TER-DR-AR-0103	3b(01)
Indicative Terminal 2 General Arrangement Overall Zone Use Level 00 Assessment Phase 2b	LLADCO-3C-ACM-AIR-TER-DR-AR-0104	3b(02)

London Luton Airport Expansion Development Consent Order


General Arrangement Drawings

General Arrangement Plans and Engineering Drawings and Sections Drawing Name	Drawing Number	Work No.
Indicative Terminal 2 General Arrangement Overall Zone Use Level 01 Assessment Phase 2a	LLADCO-3C-ACM-AIR-TER-DR-AR-0105	3b(01)
Indicative Terminal 2 General Arrangement Overall Zone Use Level 01 Assessment Phase 2b	LLADCO-3C-ACM-AIR-TER-DR-AR-0106	3b(02)
Indicative Terminal 2 General Arrangement Main Building Zone Use Level 00 Assessment Phase 2a	LLADCO-3C-ACM-AIR-TER-DR-AR-0107	3b(01)
Indicative Terminal 2 General Arrangement Main Building Zone Use Level 00 Assessment Phase 2b	LLADCO-3C-ACM-AIR-TER-DR-AR-0108	3b(02)
Indicative Terminal 2 General Arrangement Main Building Zone Use Level 01 Assessment Phase 2a	LLADCO-3C-ACM-AIR-TER-DR-AR-0109	3b(01
Indicative Terminal 2 General Arrangement Main Building Zone Use Level 01 Assessment Phase 2b	LLADCO-3C-ACM-AIR-TER-DR-AR-0110	3b(02)
Indicative Terminal 2 Cross Sections Assessment Phase 2b	LLADCO-3C-ACM-AIR-TER-DR-AR-0401	3b(01)
Indicative Terminal 2 Pier Cross Sections Assessment Phase 2b	LLADCO-3C-ACM-AIR-TER-DR-AR-0402	3b(02)
Indicative Terminal 2 General Arrangement Floor Plan West Pier Level 00 Assessment Phase 2b	LLADCO-3C-ACM-AIR-WP2-DR-AR-0111	3c(01)
Indicative Terminal 2 General Arrangement Floor Plan West Pier Level 01 Assessment Phase 2b	LLADCO-3C-ACM-AIR-WP2-DR-AR-0112	3c(01)
Indicative Terminal 2 General Arrangement Floor Plan East Pier Level 00 Assessment Phase 2b	LLADCO-3C-ACM-AIR-EP2-DR-AR-0113	3c(02)
Indicative Terminal 2 General Arrangement Floor Plan East Pier Level 01 Assessment Phase 2b	LLADCO-3C-ACM-AIR-EP2-DR-AR-0114	3c(02)
Indicative Coach Station Sections & Elevations	LLADCO-3C-CAP-STR-SFA-PRK-AR-1383	3d
Indicative Luton Dart Extension- Plan and Section	LLADCO-3C-ARP-RAL-MPT-DR-AR-6002	3g
Indicative Energy Centre & Terminal 2 Service Yard Welfare Unit Sections & Elevations	LLADCO-3C-CAP-STR-WRH-WRH-AR-1312	3h
Indicative Airport Operations and Maintenance Elevations	LLADCO-3C-CAP-STR-WRH-AR-1354	3i
Indicative Hotel Elevations	LLADCO-3C-CAP-STR-HTL-DR-AR-1273	4a
Indicative Hangar A & B Elevations	LLADCO-3C-CAP-STR-WRH-WRH-AR-1373	4b
Indicative Layout for Fuel Storage Facility	LLADCO-3C-ACM-AIR-FFA-DR-CE-0002	4c
Indicative General Arrangement Above Ground Fuel Installation	LLADCO-3C-ACM-AIR-FFA-DR-CE-0005	4c
Indicative Solar Battery Storage Elevations	LLADCO-3C-CAP-STR-WRH-DR-AR-1393	4e
Indicative Airside-Landside Boundary Sections	LLADCO-3C-ACM-AIR-FEN-DR-CE-0005	4f
Indicative General Arrangement Airfield Fencing Assessment Phase 1	LLADCO-3C-ACM-AIR-FEN-DR-CE-0006	4f
Indicative General Arrangement Airfield Fencing Assessment Phase 2a	LLADCO-3C-ACM-AIR-FEN-DR-CE-0002	4f
Indicative Airfield Fencing Layout Assessment Phase 2b	LLADCO-3C-ACM-AIR-FEN-DR-CE-0001	4f
Indicative Deck & Surface Carpark Elevations	LLADCO-3C-CAP-STR-PRK-DR-AR-1413	4k(01)
Indicative Deck & Surface Parking Elevations	LLADCO-3C-CAP-STR-PRK-DR-AR-1313	40(01) / 40(02)
Indicative General Arrangement Solar Car Port	LLADCO-3C-ACM-INF-MSC-DR-AR-0001	4p(02) / 4q(02)
Indicative Forecourt Multistorey Car Park Typical Plan	LLADCO-3C-CAP-STR-PRK-DR-AR-1208	4r
Indicative Multistorey Car Park Elevations	LLADCO-3C-CAP-STR-PRK-DR-AR-1210	4r
Indicative Police Station Elevations	LLADCO-3C-CAP-STR-OFC-OFC-AR-1342	4u
Indicative Substation Layout & Elevations	LLADCO-3C-ACM-AIR-UTL-DR-CE-0020	4w / 4x


London Luton Airport Expansion Development Consent Order

General Arrangement Plans and Engineering Drawings and Sections Drawing Name	Drawing Number	Work No.
Airport Access Road Indicative Highways General Arrangement Key plan	LLADCO-3C-ARP-WHS-HWM-DR-HY-0100	6a(01), 6a(02), 6a(03)
Airport Access Road Indicative Highways General Arrangement Sheet 1 of 10	LLADCO-3C-ARP-SFA-HWM-DR-HY-0101	6a(01), 6a(02), 6a(03)
Airport Access Road Indicative Highways General Arrangement Sheet 2 of 10	LLADCO-3C-ARP-SFA-HWM-DR-HY-0102	6a(01), 6a(02), 6a(03)
Airport Access Road Indicative Highways General Arrangement Sheet 3 of 10	LLADCO-3C-ARP-SFA-HWM-DR-HY-0103	6a(01), 6a(02), 6a(03)
Airport Access Road Indicative Highways General Arrangement Sheet 4 of 10	LLADCO-3C-ARP-SFA-HWM-DR-HY-0104	6a(01), 6a(02), 6a(03)
Airport Access Road Indicative Highways General Arrangement Sheet 5 of 10	LLADCO-3C-ARP-SFA-HWM-DR-HY-0105	6a(01), 6a(02), 6a(03)
Airport Access Road Indicative Highways General Arrangement Sheet 6 of 10	LLADCO-3C-ARP-SFA-HWM-DR-HY-0106	6a(01), 6a(02), 6a(03)
Airport Access Road Indicative Highways General Arrangement Sheet 7 of 10	LLADCO-3C-ARP-SFA-HWM-DR-HY-0107	6a(01), 6a(02), 6a(03)
Airport Access Road Indicative Highways General Arrangement Sheet 8 of 10	LLADCO-3C-ARP-SFA-HWM-DR-HY-0108	6a(01), 6a(02), 6a(03)
Airport Access Road Indicative Highways General Arrangement Sheet 9 of 10	LLADCO-3C-ARP-SFA-HWM-DR-HY-0109	6a(01), 6a(02), 6a(03)
Airport Access Road Indicative Highways General Arrangement Sheet 10 of 10	LLADCO-3C-ARP-SFA-HWM-DR-HY-0110	6a(01), 6a(02), 6a(03)
Airport Access Road Indicative Highways Cross Sections Sheet 1 of 4	LLADCO-3C-ARP-SFA-HWM-DR-HY-0501	6a(01), 6a(02), 6a(03)
Airport Access Road Indicative Highways Cross Sections Sheet 2 of 4	LLADCO-3C-ARP-SFA-HWM-DR-HY-0502	6a(01), 6a(02), 6a(03)
Airport Access Road Indicative Highways Cross Sections Sheet 3 of 4	LLADCO-3C-ARP-SFA-HWM-DR-HY-0503	6a(01), 6a(02), 6a(03)
Airport Access Road Indicative Highways Cross Sections Sheet 4 of 4	LLADCO-3C-ARP-SFA-HWM-DR-HY-0504	6a(01), 6a(02), 6a(03)



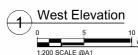



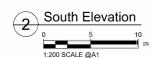





- This drawing is an indicative layout and can only be used for information purposes.
- Exact details concerning configuration and dimensions will be determined and designed at the detailed design stage in line with provisions of the DCO.
- Parameter heights are shown in metres above datum (AOD).


KEY

177.00 Parameter height (AOD)

Maximum Parameter height lines

Parameter height lines

INDICATIVE LAYOUT

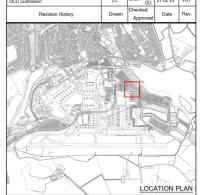

Luten Rising our cisport. Our planet.

Luton Rising Hart House Busines's Centre Kim pton Road, Luton, LU2 0LA


P01


London Luton Airport Development Consent Order


INDICATIVE HOTEL ELEVATIONS

Purpose of issu	ie				Suitabil	ity
	DC	O SU	BMISSIO	N	S6	
Drawn LC	Checke	ed RM	Approved Date GU 27-02-23		Scale 1:200	Size A1
DCO Application Ref TR020001		APFP Regulation 5(2)(0)		DCO Docume TR020001/		
Drawing Num I	per					Revision

LLADCO-3C-CAP-STR-HTL-DR-AR-1273

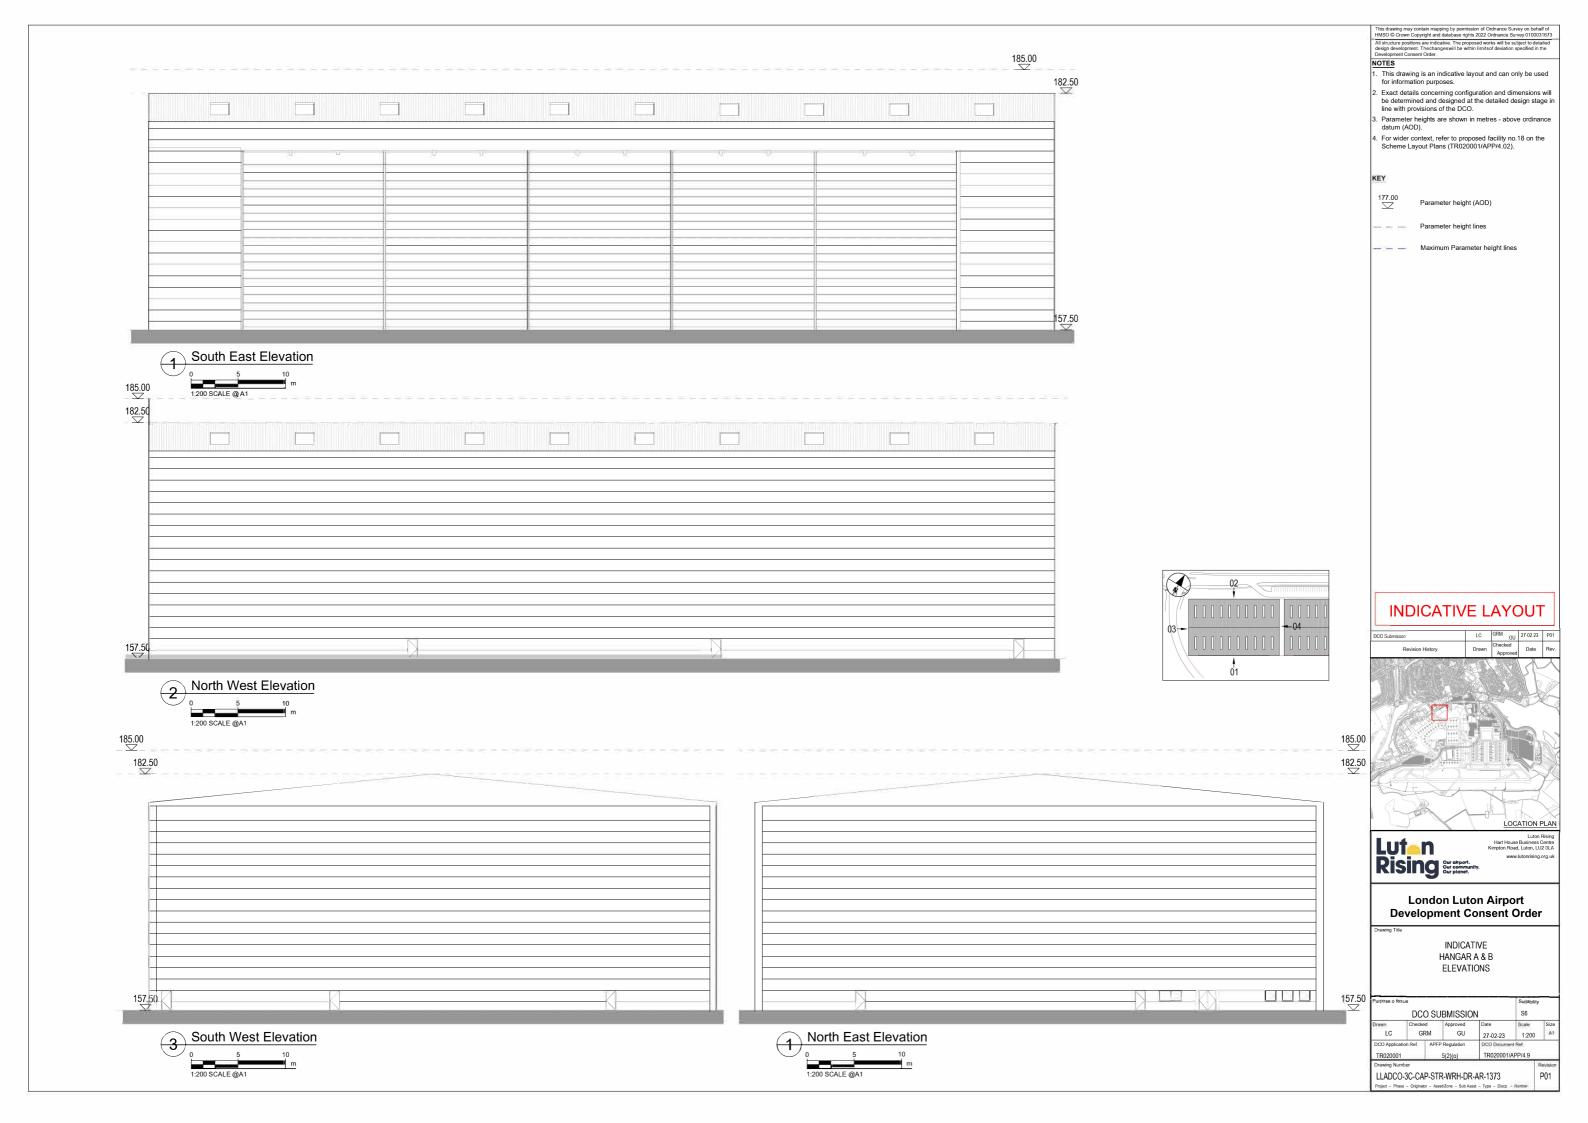

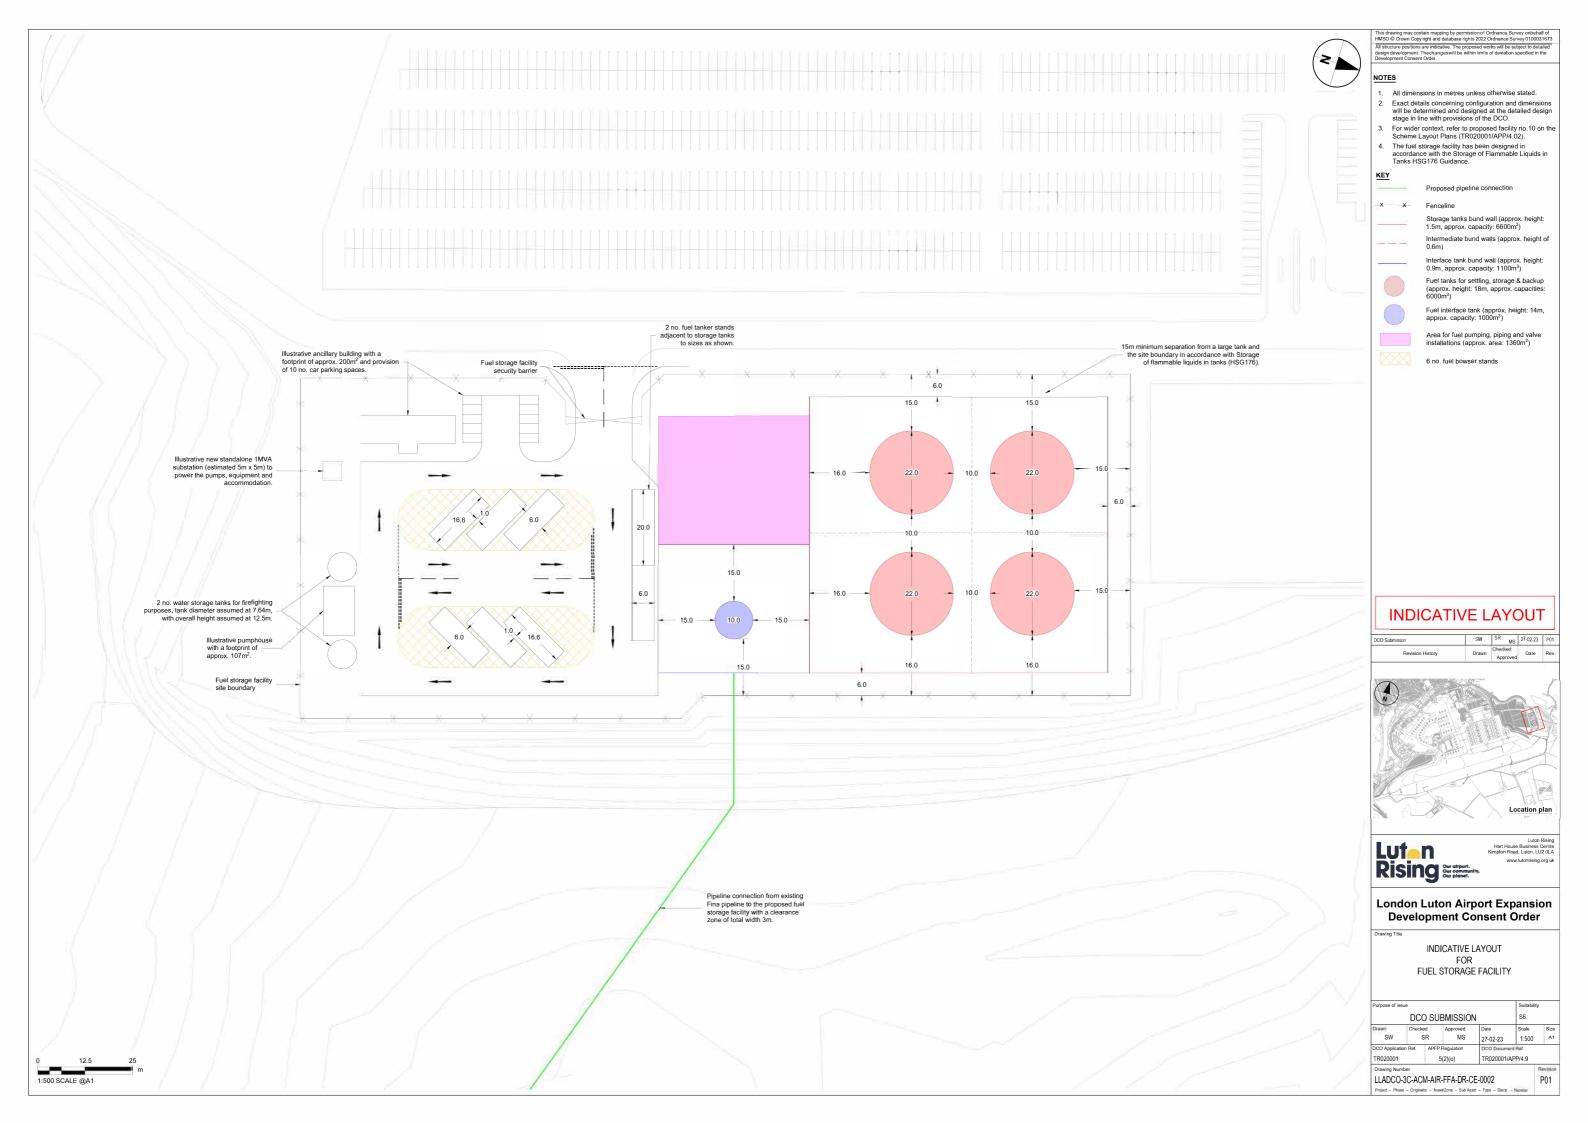


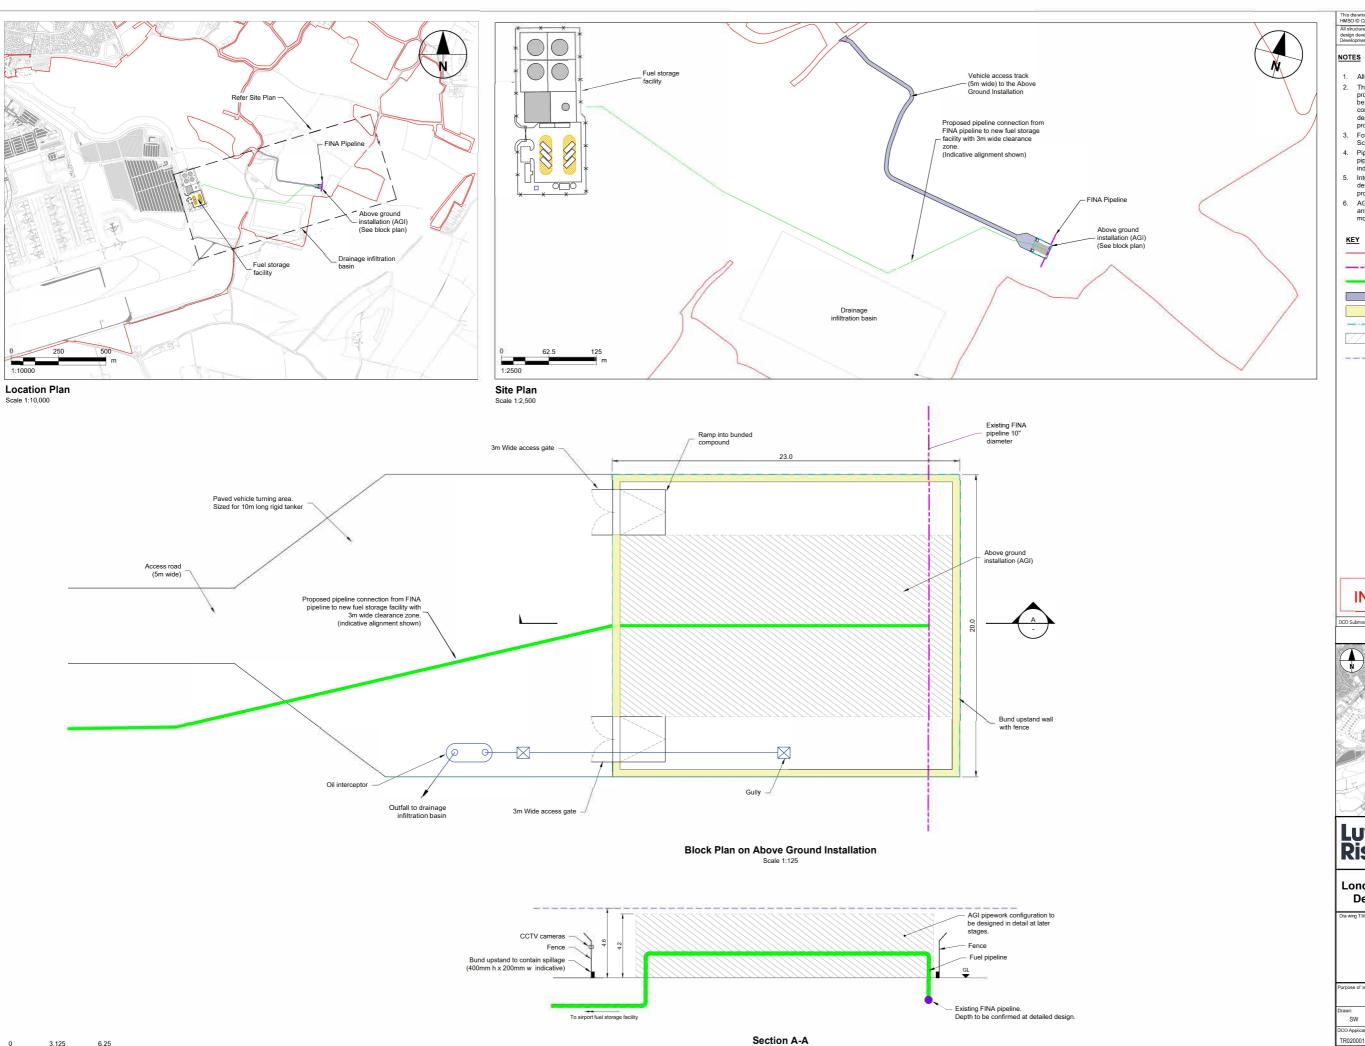

Scale 1:125

This da wing may contain mapping by permission of Ordnance Survey on behalf of HMSO © Crown Copy right and data base rights 2022 Ordnance Survey 0100031673 All structure positions are indicative. The proposed works will be subject to detailed design development. The changes will be within limits of deviation specified in the Development Crosent Order.

- All dimensions in metres unless otherwise stated.
- An dimensions in metres unless onerwise stated.
 This drawing is a premilinary indicative design of the proposed above ground installation (AGI) and can only be used for these purposes. Exact details concerning configuration and dimensions will be determined and designed at the detailed design stage in line with provisions of the DCO.
- For wider context, refer to proposed facility no.11 on the Scheme Layout Plans (TR020001/APP/4.02).
- Scheme Layout Plans (1R02000 InAPP/4.02).
 Pipeline connection alignment from existing FINA pipeline to proposed fuel storage facility is shown indicatively.
 Interceptor design is schematical and subject to detailed design at the detailed design stage in line with provisions of the DCO.
- AGI facility to be secured with a fence which includes anti climb element. It may also require CCTV, detection monitoring and security alarm.

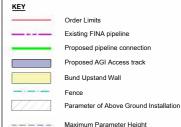

Existing FINA pipeline

Proposed pipeline connection

Bund Upstand Wall

Maximum Parameter Height

INDICATIVE LAYOUT

DCO Submisson	SW	SR MS	27-02-23	P01
Revision History	Drawn	Checked Approved	Date	Rev.
		7	D	X
		-27	\ \frac{1}{2}	H)
		7	~	L
	- OA	0		S
		图		\swarrow
				_
	75	Y]7		_
	1	1	M	13
	T	the second	\times	4
	- ANT -			7
		Loc	ation pla	. I




P01


London Luton Airport Expansion Development Consent Order


INDICATIVE GENERAL ARRANGEMENT ABOVE GROUND FUEL INSTALLATION


Purpose of Issu	rurpose or issue						
	DCO SUBMISSION						
SW SR			-		Scale AS SHOWN	Size A1	
DCO Application Ref. TR020001			Regulation (2)(o)		TR020001/APP/4.9		


LLADCO-3C-ACM-AIR-FFA-DR-CE-0005

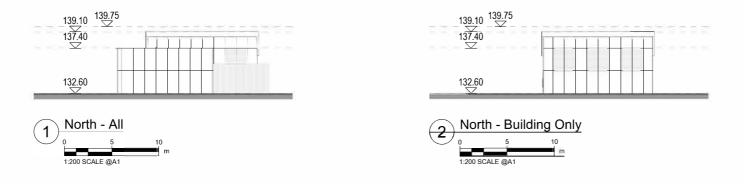


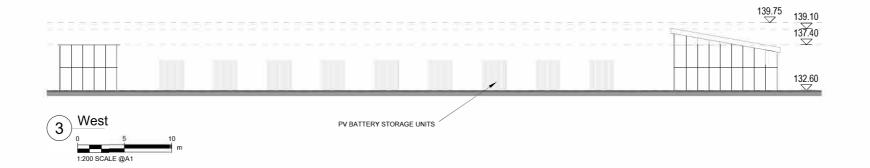

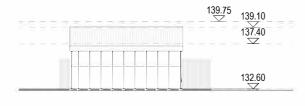

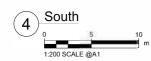

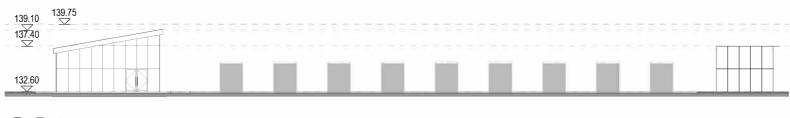

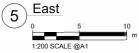


- This drawing is an indicative layout and can only be used for information purposes.
- Exact details concerning configuration and dimensions will be determined and designed at the detailed design stage in line with provisions of the DCO.
- . Parameter heights are shown in metres abov datum (AOD).

KEY

177.00 Parameter height (AOD) Parameter height lines

— — Maximum Parameter height lines



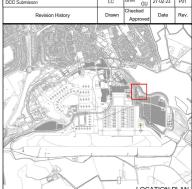





P01


London Luton Airport Development Consent Order


03 02


INDICATIVE SOLAR BATTERY STORAGE ELEVATIONS

Purpose of issu	е				Suitabilit	у
	S6					
Drawn LC	Checke	ed RM	Approved GU	Date 27-02-23	Scale 1:200	Size A1
DCO Application Ref. AF			Regulation 5(2)(0)	DCO Docume TR020001/		
Drawing Numb	or					Revision

LLADCO-3C-CAP-STR-WRH-DR-AR-1393

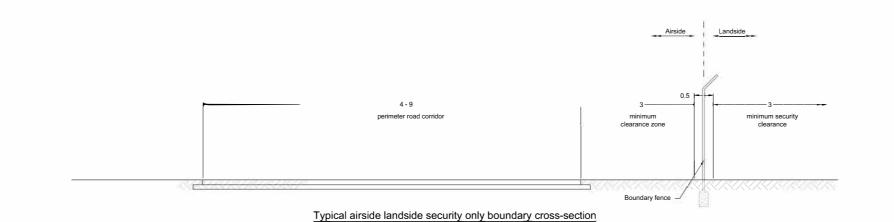

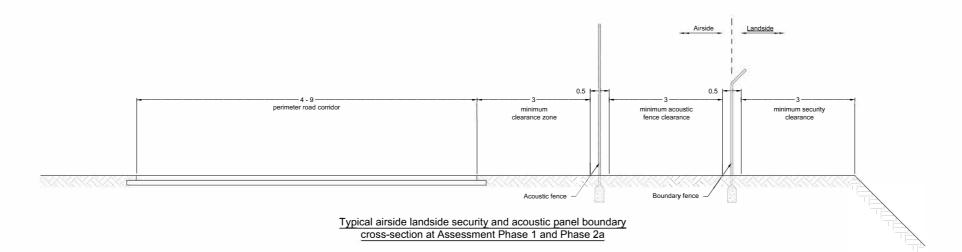

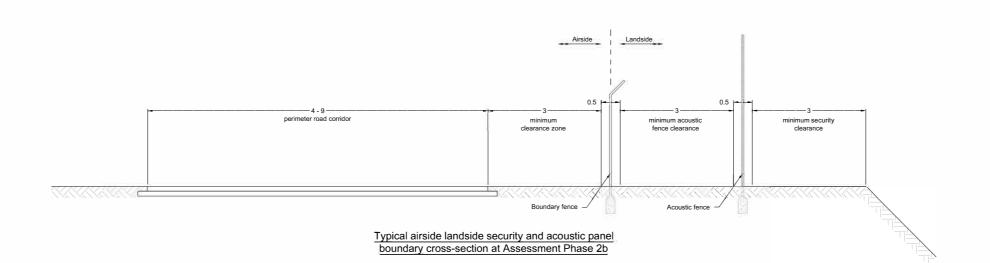

This drawing may contain mapping by permission of Ordnance Survey on behalf of HMSO © Crown Ceptright and database rights 2022 Ordnance Survey 0100031673 All structure positions are indicative. The proposed workswill be subject to detailed designdevelopment. Thechanges will be within limits of deviations pecified in the Development Consent Order.

NOTES

- All dimensions are in metres unless otherwise stated.
 Exact details concerning configuration and dimensions
- Exact details concerning configuration and dimensions will be determined and designed at the detailed design stage in line with provisions of the DCO.
- For wider context, refer to the Scheme Layout Plans (TR020001/APP/4.02).
- The existing airside perimeter fenceline will be retained where not impacted by the development. Proposed airside perimeter fencing will be installed as required by the development to maintain a continuous airside perimeter boundary.
- For fencing layout refer to drawings LLADCO-3C-ACM-AIR-FEN-DR-CE-0001, 0002 and 0006 for Phase 2b, 2a and 1 respectively.
- The proposed boundary fence would also include security sensors and required network. Exact detail and location would be determined at a Detailed Design stage in line with provisions of the DCO.
- Acoustic fence assumed to be 4m high similar to current acoustic fence at London Luton Airport along President Way.

INDICATIVE LAYOUT

1	DCO Submisson	SW	SR MS	27-02-23	P01
	Revision History	Drawn	Checked Approved	Date	Rev
ï					



Luton Rising
Hart House Business Centre
Kimpton Road, Luton, LU2 0LA
www.lutonrising.org.uk

P01

London Luton Airport Expansion Development Consent Order


Drawing


INDICATIVE AIRSIDE-LANDSIDE BOUNDARY SECTIONS


Purpose of issue	urpose of issue						
	DCO SUBMISSION						
Drawn	Checke	d	Approved	Date	Scale	Size	
SW	SW SR MS 27-02-23					1:50 A1	
DCO Application Ref APFP			Regulation	DCO Document	Ref		
TR020001			5(2)(o)	TR020001/AF	PP/4.9		


LLADCO-3C-ACM-AIR-FEN-DR-CE-0005


1:50 SCALE @A1

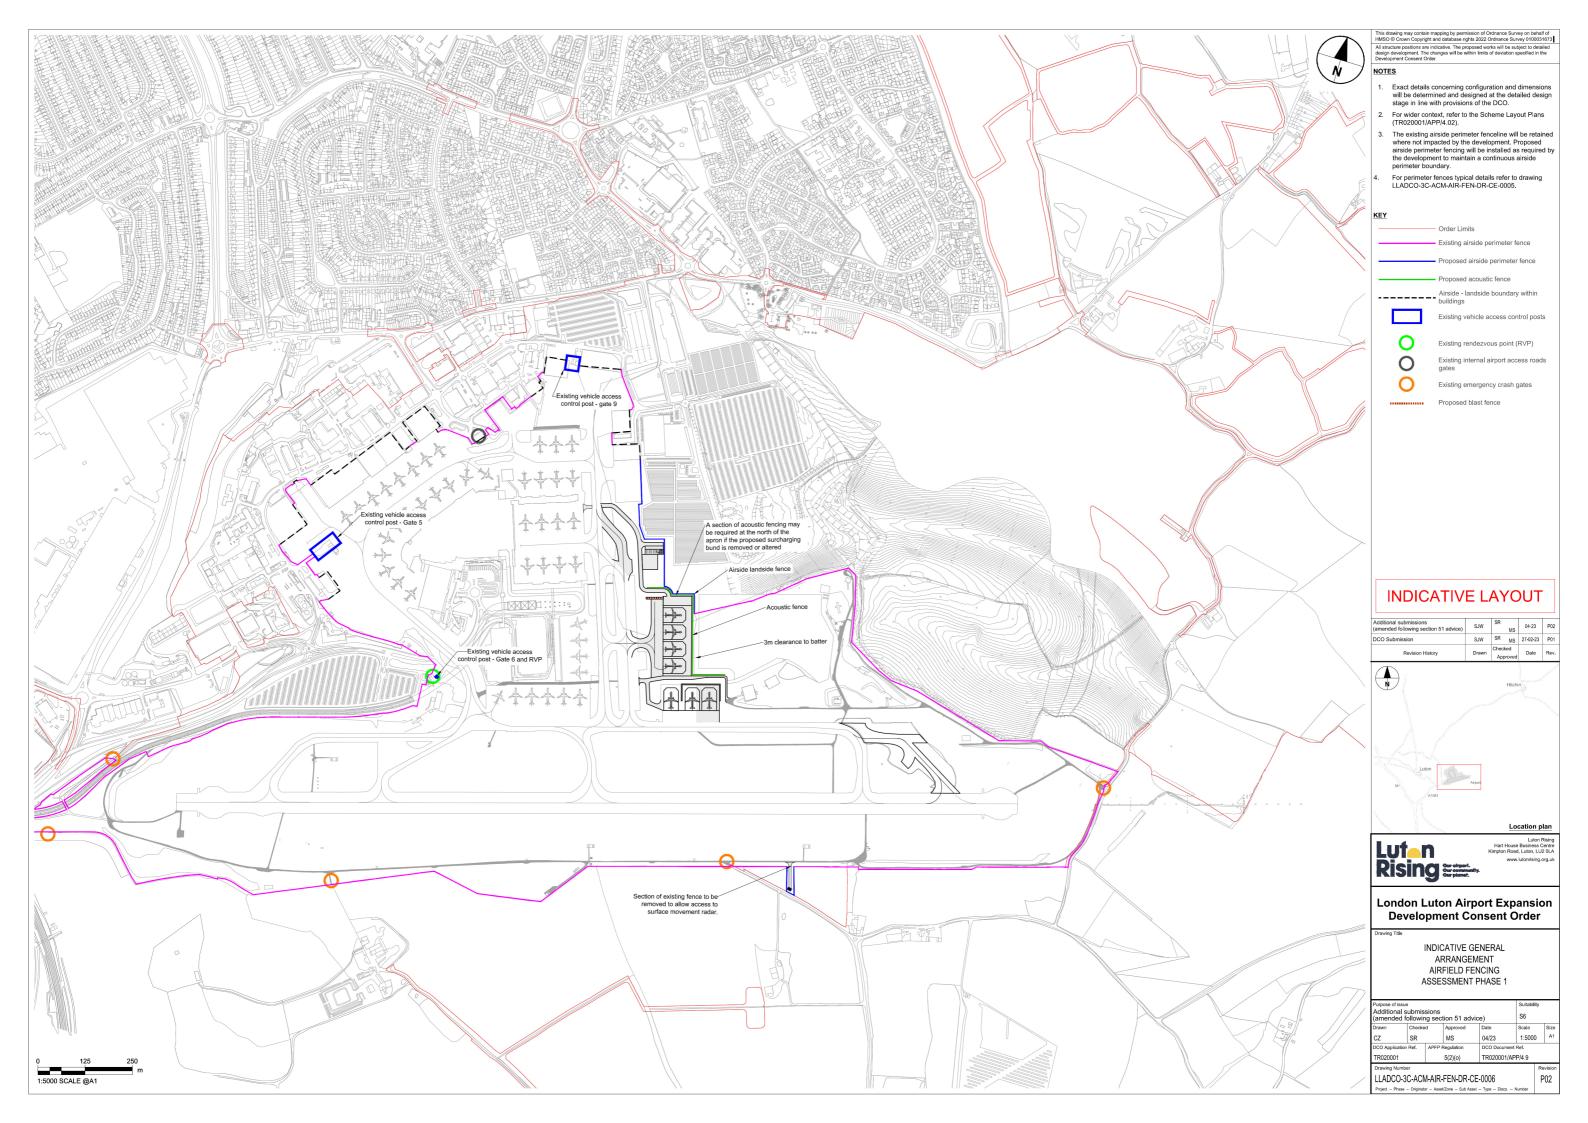

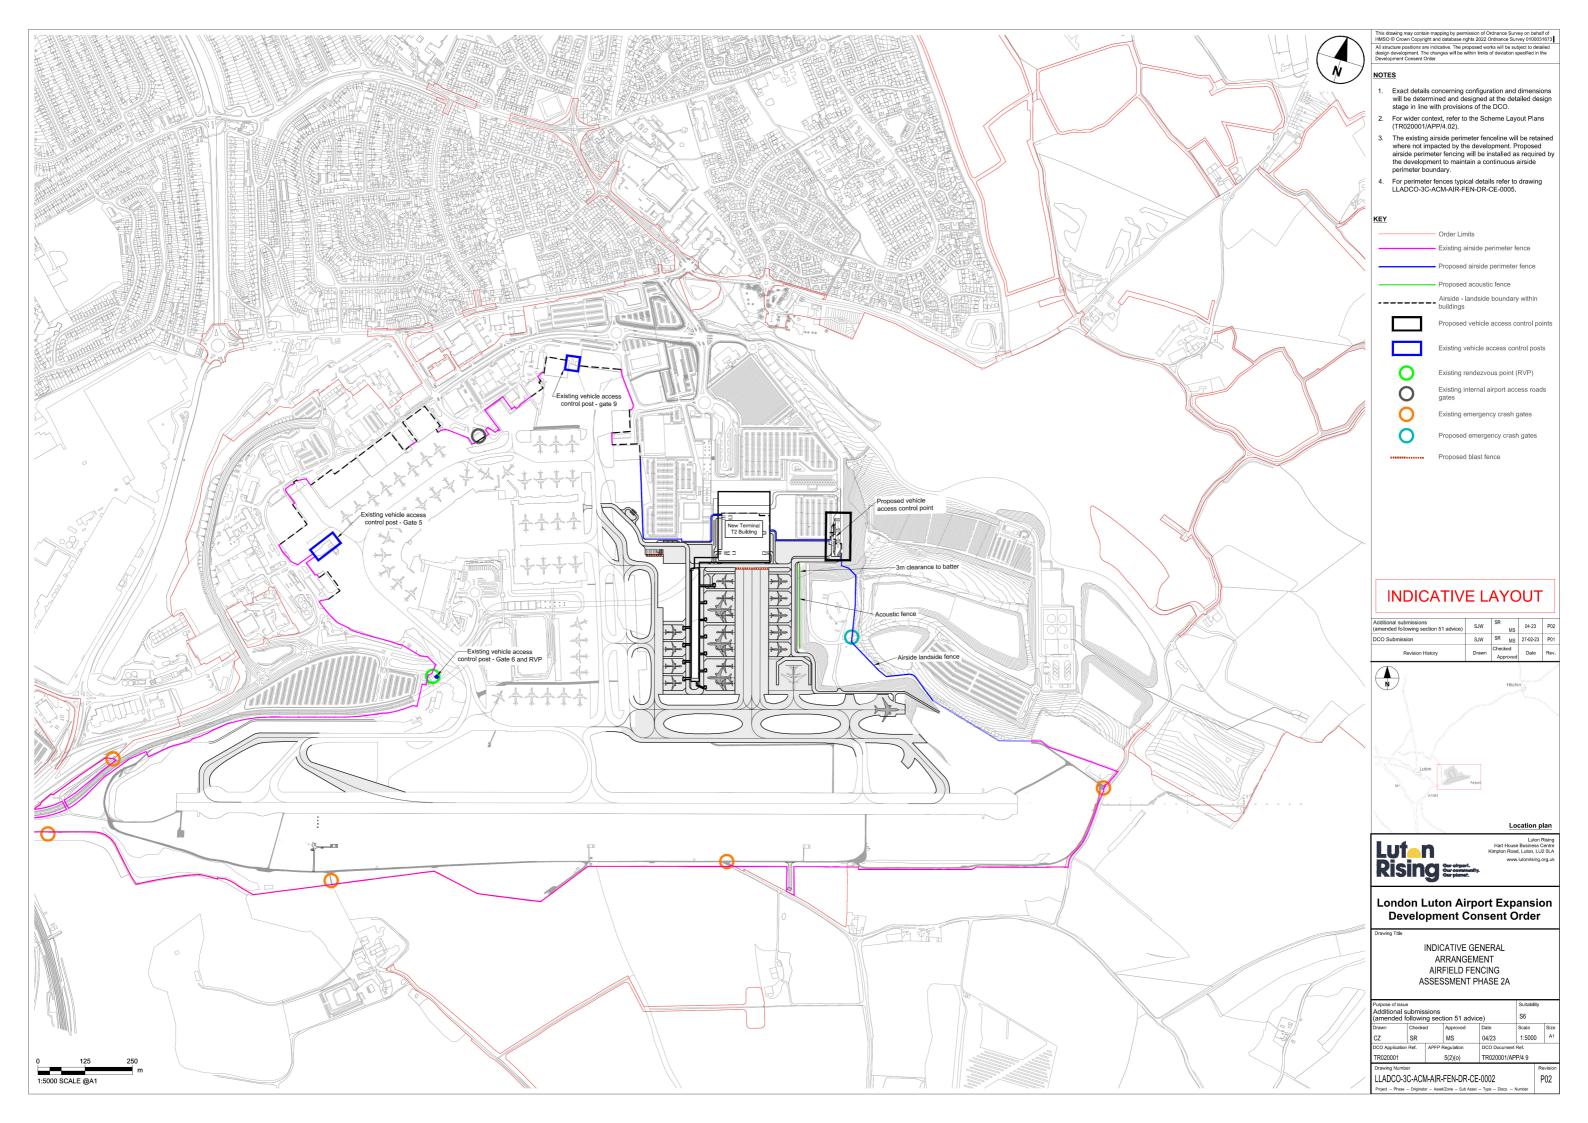

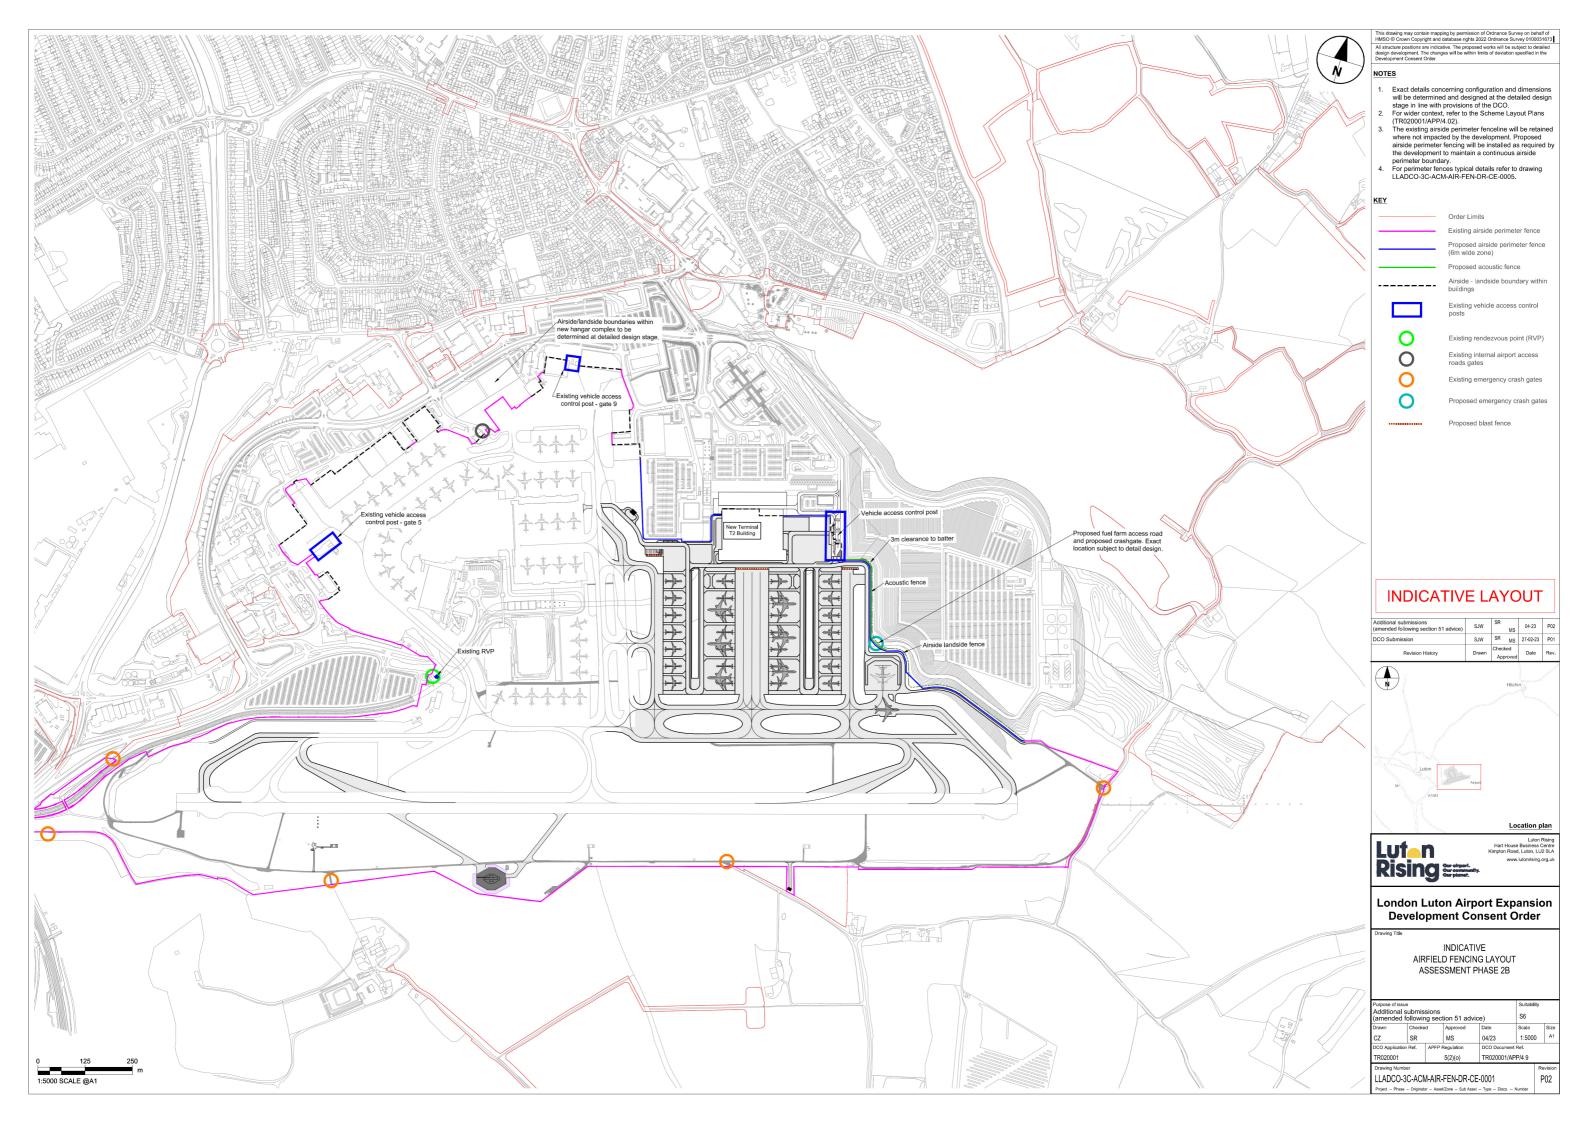

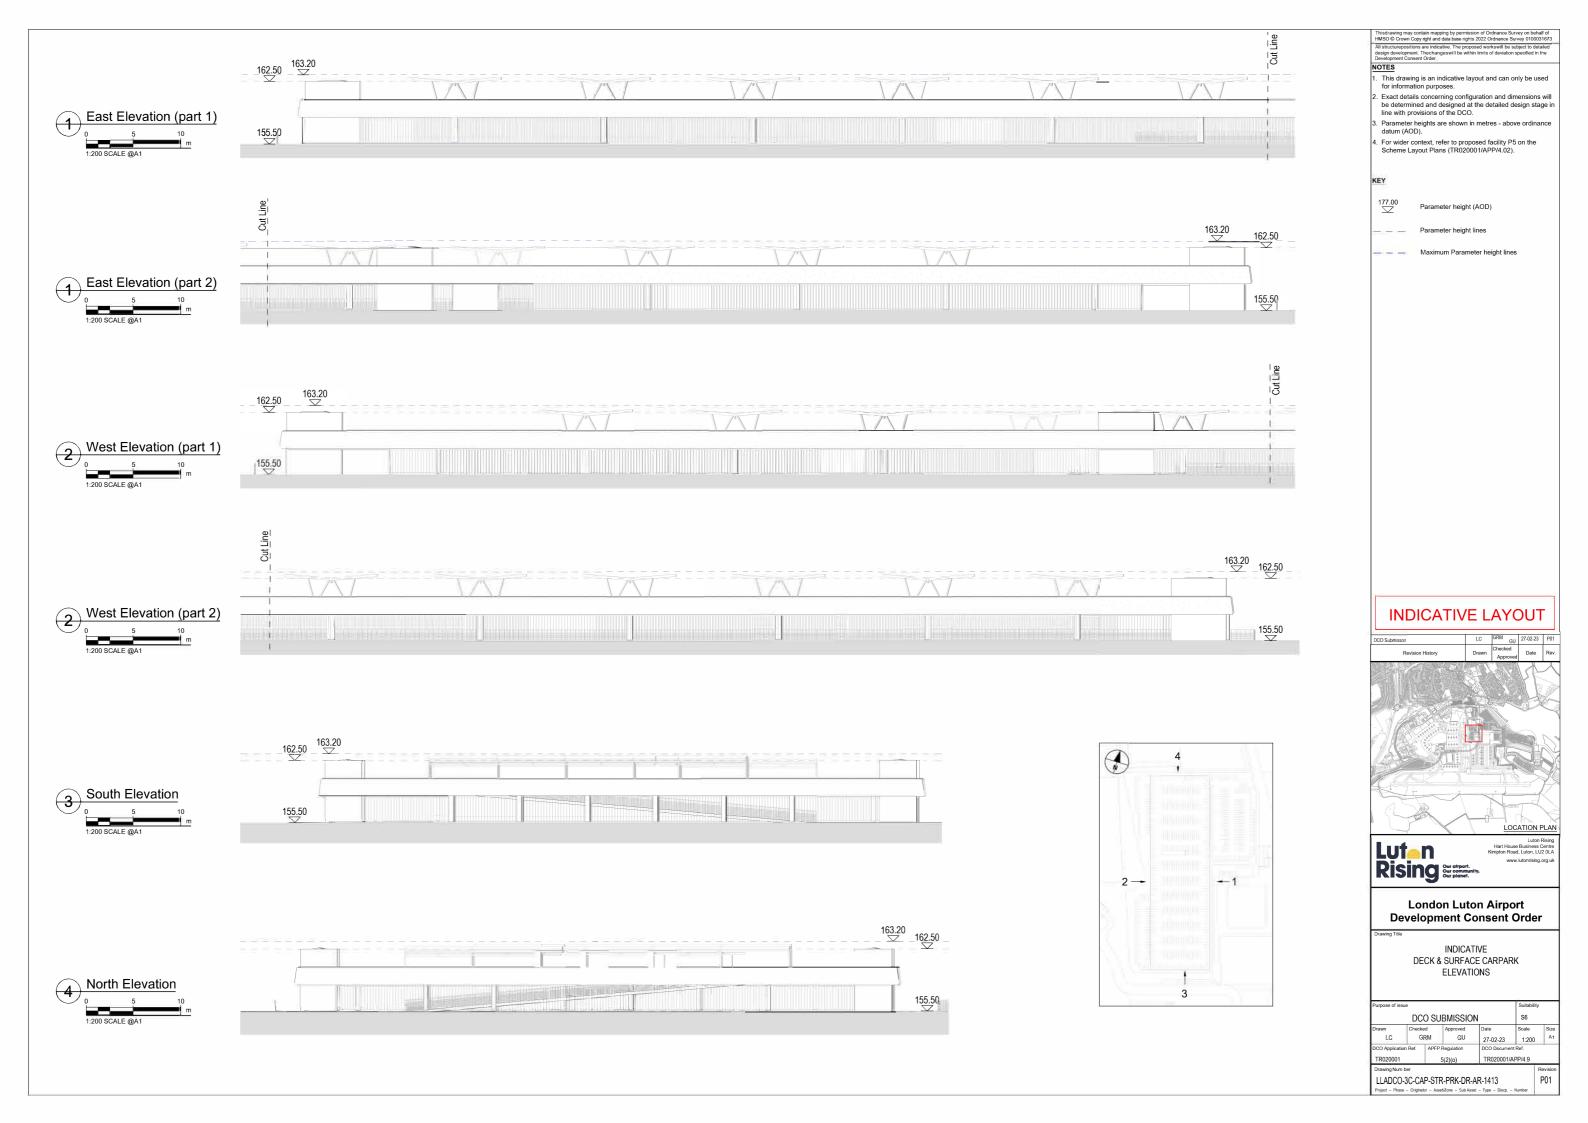

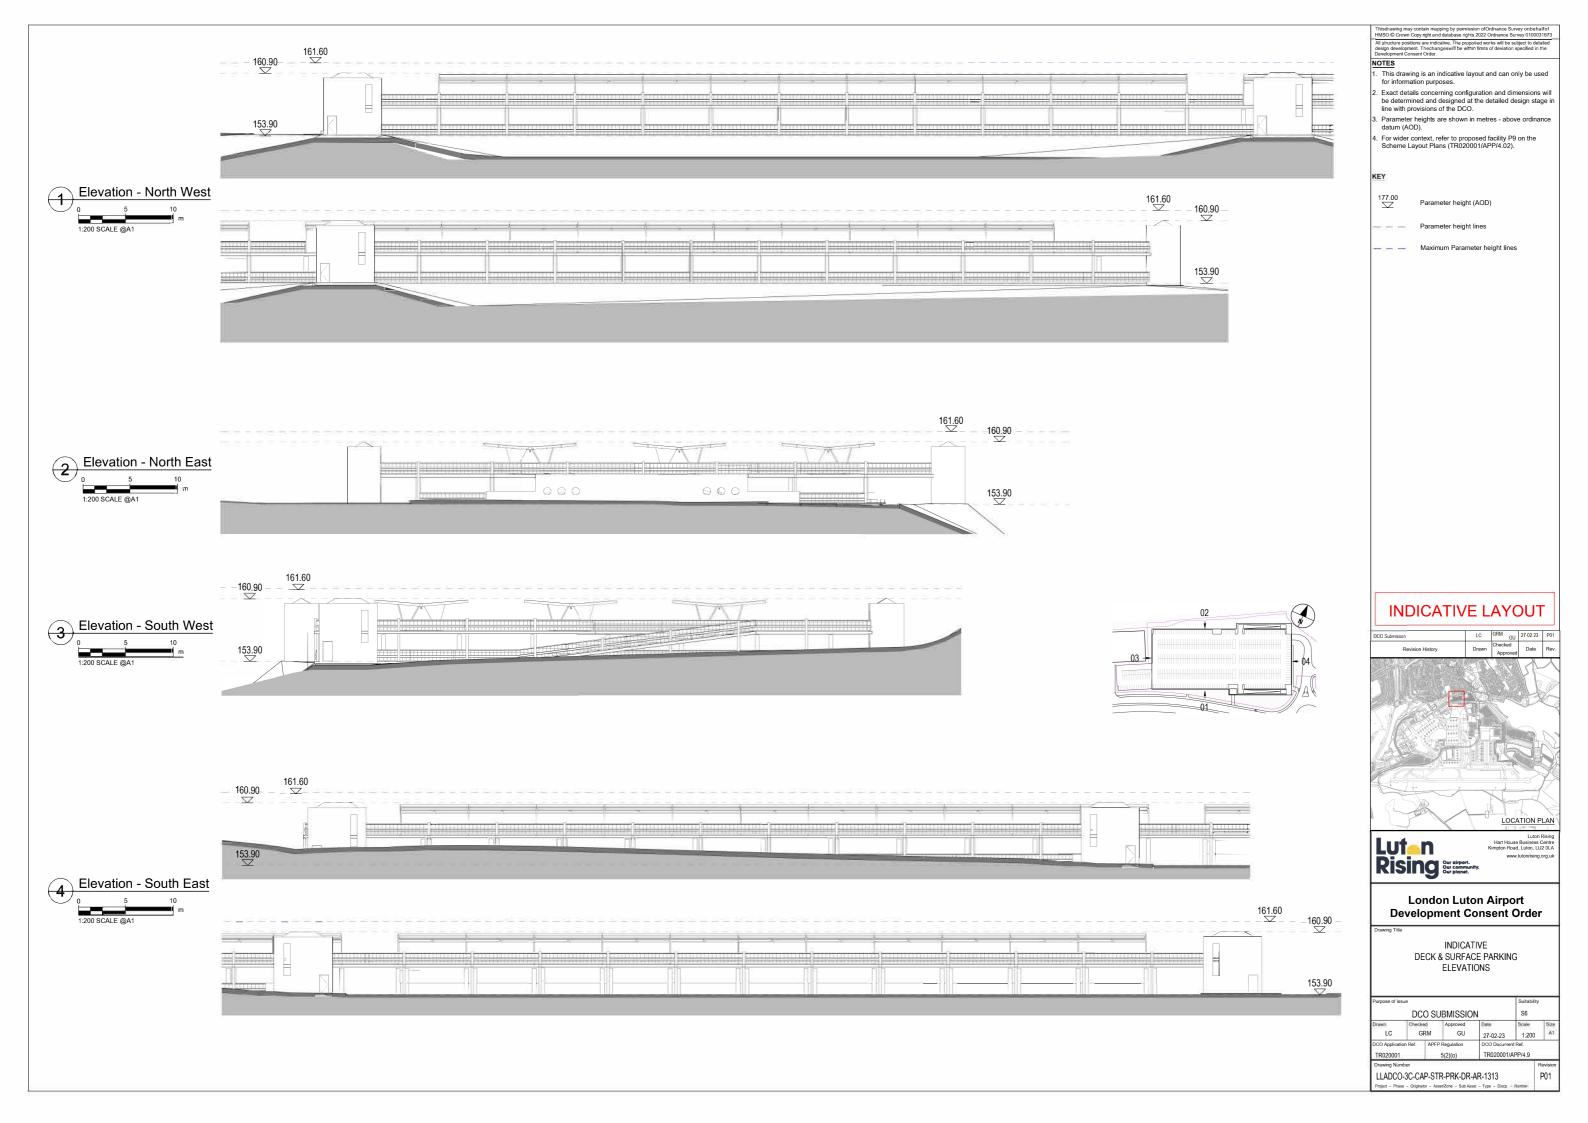



CARPORT STRUCTURE MANUFACTURER DEPENDENT MATERIAL TYPICALLY POWDER COATED OR GALVANISED STEEL

V-FRAME SINGLE ROW MONOPITCH SOLAR

V-FRAME DOUBLE ROW MONOPITCH SOLAR CARPORT PV PANELS And the sign of the state of

This drawing may contain mapping by permission of Ordnance Survey on behalf of HMSO © Crown Copyright and diatabes rights 2022 Ordnance Survey 0100031673. All structure positions are indicative. The proposed works will be subject to detailed design development. The changes will be within limits of deviation specified in the Development Consent Order.

NOTES

- This drawing is an indicative layout and can only be used for information purposes.
- Exact details concerning configuration and dimensions will be determined and designed at the detailed design stage in line with provisions of the DCO (including column and inverter configuration).
- All dimensions are in metres unless otherwise stated
 For wider context, refer to proposed facility P10 on the
- For wider context, refer to proposed facility P10 on the Scheme Layout Plans (TR020001/APP/4.02).
- A glint and glare assessment will be required at detailed design stage.





Proposed PV Panels



Indicative Car Parking Spaces

INDICATIVE LAYOUT

DCO Submisson	311	MS	21-02-23	FUI
Revision History	Drawn	Checked Approved	Date	Rev.
		7	1	1
				4
		7	~	
		15	\propto	
			7	X
				,
(1) (1) (1) (1) (1) (1) (1) (1) (1) (1)	35	27		
THAT		1	_	1



Luton Rising
Hart House Business Centre
Gimpton Road, Luton, LU2 0LA
www.lutonrising.org.uk

P01

London Luton Airport Development Consent Order

Drawing Titl

INDICATIVE GENERAL ARRANGEMENT SOLAR CAR PORT

Purpose of issi	Suitability					
	DCC) SUE	BMISSION		S6	
Drawn SW	Checke	d R	Approved MS	Date 27-02-23	Scale AS SHOWN	Size A1
DCO Application Ref. APF		FP Regulation 5(2)(o)	TR020001/A			

LLADCO-3C-ACM-INF-MSC-DR-AR-0001


1.25 2.5 1:50 SCALE @A1



This drawing may contain mapping by permission of Ordnance Survey on behalf of HMSO © Crown Copyright and database rights 2022 Ordnance Survey to the All structure positions are indicative. The proposed works will be subject to detailed design development. The changeswill be within limits of deviation specified in the Commonwealth of the co

OTES

- This drawing is an indicative layout and can only be used for information purposes.
- Exact details concerning configuration and dimensions will be determined and designed at the detailed design stage in line with provisions of the DCO.
- For wider context, refer to proposed facility P12 on the Scheme Layout Plans (TR020001/APP/4.02).

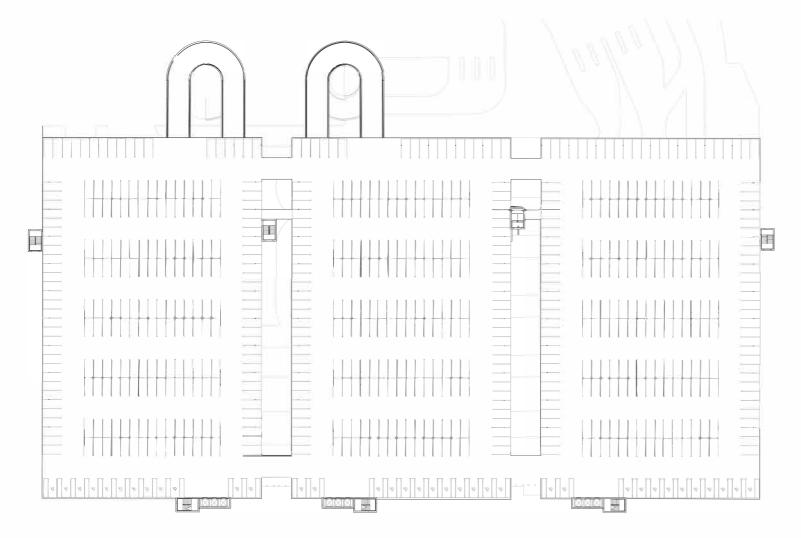

Typical Floor Plan - Multistorey Car Park

INDICATIVE LAYOUT

DCO Submisson	LC	GRM GU	27-02-23	P01
Revision History	Drawn	Checked Approved	Date	Rev
			11	\nearrow
			RE	\
100 1 Man 100 / 10				/
	***			7
The state of the s			T.	3
				H
	1	X		
		200		

LOCATION PLAN



Luton Rising Hart House Business Centre impton Road, Luton, LU2 0LA www.lutonrising.org.uk


London Luton Airport Development Consent Order

Draw


INDICATIVE FORECOURT MULTISTOREY CAR PARK TYPICAL PLAN


Purpose of is	Suitabili	,				
	S6					
Drawn	Check	ed	Approved	Date	Scale	Size
LC	0	RM	GU	27-02-23	1:500	A1
DCO Application Ref. Al		APFI	APFP Regulation DCO Documen		nt Ref.	
TR020001	020001 5(2)(o) TR020001/A			APP/4.9		
Drawing Nur	mber					Revision
LLADCO-3C-CAP-STR-PRK-DR-AR-1208						P01




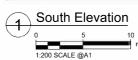



***	170.55	169.00
		153.50

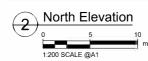

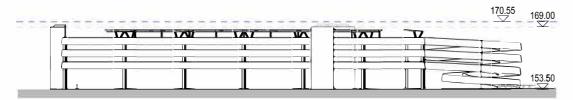

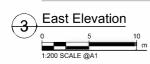

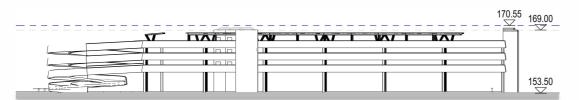

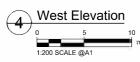

- This drawing is an indicative layout and can only be used for information purposes.
- Exact details concerning configuration and dimensions will be determined and designed at the detailed design stage in line with provisions of the DCO.
- Parameter heights are shown in metres above of datum (AOD).
- . For wider context, refer to proposed facility P12 on the Scheme Layout Plans (TR020001/APP/4.02).

Parameter height (AOD)

Parameter height lines

— Maximum Parameter height lines

INDICATIVE LAYOUT


DCO Submisson	LC	GRM GU	27-02-23	P01
Revision History	Drawn	Checked Approved	Date	Rev.
			1	X
			YE	
			1	
				2
		50		
7			T.	3
		- 1		F
			T	
	1	R I	1	1

Lutan Rising Our airport. Our community. Our planet.

London Luton Airport Development Consent Order


INDICATIVE MULTISTOREY CAR PARK ELEVATIONS


	DC	N	S6			
Drawn LC	Check	ed RM	Approved GU	Date 27-02-23	Scale 1:500	Size A1
DCO Application Ref. APFP Regulation TR020001 5(2)(0)				TR020001/		
Drawing Number LLADCO-3C-CAP-STR-PRK-DR-AR-1210						

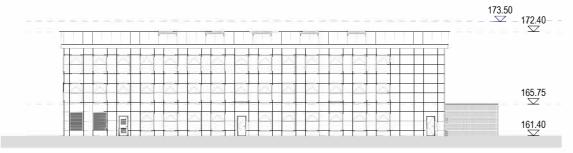







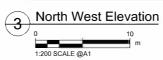

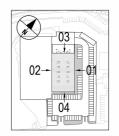

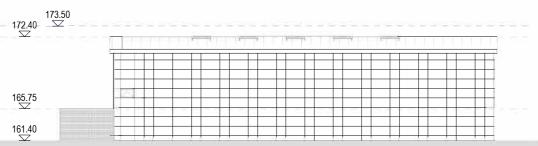



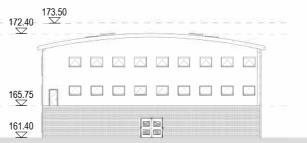




- 1. This drawing is an indicative layout and can only be used for information purposes.
 2. Exact details concerning configuration and dimensions will be determined and designed at the detailed design stage in line with provisions of the DCO.
- Parameter heights are shown in metres above ordinanc datum (AOD).
- For wider context, refer to proposed facility no.13 on the Scheme Layout Plans (TR020001/APP/4.02).

KEY

Parameter height (AOD)

INDICATIVE LAYOUT

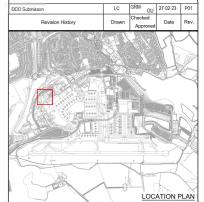



P01

London Luton Airport Development Consent Order

INDICATIVE POLICE STATION ELEVATIONS

Purpose of is	ssue				Suitability	
l	DC	o su	BMISSIO	N	S6	
Drawn LC	Checke	CDM CH		Date 27-02-23	1:200	202
DCO Application Ref APFP F		Regulation	DCO Docume	nt Ref		
TR020001 5		5(2)(0)	TR020001/	APP/4.9		

LLADCO-3C-CAP-STR-OFC-DR-AR-1342

