

# Lower Thames Crossing

2.9 Engineering Drawings and Sections Volume E (South Portal and Tilbury Plan and Profiles) (Clean version)

APFP Regulation 5(2)(o) and 6(2)

Infrastructure Planning (Applications: Prescribed Forms and Procedure) Regulations 2009

Volume 2

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### **Revision history**

Version	Date	Submitted at
1.0	31 October 2022	DCO Application
2.0	24 August 2023	Deadline 3
3.0	19 September 2023	Deadline 4
4.0	17 November 2023	Deadline 7
5.0	11 December 2023	Deadline 9

### **Lower Thames Crossing**

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### 1 Introduction

- 1.1.1 This document is submitted to the Planning Inspectorate on behalf of the Secretary of State in relation to an application made by National Highways (the Applicant) under section 37 of the Planning Act 2008.
- 1.1.2 The application is for the grant of development consent for the A122 Lower Thames Crossing. Should development consent be granted, the draft A122 (Lower Thames Crossing) Development Consent Order (Application Document 3.1) (the draft Order) will be made by the Secretary of State (subject to any modifications considered appropriate).
- 1.1.3 This document comprises part of the suite of application documentation and is included in the application to comply with Regulations 5(2)(o) and 6(2) of the Infrastructure Planning (Applications: Prescribed Forms and Procedure) Regulations 2009 (the 2009 Regulations), which require:
  - a. 5(2)(o) 'any other plans, drawings and sections necessary to describe the proposals for which development consent is sought, showing details of design, external appearance, and the preferred layout of buildings or structures, drainage, surface water management, means of vehicular and pedestrian access, any car parking to be provided, and means of landscaping.
  - b. 6(2) If the application is for highway related development or for the construction or alteration of a railway, it must be accompanied by section drawings to suitable horizontal and vertical scales, which show, by reference to Ordnance Survey or Chart datum:
  - c. the levels of the proposed works, including in particular and where relevant:
    - i. ground levels;
    - ii. the height of every proposed bridge, viaduct, aqueduct, embankment and elevated guideway;
    - iii. the depth of every proposed cutting and tunnel;
    - iv. the levels of the bed of any tidal waters or inland waterway in which it is proposed that any works should be situated;
    - the height of every structure or device (including a cable, but not catenary and related equipment) intended to be erected above, on or below the surface of, or on or beneath the bed of tidal waters or an inland waterway; and
    - vi. drainage outfall details for highways;

- 1.1.4 The purpose of the Engineering Drawings and Sections Plans is to show the key features of the Project for which development consent is sought. The set shows details of the proposed road plan and longitudinal profile including the ground levels, the height of certain structures and embankments, the depth of proposed cuttings and tunnel, and the indicative location and level of drainage outfall features.
- 1.1.6 For each section, the Applicant has provided a key plan of the corresponding geographical area that provides the sheet number and a description of the associated road works to help with its identification within the set. It is important to note that the plans are numbered in each of the aforementioned sections and that the numbering system does not apply to the set as whole.
- 1.1.7 The key plans use a smaller scale than that prescribed in Regulation 5(3) of the 2009 Regulations so that the Project or the section of the Project can be represented in a single sheet plan. The scales in the key plans vary from 1:50000 to 1:5000. The remaining sheets in the set containing the plan and profiles and the cross sections have been prepared at a horizontal scale of 1:2500 and a vertical scale of 1:250.
- 1.1.8 As this document has been informed by and is part of the application documentation it should be read alongside the other application documents. In particular, the plans should be read alongside the Works Plans (Application Document 2.6) and Schedule 1 of the draft Order (Application Document 3.1). Article 6 of the draft Order should also be referred to as it provides the reference points for the application of the upwards and downwards vertical limits of deviation applicable to the elements of the works.
- 1.1.9 Numbered works shown in the Engineering Drawings and Sections Plans are consistent with the information presented in the Works Plans (Application Document 2.6) and Schedule 1 of the draft Order (Application Document 3.1). Further details of the proposed bridges and tunnel structures are provided in the Structures Plans (Application Document 2.13).
- 1.1.10 The information shown on the plans is commensurate with the preliminary design status of the Project. The detailed design will be in accordance with the extent of the defined limits of deviation provided and any approval required under the DCO requirements set out in Schedule 2 of the draft Order (Application Document 3.1).
- 1.1.11 The lateral limits of deviation for the works are shown in the Works Plans (Application Document 2.6) and in the Tunnel Limits of Deviation (Application Document 2.15); article 6 of the draft Order establishes the vertical limits of deviation. Further information about the limits of deviation is provided in the Introduction to the Application (Application Document 1.3).
- 1.1.12 The Engineering Drawings and Sections show the Order Limits. In this plan set, 'the Order Limits' mean the limits of lands to be acquired or used, permanently or temporarily, within which the authorised development may be carried out (see article 2 of the draft Order (Application Document 3.1)).
- 1.1.13 To ensure that the file size of this document does not exceed the 50MB limit prescribed by the Planning Inspectorate, the set has been split into eight volumes:

- a. Volume A contains the A122 Lower Thames Crossing Plan and Profiles;
- b. Volume B contains the A122 Lower Thames Crossing Cross Sections;
- c. Volume C contains the A2/M2 Plan and Profiles and A2 Mainline Plan and Profiles;
- d. Volume D contains the A122 Lower Thames Crossing/A2 Junction Plan and Profiles;
- e. Volume E contains the South Portal Plan and Profiles and Tilbury Plan and Profiles;
- f. Volume F contains the A13 Junction Plan and Profile;
- g. Volume G contains the A122 Lower Thames Crossing/M25 Junction Plan; and
- h. Volume H contains the Overhead Diversion Route and Pylon general arrangements.
- 1.1.14 These plans have been updated at Deadline 1 to address minor drafting inaccuracies.
- 1.1.15 These plans have been updated for Deadline 3 to include the minor amendments as advised by the Examining Authority in Rule 9 [PD-022].
- 1.1.16 These plans have been updated for Deadline 4 to include the proposed changes MRC01, MRC02 and MRC03 following the procedural decision made by the Examining Authority [PD-031].
- 1.1.17 These plans have been updated for Deadline 7 to include the proposed amendment EA07, as detailed in Deadline 5 cover letter [<u>REP5-001</u>].
- 1.1.18 These plans have been updated for Deadline 9 to include all agreed proposed changes and amendments throughout Examination.

# 2 Schedule of Plans included in this application document

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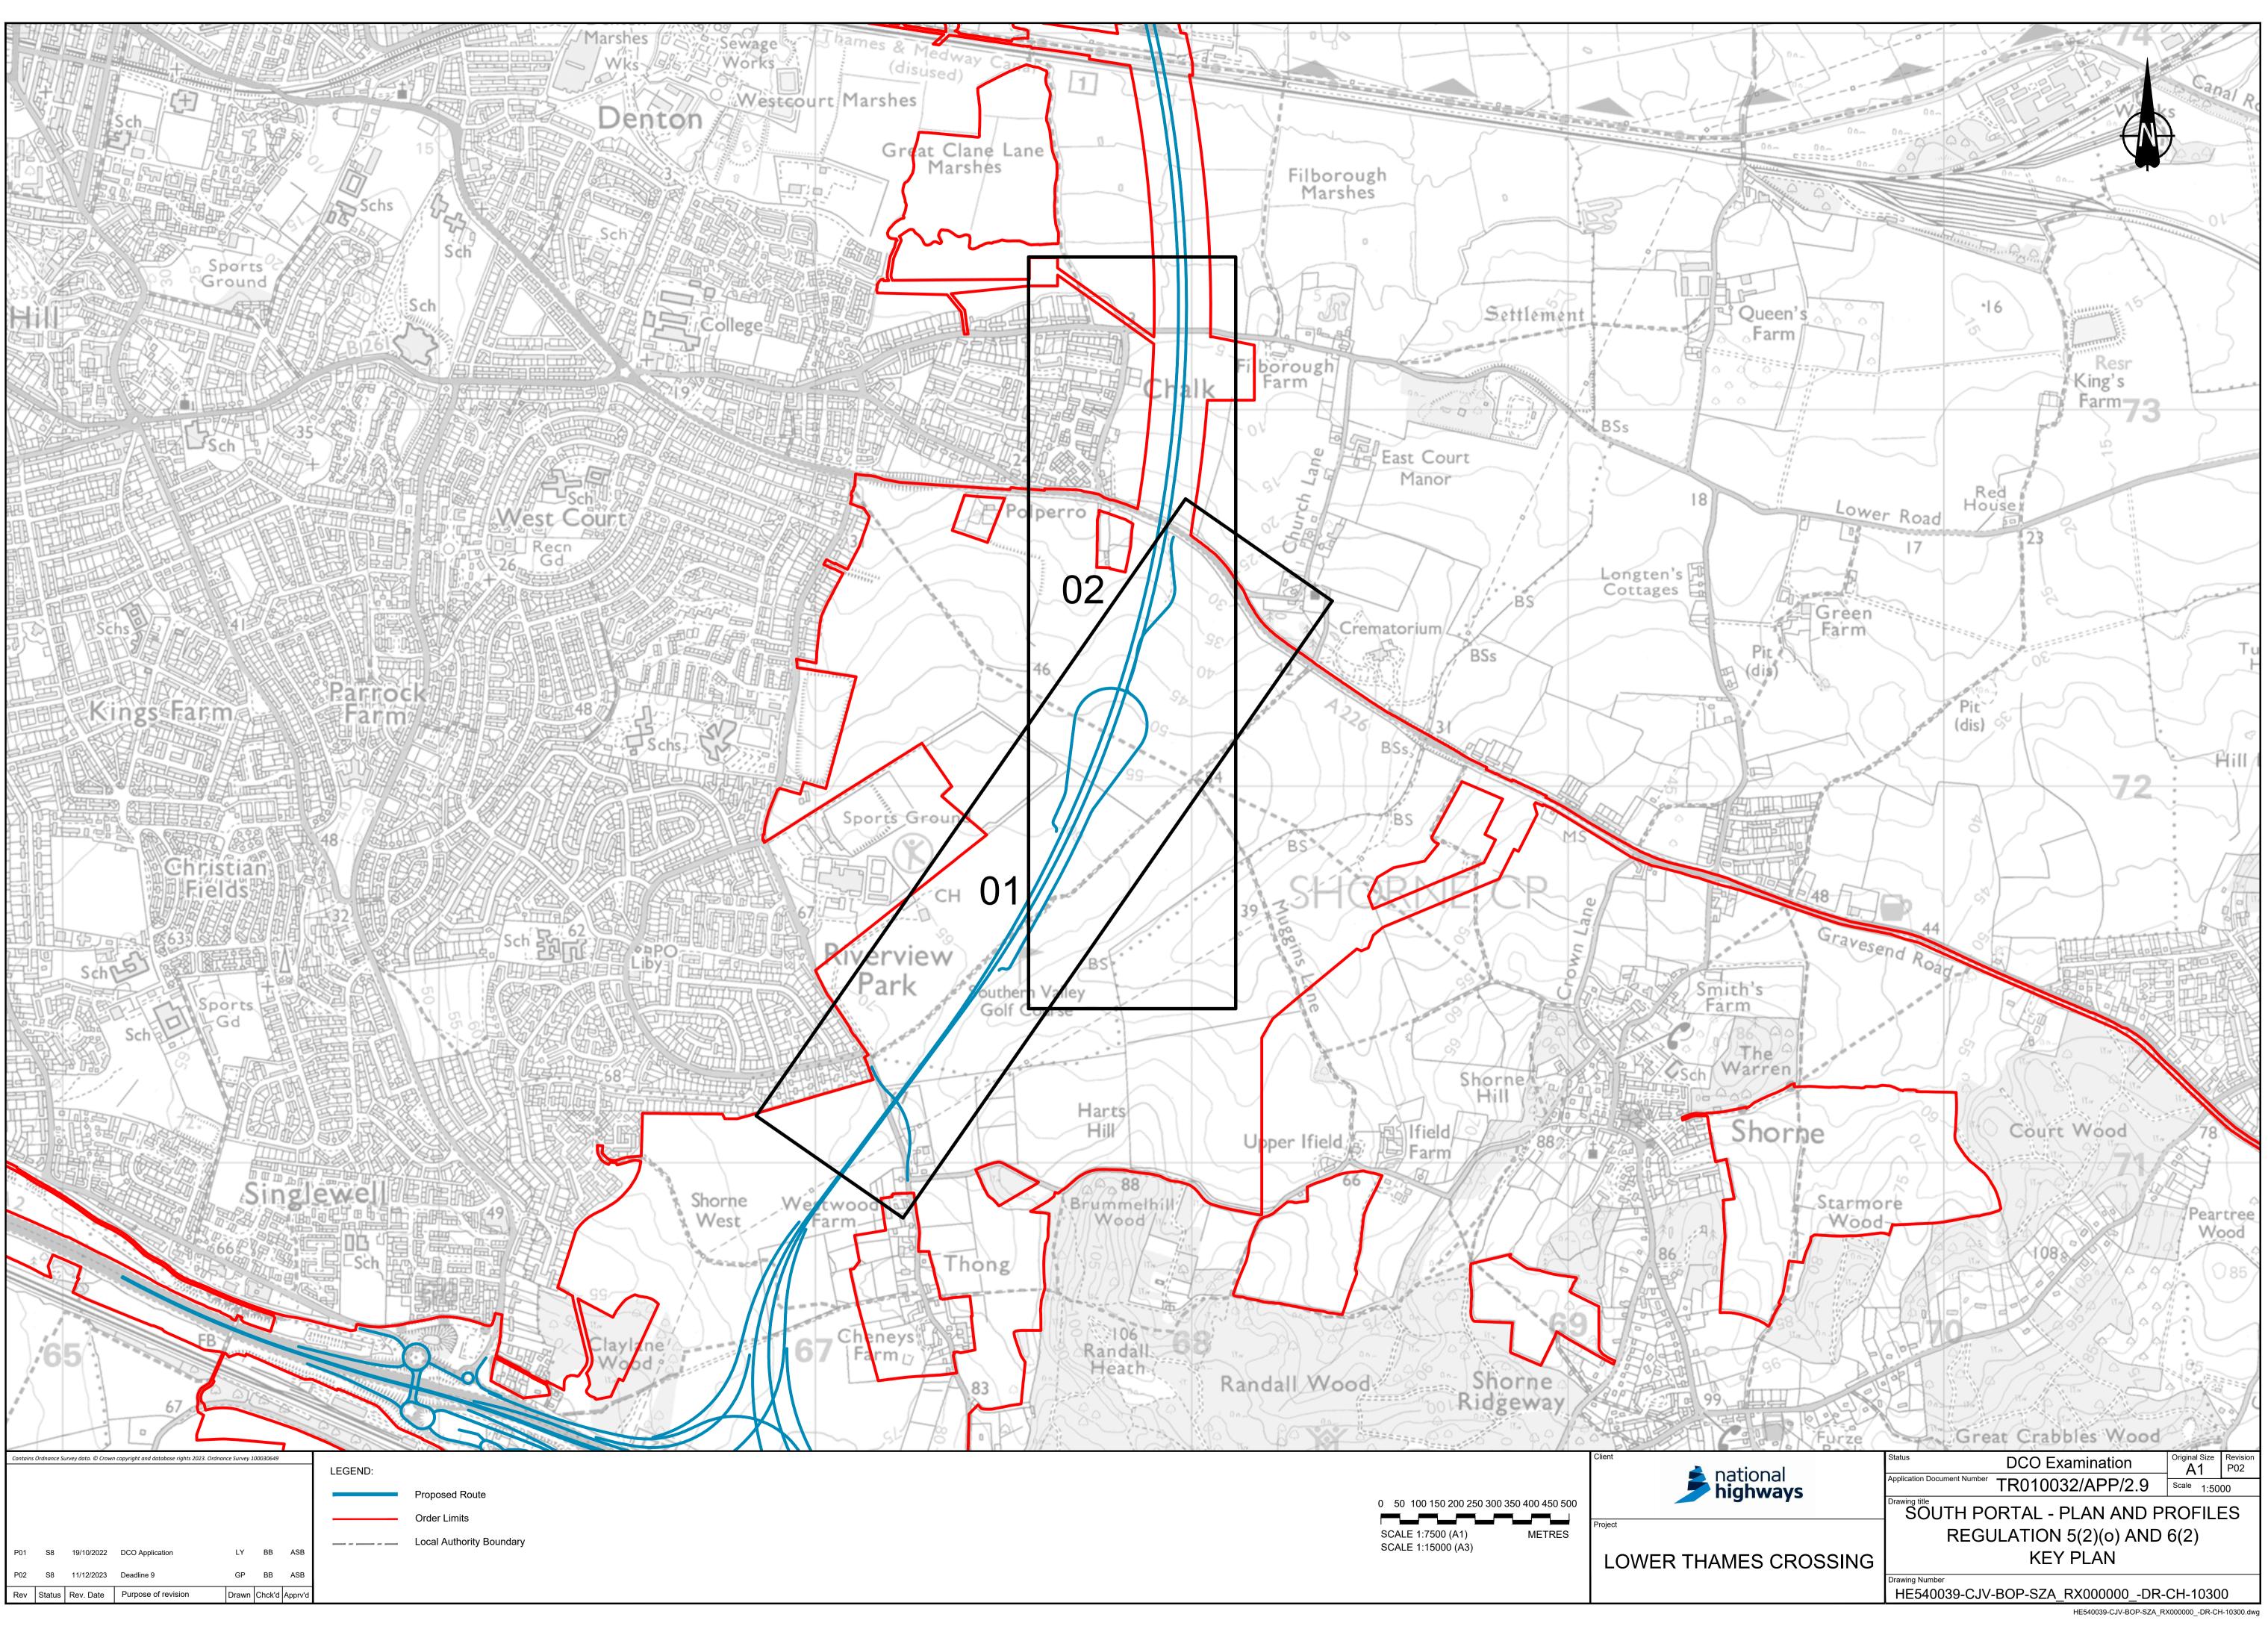
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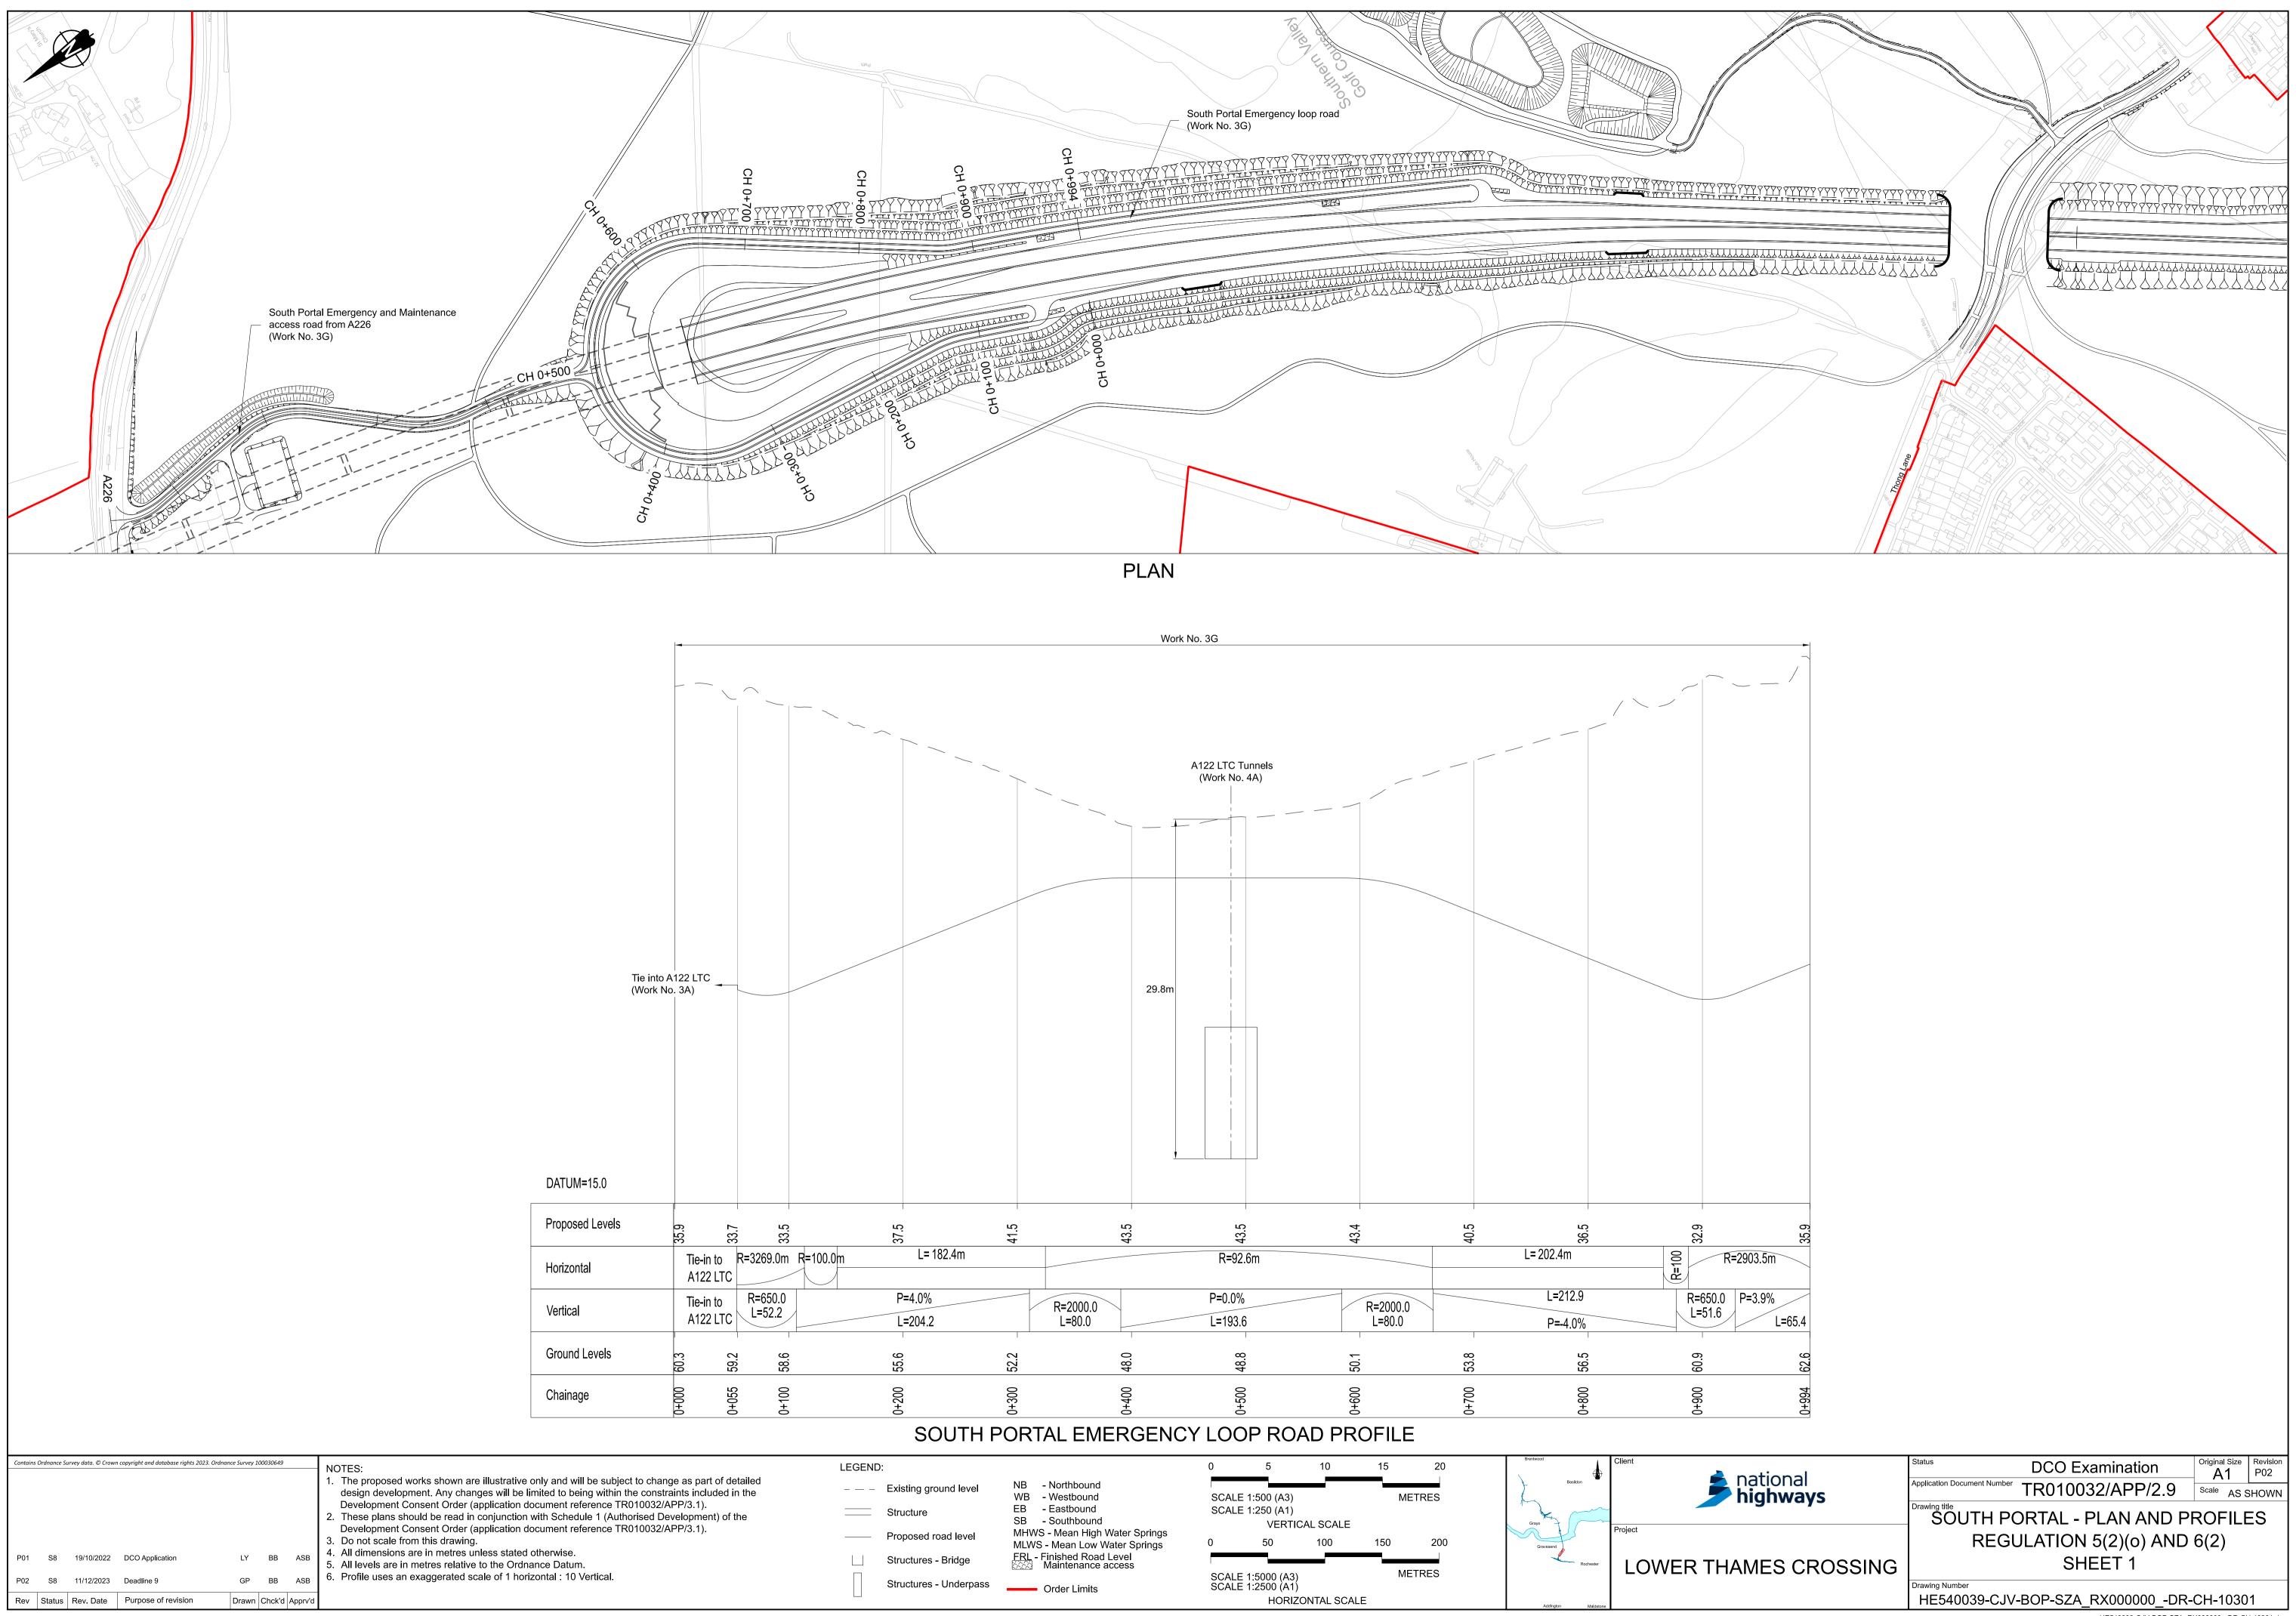
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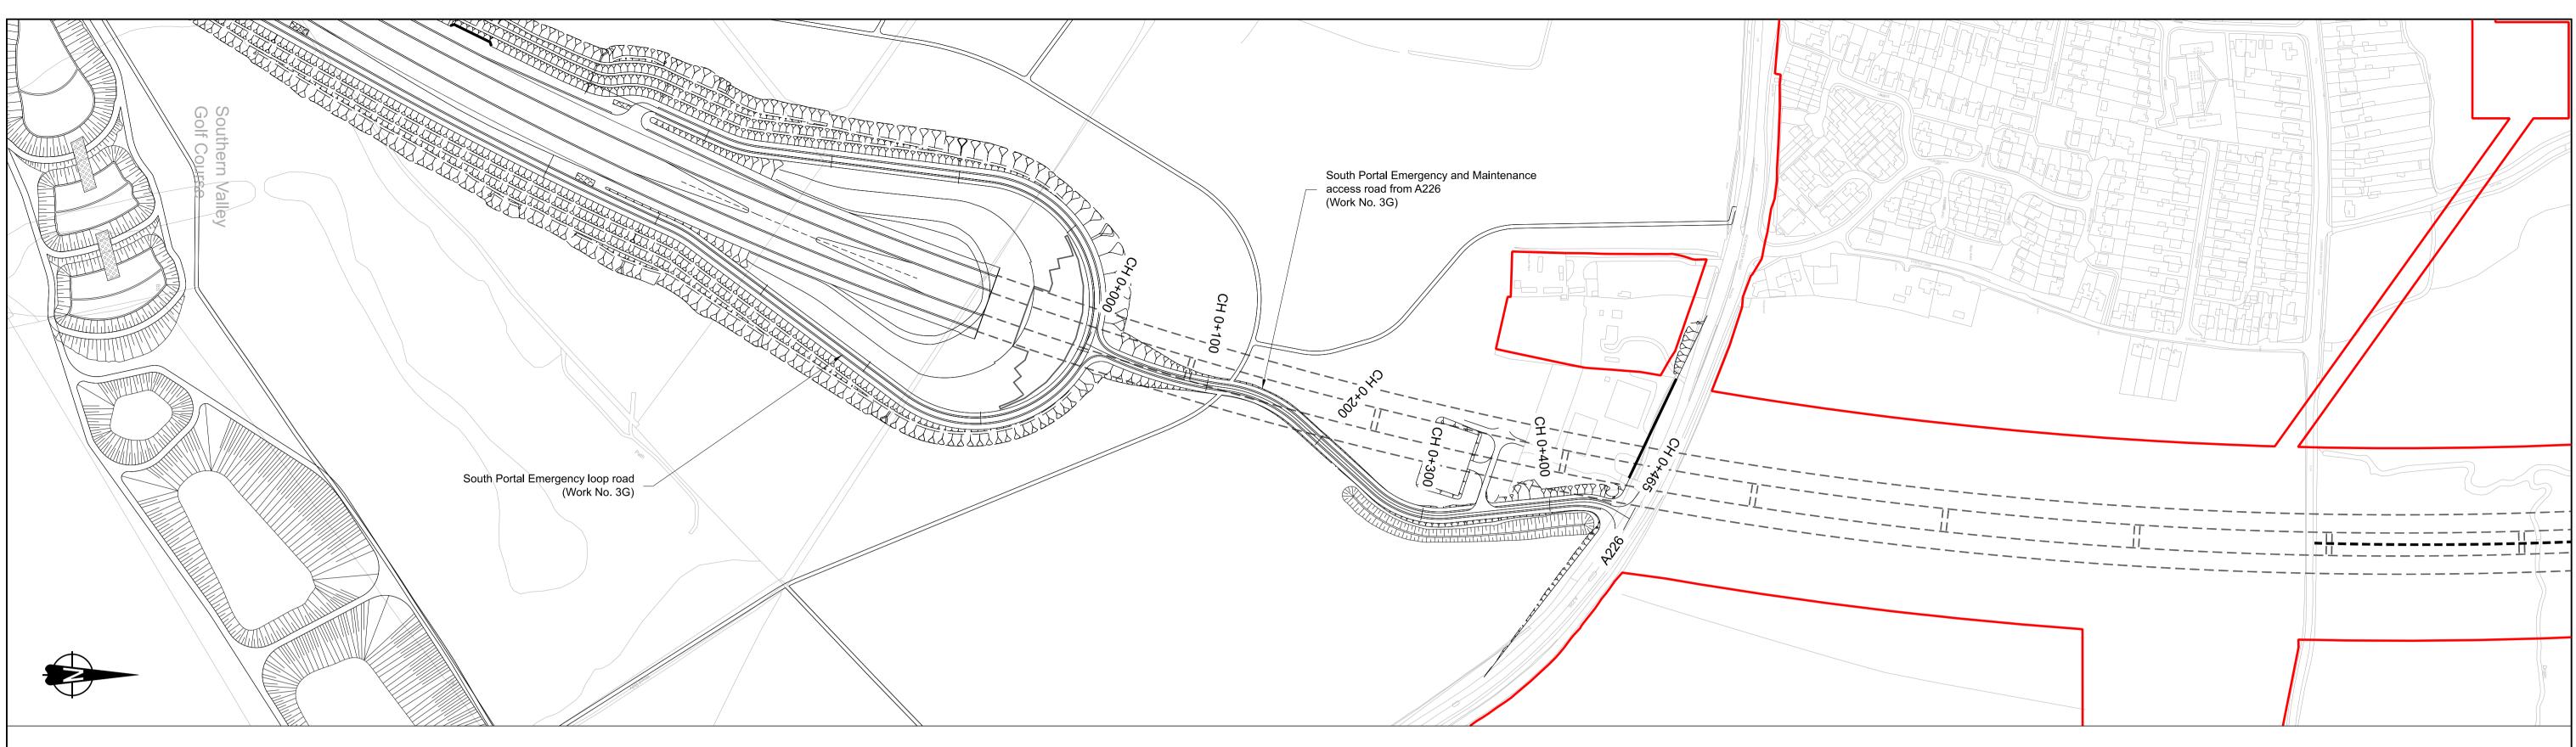
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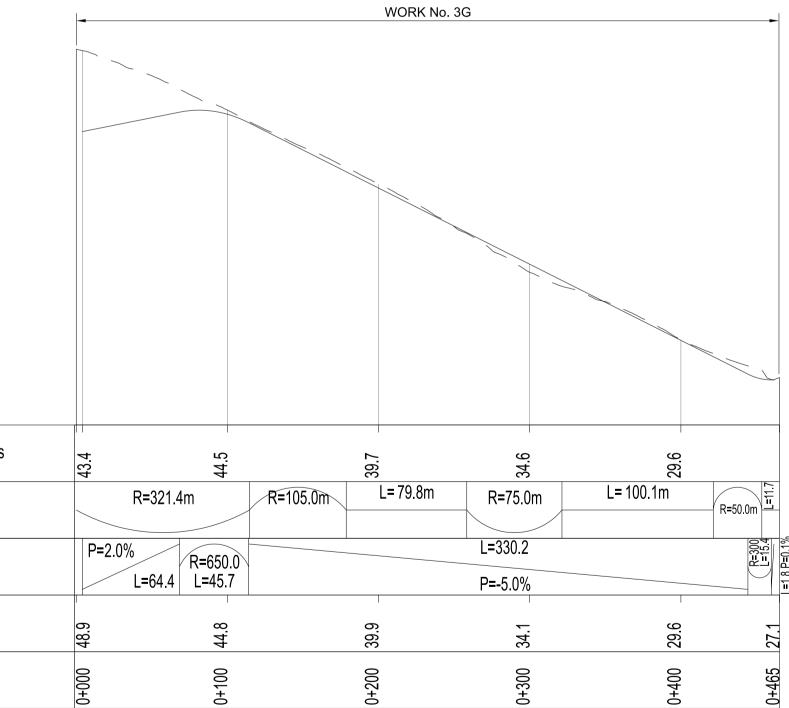
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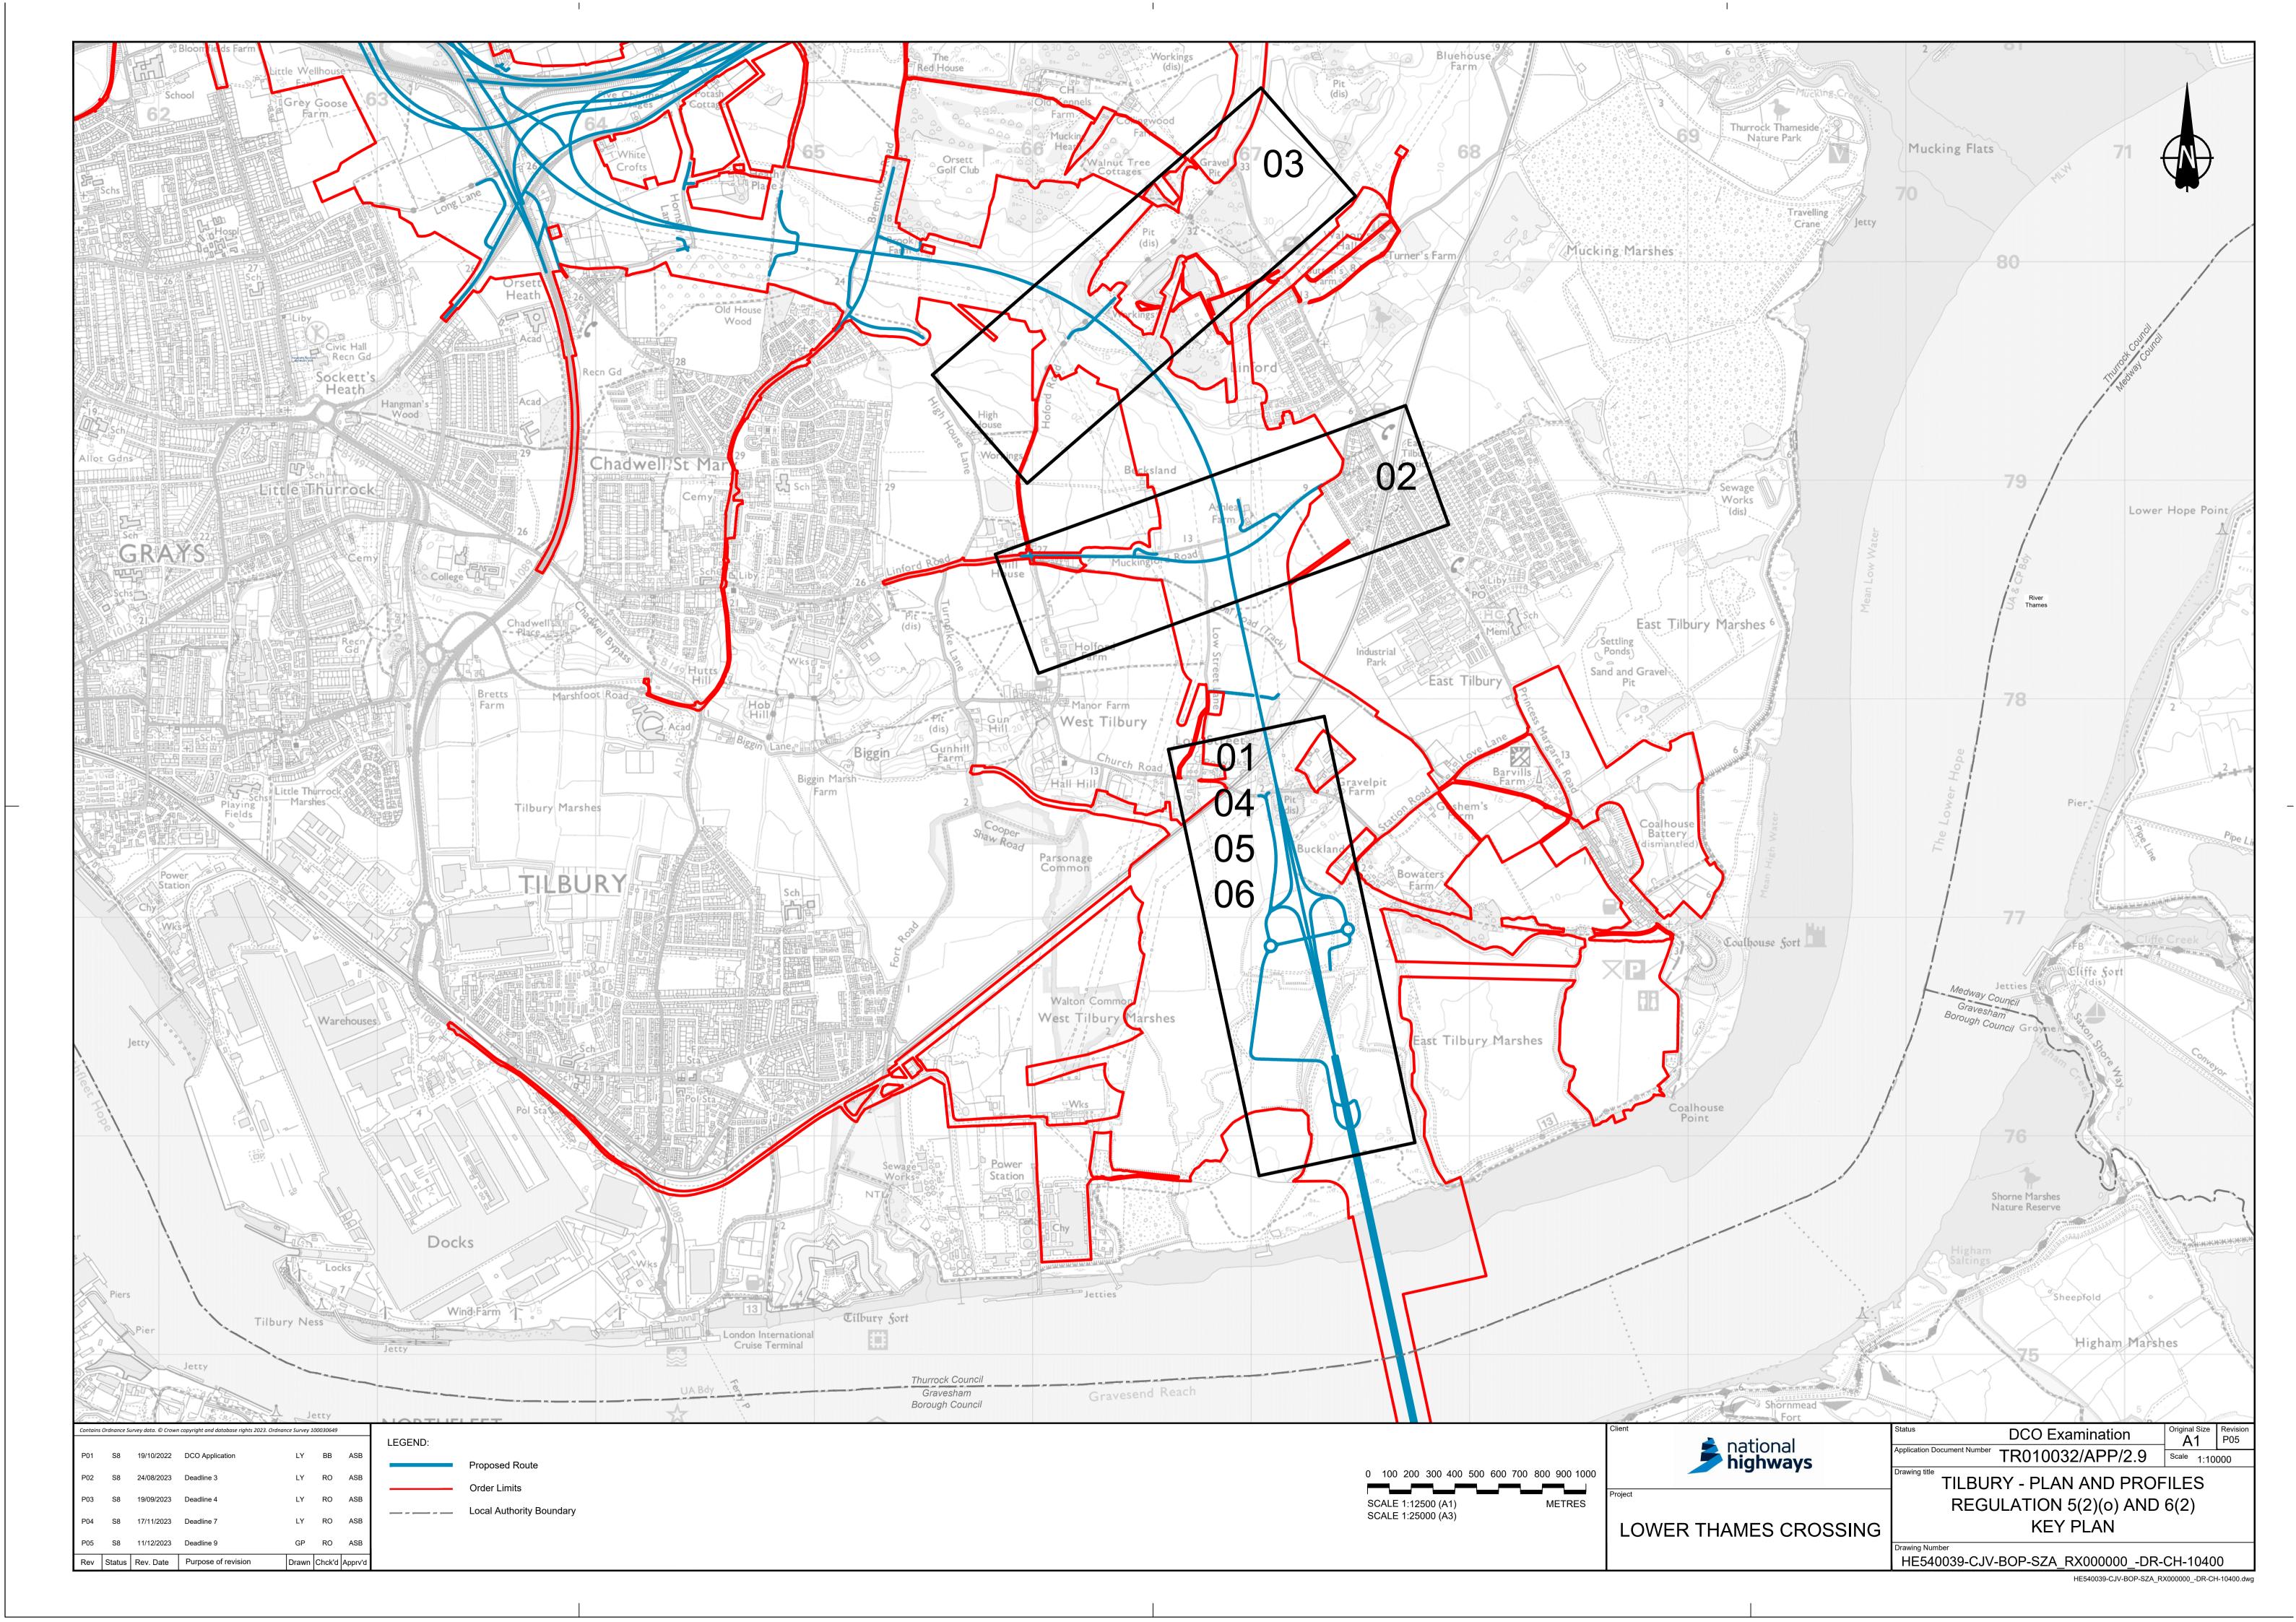
# SOUTH PORTAL EMERGENCY AND MAINTENANCE ACCESS ROAD TO A226 PROFILE


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P01 P02 Rev	S8 S8 Status	19/10/2022 11/12/2023 Rev. Date	DCO Application Deadline 9 Purpose of revision	LY GP Drawn	BB BB Chck'd	ASB ASB	<ol> <li>The proposed works shown are illustrative only and will be subject to change as part of detailed design development. Any changes will be limited to being within the constraints included in the Development Consent Order (application document reference TR010032/APP/3.1).</li> <li>These plans should be read in conjunction with Schedule 1 (Authorised Development) of the Development Consent Order (application document reference TR010032/APP/3.1).</li> <li>Do not scale from this drawing.</li> <li>All dimensions are in metres unless stated otherwise.</li> <li>All levels are in metres relative to the Ordnance Datum.</li> <li>Profile uses an exaggerated scale of 1 horizontal : 10 Vertical.</li> </ol>	-

PLAN




LEGEND:		0 5 10	15 20	Brentwood	Client	Status DCO Examination	۲ Original Size Revision A1 P02
– – – Existing ground level	NB - Northbound WB - Westbound	SCALE 1:500 (A3)	METRES	Basildon	national	Application Document Number TR010032/APP/2	
Structure	EB - Eastbound SB - Southbound	SCALE 1:250 (A1) VERTICAL SCALE		Grays		SOUTH PORTAL - PLAN AN	ND PROFILES
Proposed road level	MHWS - Mean High Water Springs MLWS - Mean Low Water Springs	0 50 100	150 200	Gravesend	Project	REGULATION 5(2)(o)	AND 6(2)
Structures - Bridge	FRL - Finished Road Level	SCALE 1:5000 (A3)	METRES	Rochester	LOWER THAMES CROSSING	SHEET 2	
Structures - Underpass	Order Limits	SCALE 1:25000 (A3) SCALE 1:2500 (A1) HORIZONTAL SCAL		Addington Maldstone		Drawing Number HE540039-CJV-BOP-SZA_RX000000	DR-CH-10302
						HE540039-CJV-	



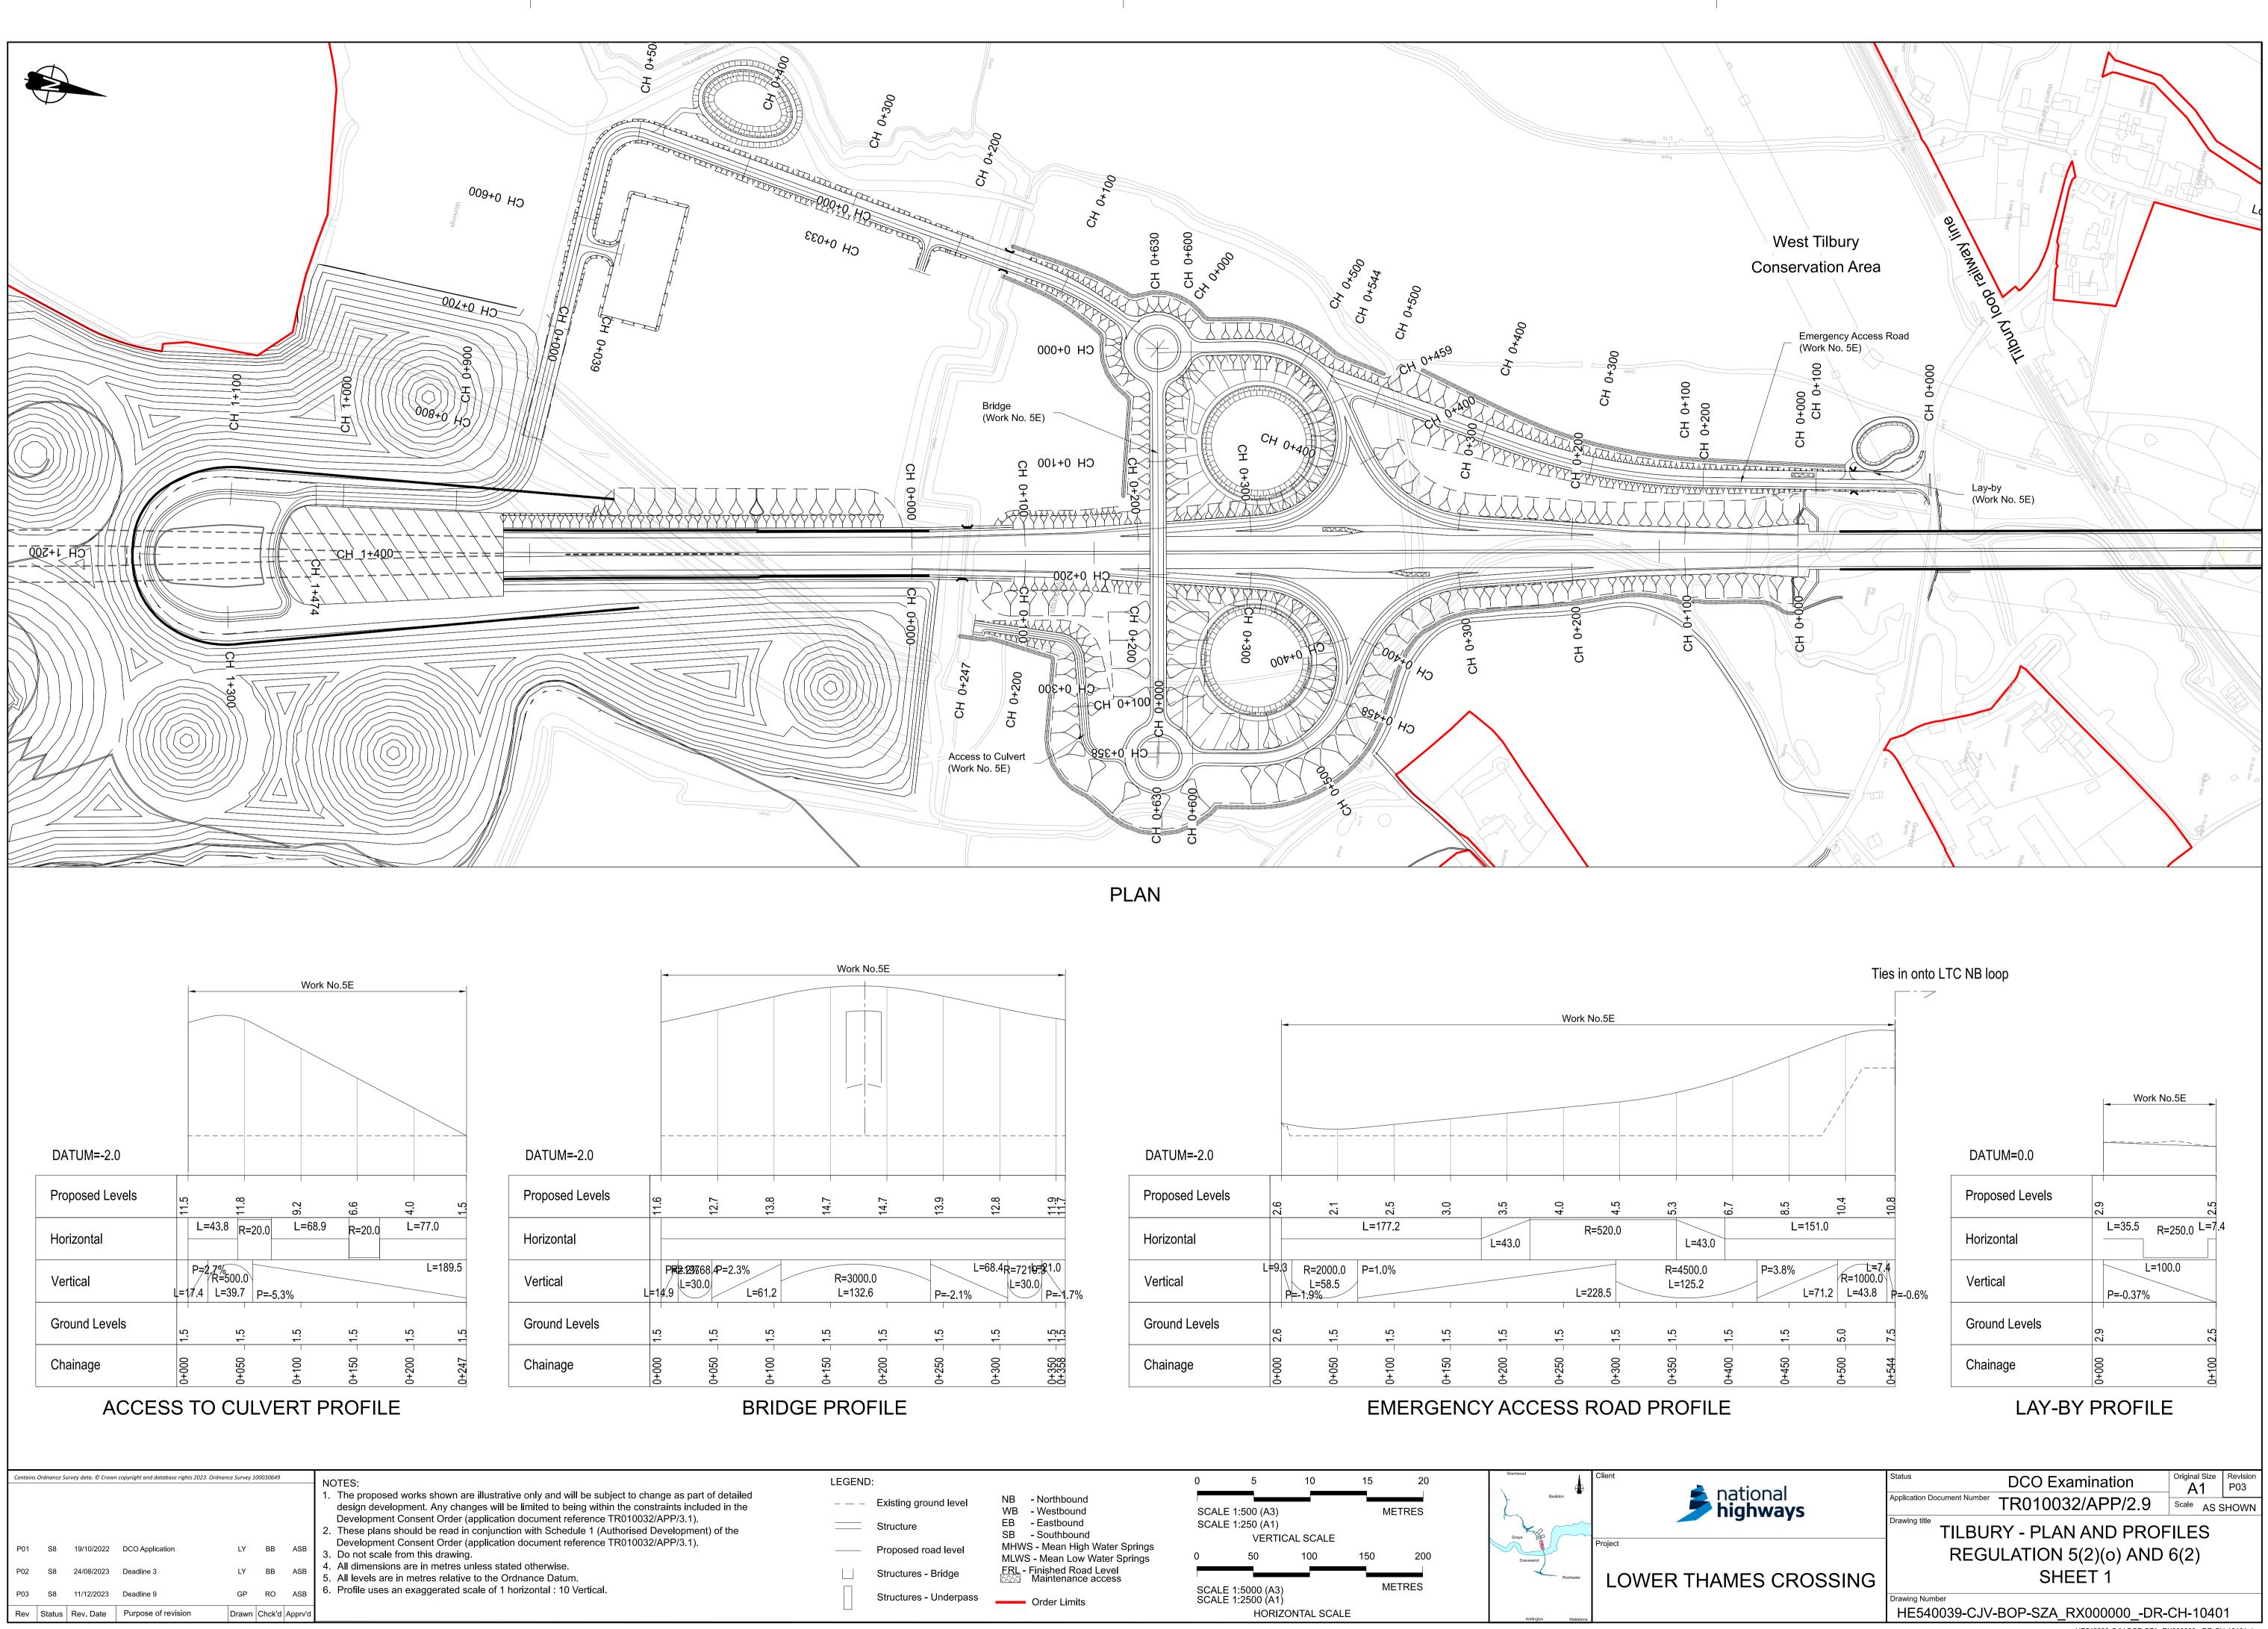



national	Status DCO Examination	Original Size	Revision P03					
national <b>highways</b>	Application Document Number TR010032/APP/2.9		SHOWN					
	Drawing title TILBURY - PLAN AND PROFILES							
	REGULATION 5(2)(0) AND 6(2)							
MES CROSSING	SHEET 1							
	Drawing Number HE540039-CJV-BOP-SZA_RX000000DR-	CH-1040	1					
	HE540039-CJV-BOP-SZA_R	X000000DR-CI	H-10401.dwg					

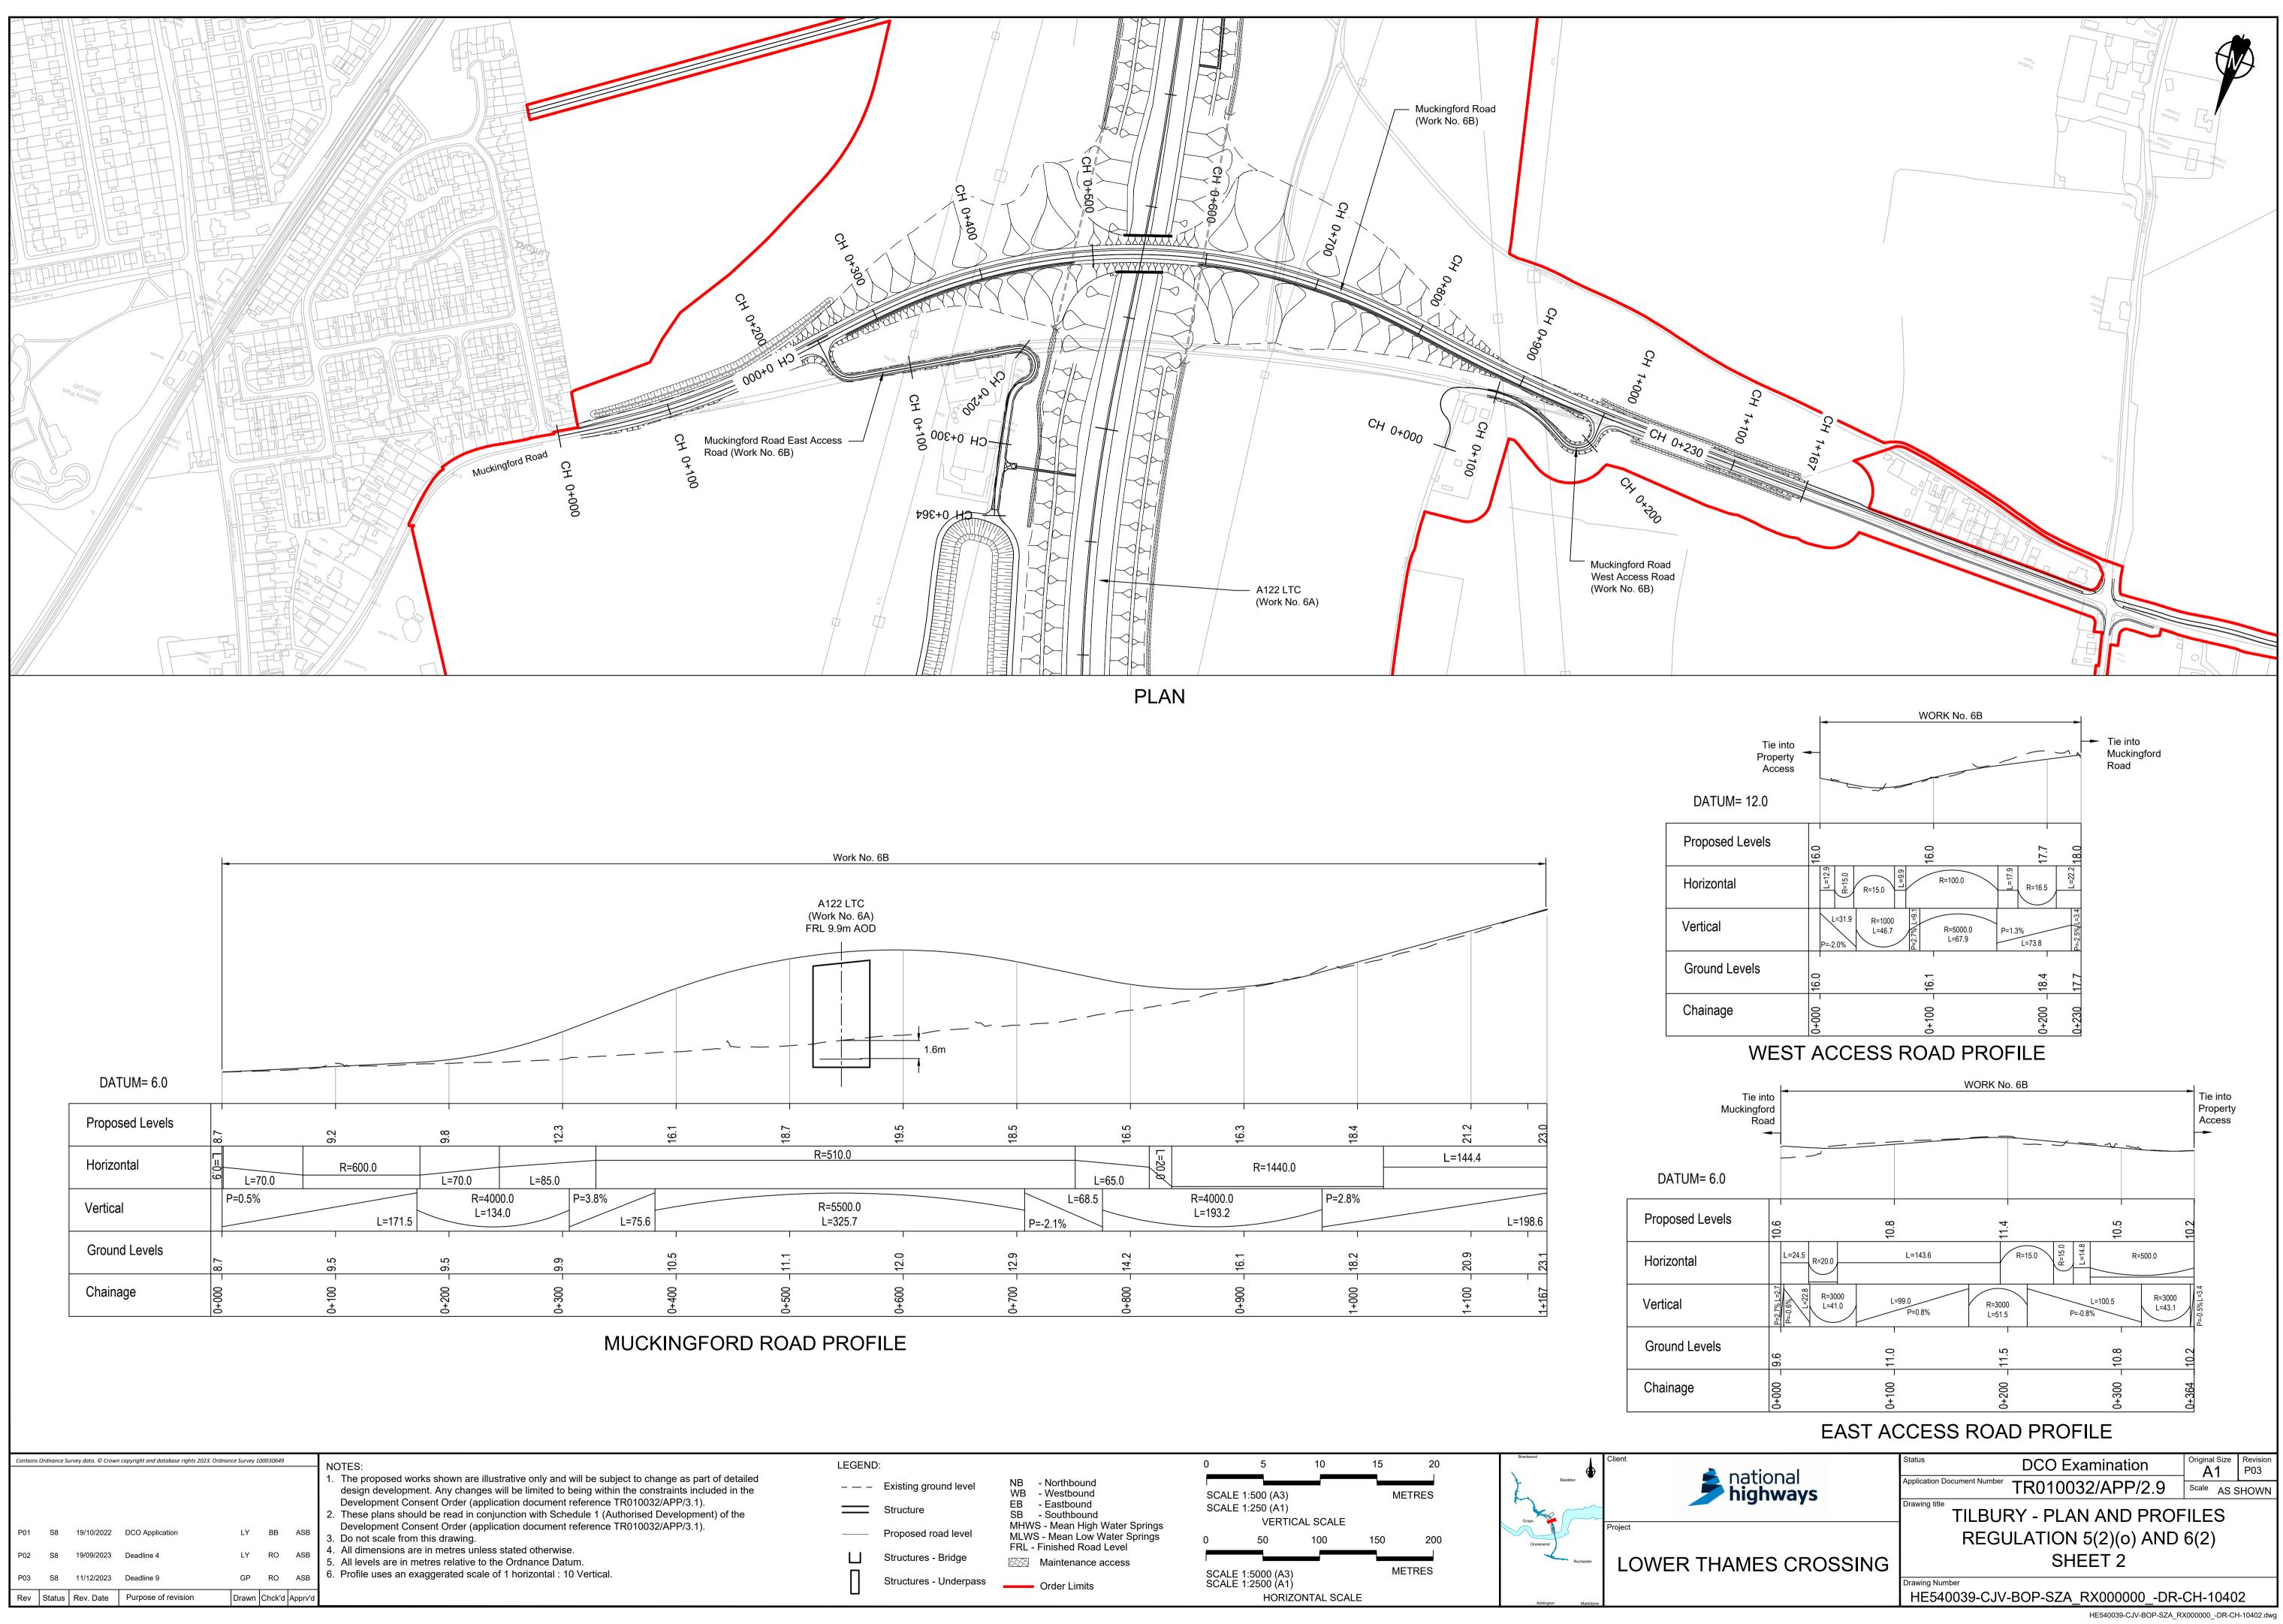


I

	East Tilbury
Contains Ordnance Survey data. @ Crown copyright and database rights 2023. Ord         P01       S8       19/10/2022       DCO Application         P02       S8       11/12/2023       Deadline 9         Rev       Status       Rev. Date       Purpose of revision	Image: Survey J000006/9       NOTES:         1. The proposed works shown are illustrative only and will be subject to change as part of detailed design development. Any changes will be limited to being within the constraints included in the Development Consent Order (application document reference TR01003/APP/3.1).         2. These plans should be read in conjunction with Schedule 1 (Authorised Development) of the Development Consent Order (application document reference TR01003/APP/3.1).         3. Do not scale from this drawing.         GP       RO         GP       RO         Drawn       Chekd

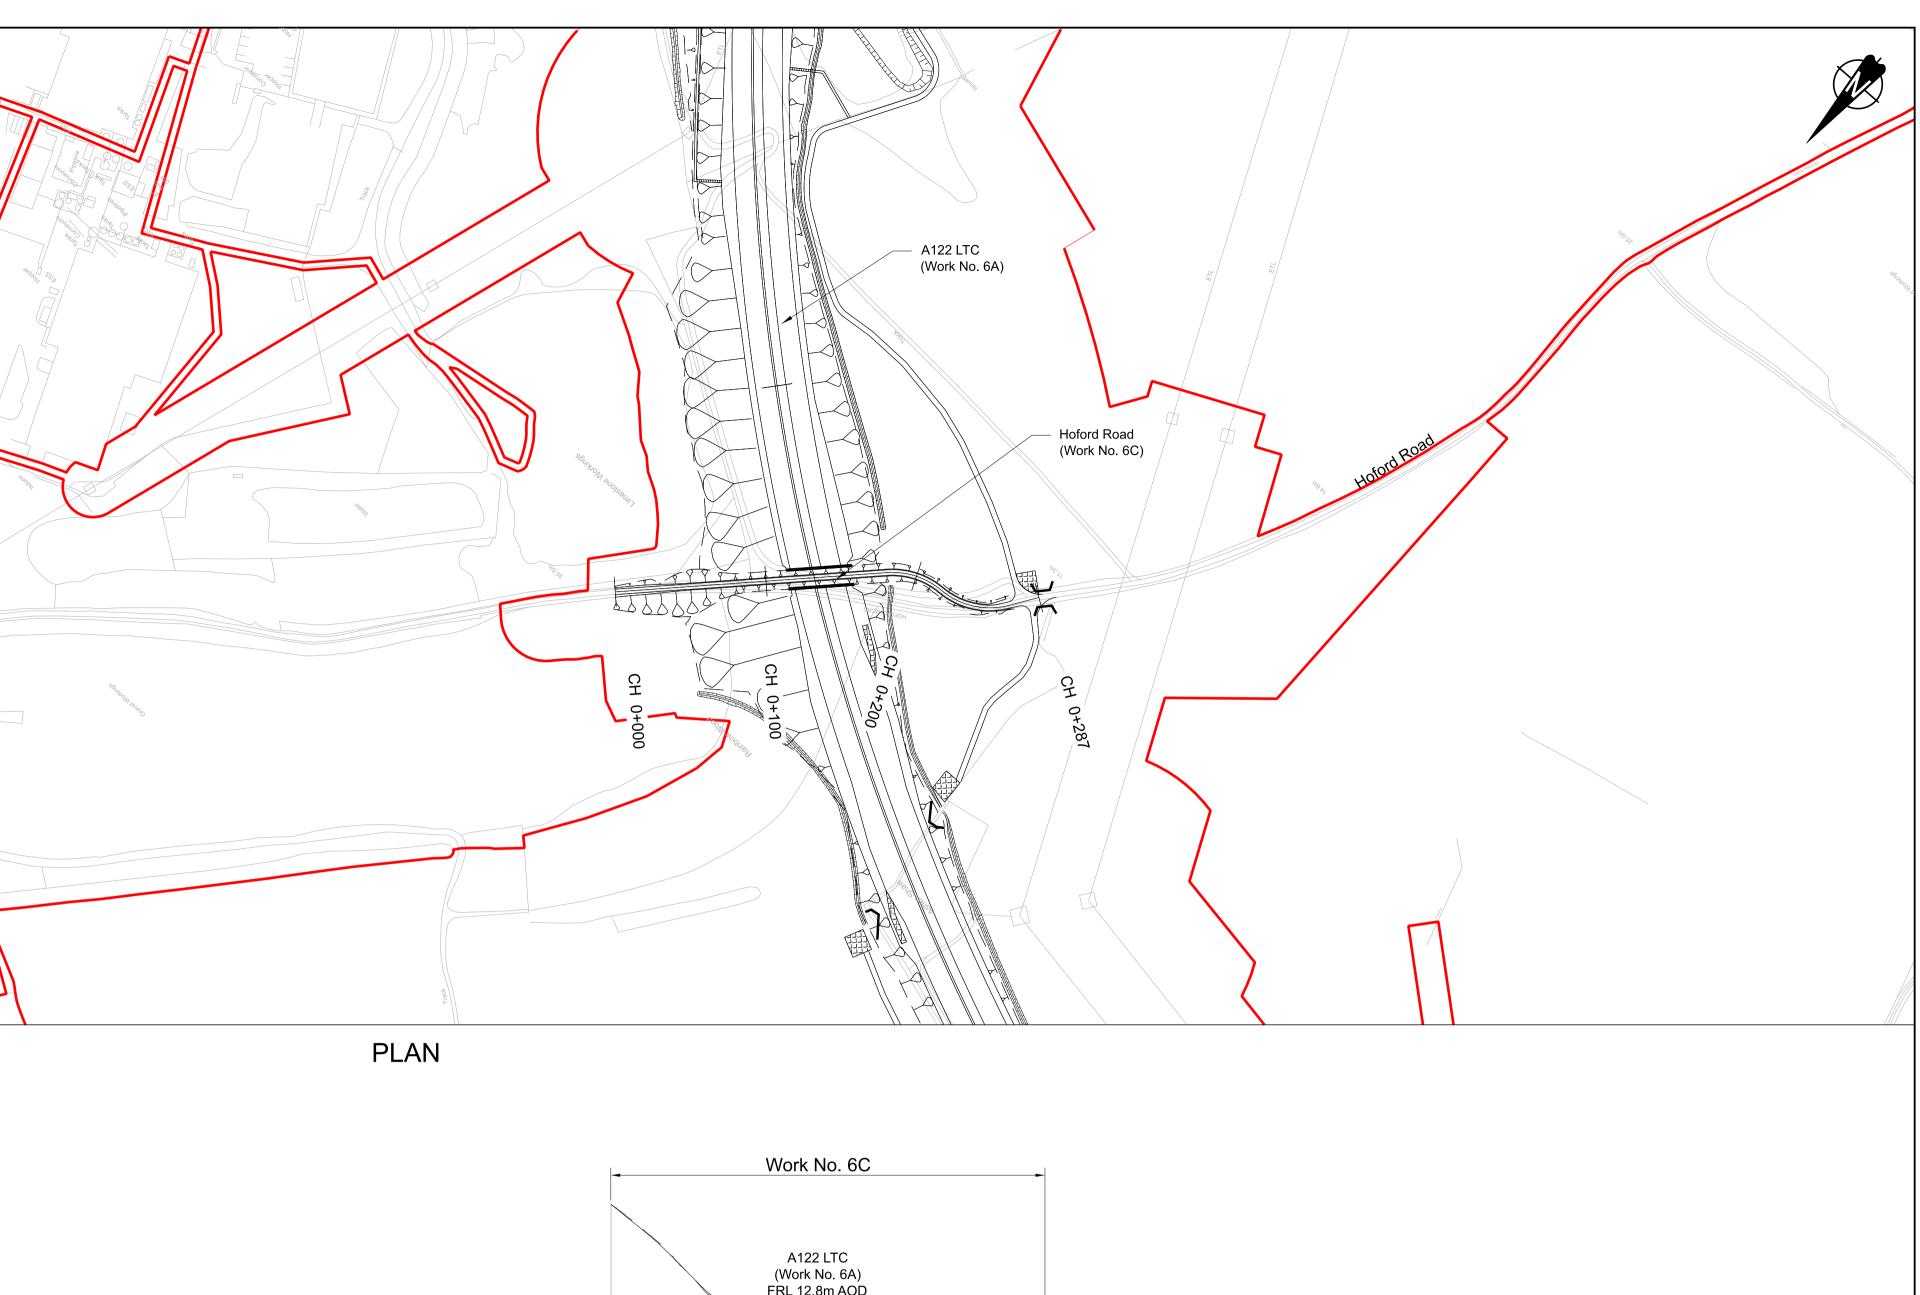


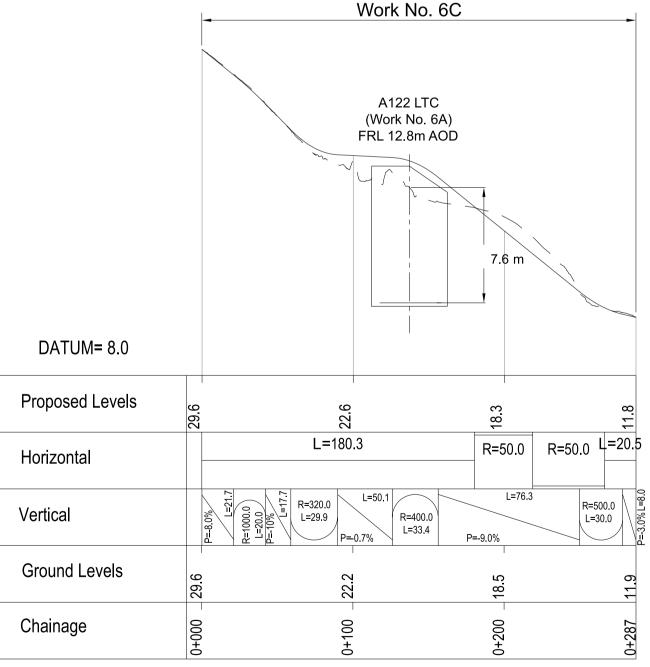


# HOFORD ROAD PROFILE

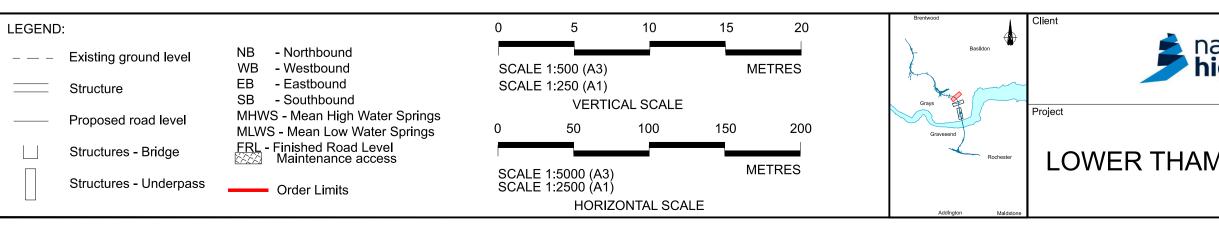



ational	Status DCO Examination	Original Size <b>A1</b>	Revision P02
ational <b>ighways</b>	Application Document Number TR010032/APP/2.9	Scale AS S	SHOWN
iginia,s	Drawing title TILBURY - PLAN AND PROF	ILES	
	REGULATION 5(2)(0) AND	6(2)	
MES CROSSING	SHEET 3		
	Drawing Number HE540039-CJV-BOP-SZA_RX000000DR-0	CH-1040	3

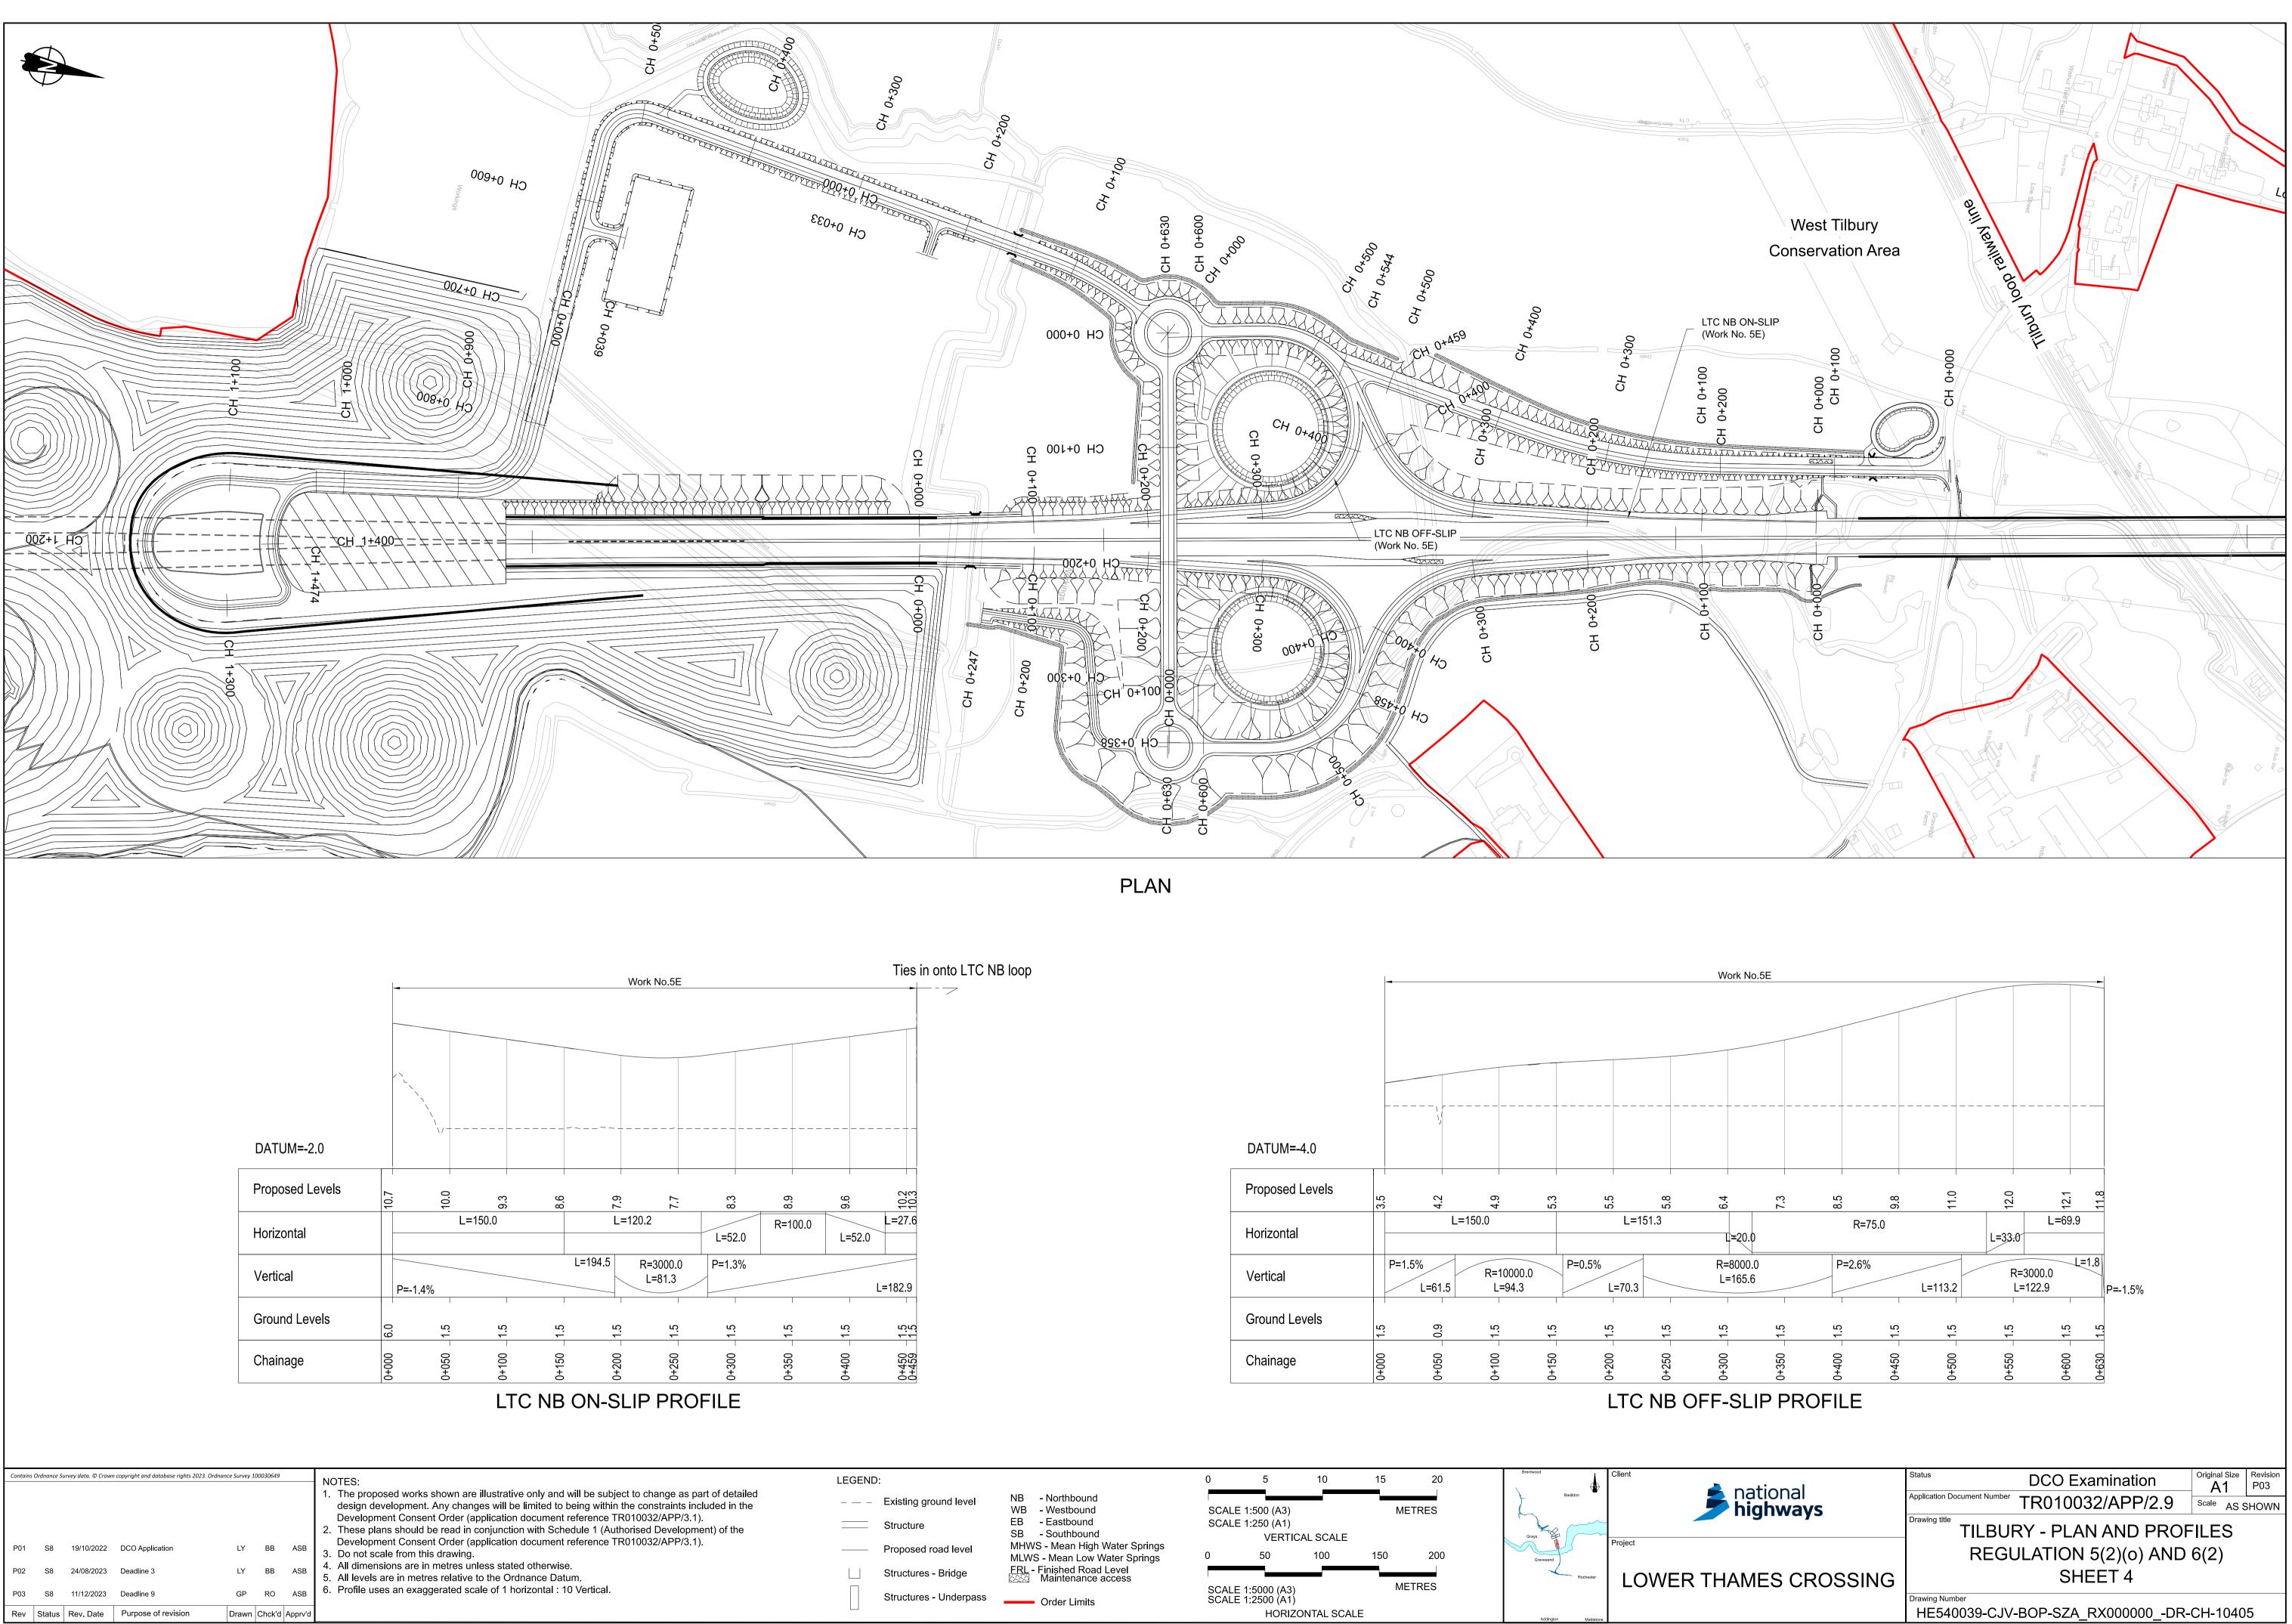


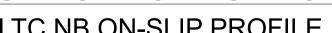


Contains	Ordnance St	urvey data. © Crowi	n copyright and database rights 2023	3. Ordnance Survey 10	00030649		NOTES:
P01	S8	19/10/2022	DCO Application	LY	BB	ASB	<ol> <li>The proposed works shown are illustrative only and will be subject to change as part of detailed design development. Any changes will be limited to being within the constraints included in the Development Consent Order (application document reference TR010032/APP/3.1).</li> <li>These plans should be read in conjunction with Schedule 1 (Authorised Development) of the Development Consent Order (application document reference TR010032/APP/3.1).</li> <li>Do not scale from this drawing.</li> </ol>
P02	S8	24/08/2023	Deadline 3	LY	BB	ASB	<ol> <li>All dimensions are in metres unless stated otherwise.</li> <li>All levels are in metres relative to the Ordnance Datum.</li> </ol>
P03	S8	11/12/2023	Deadline 9	GP	RO	ASB	6. Profile uses an exaggerated scale of 1 horizontal : 10 Vertical.
Rev	Status	Rev. Date	Purpose of revision	Drawn	Chck'd	Apprv'd	

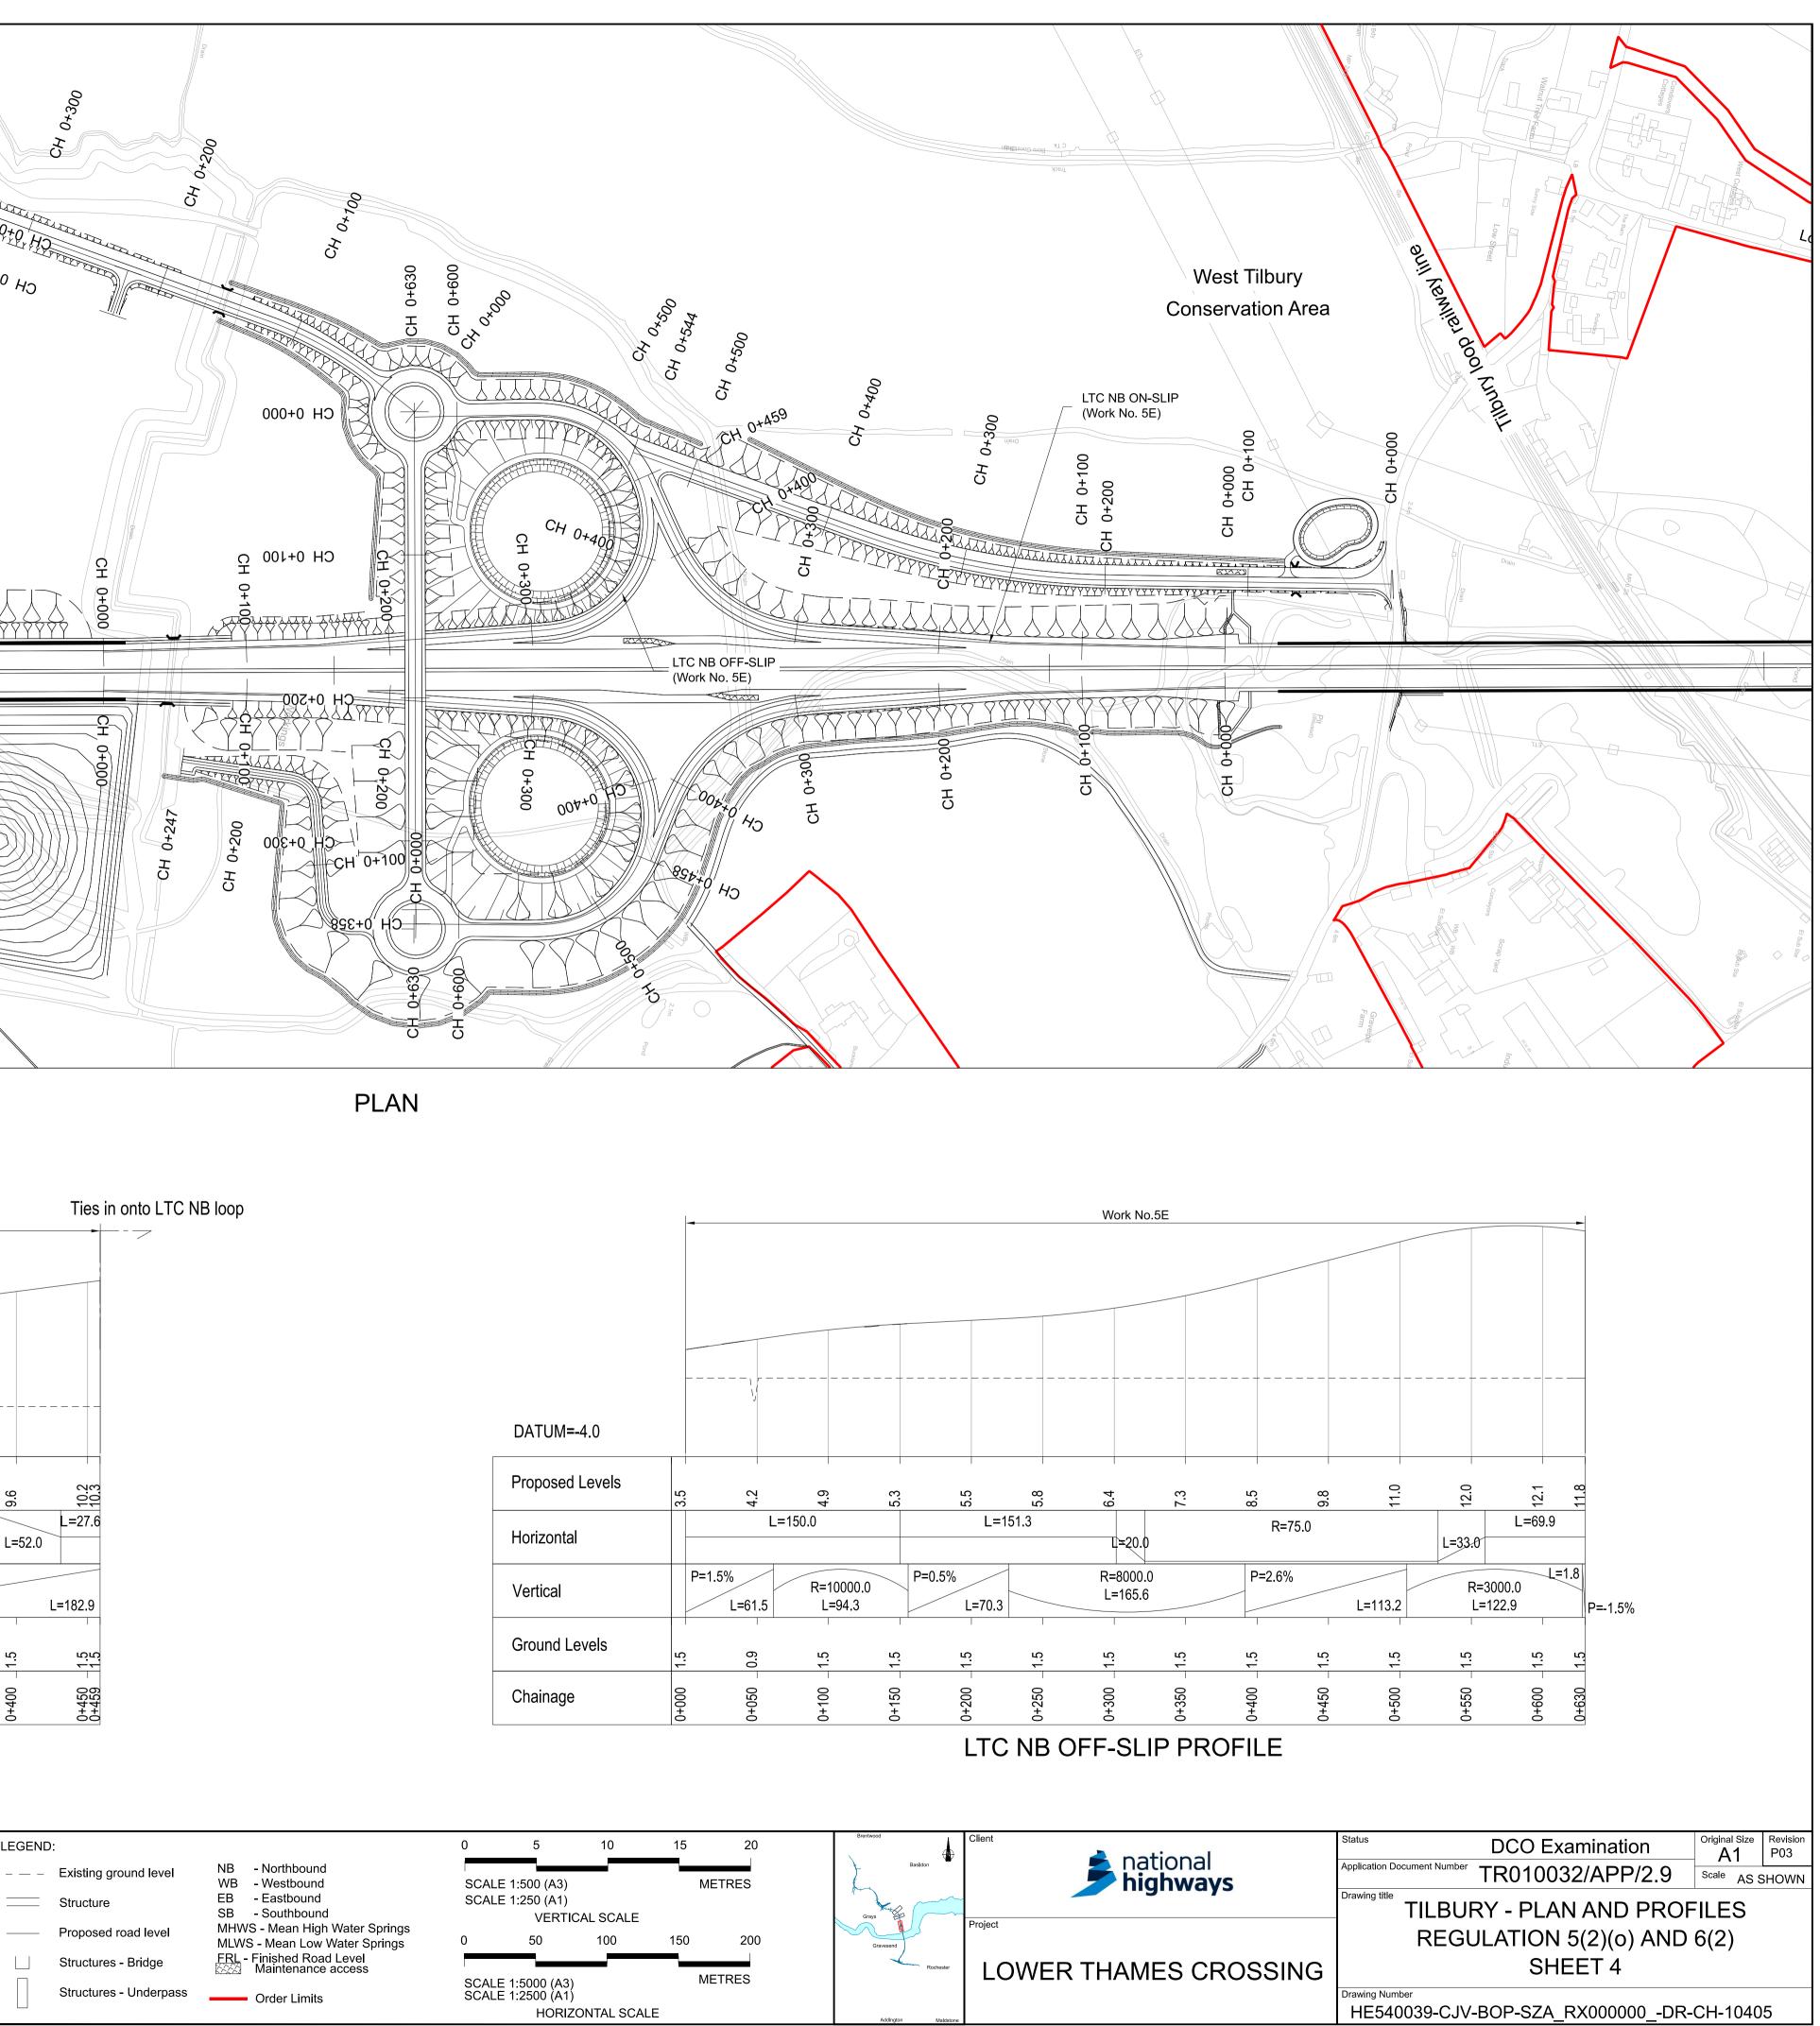

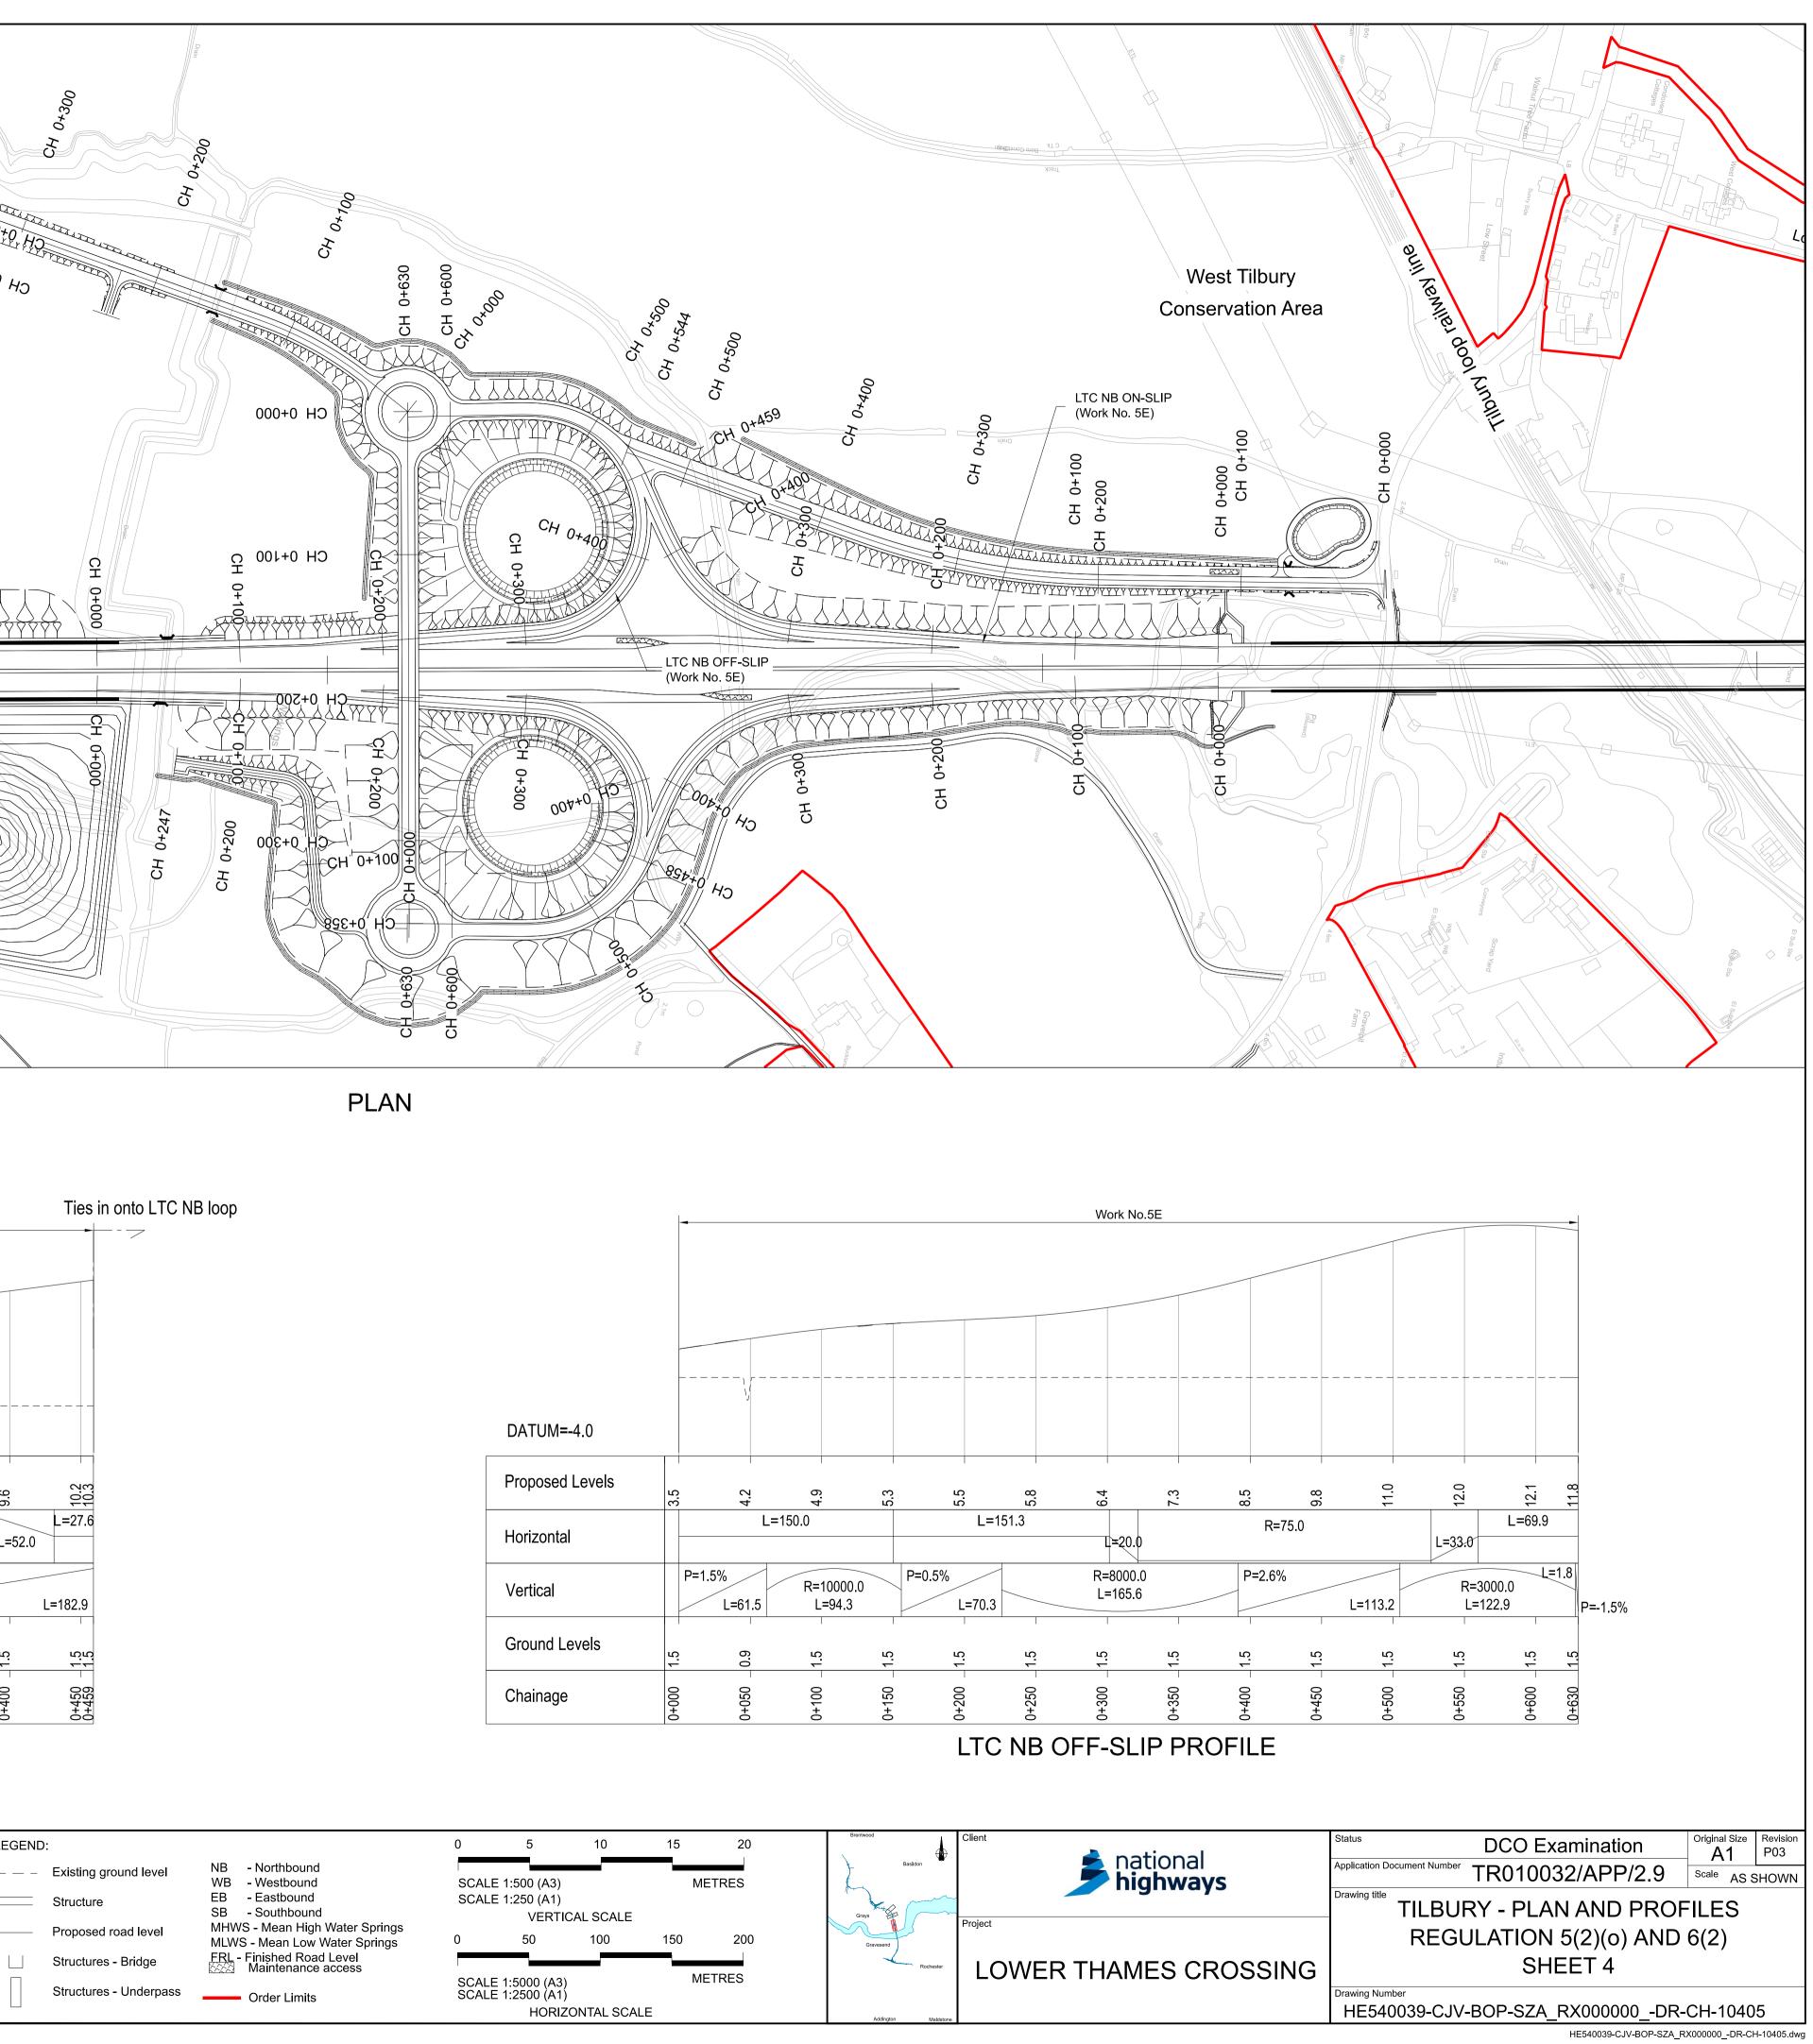

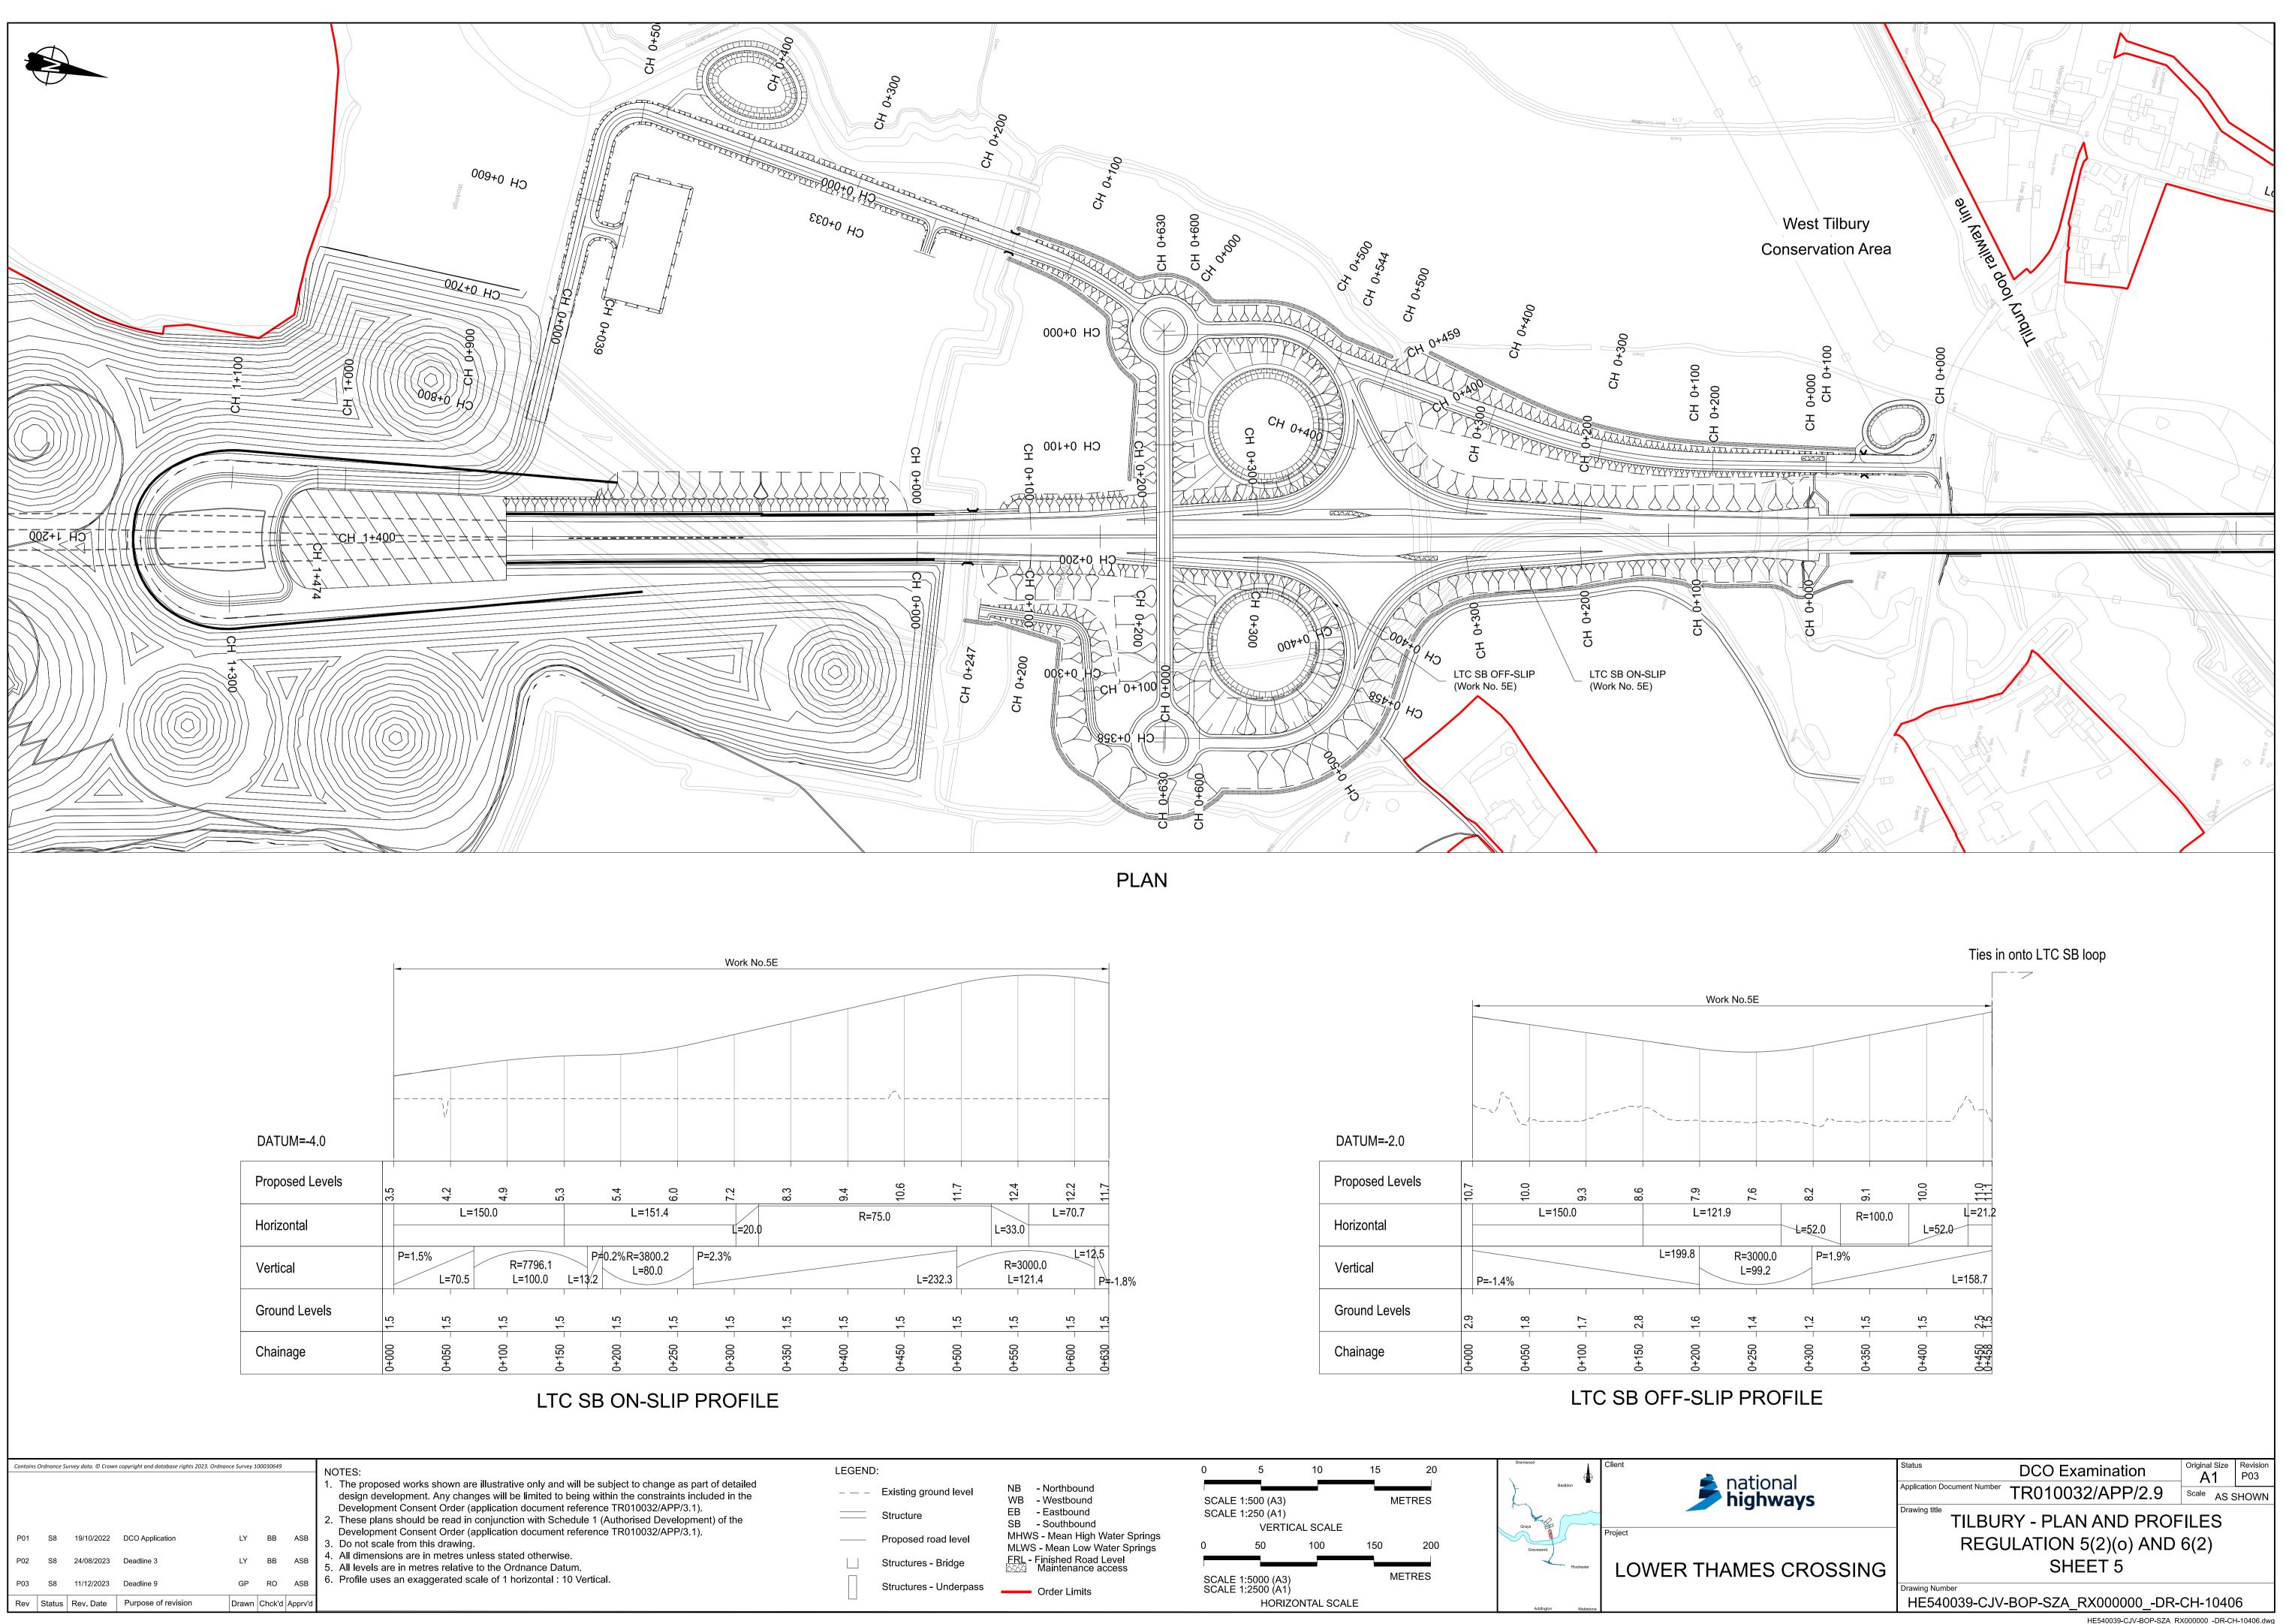


HE540039-CJV-BOP-SZA\_RX000000\_-DR-CH-10406.dwg

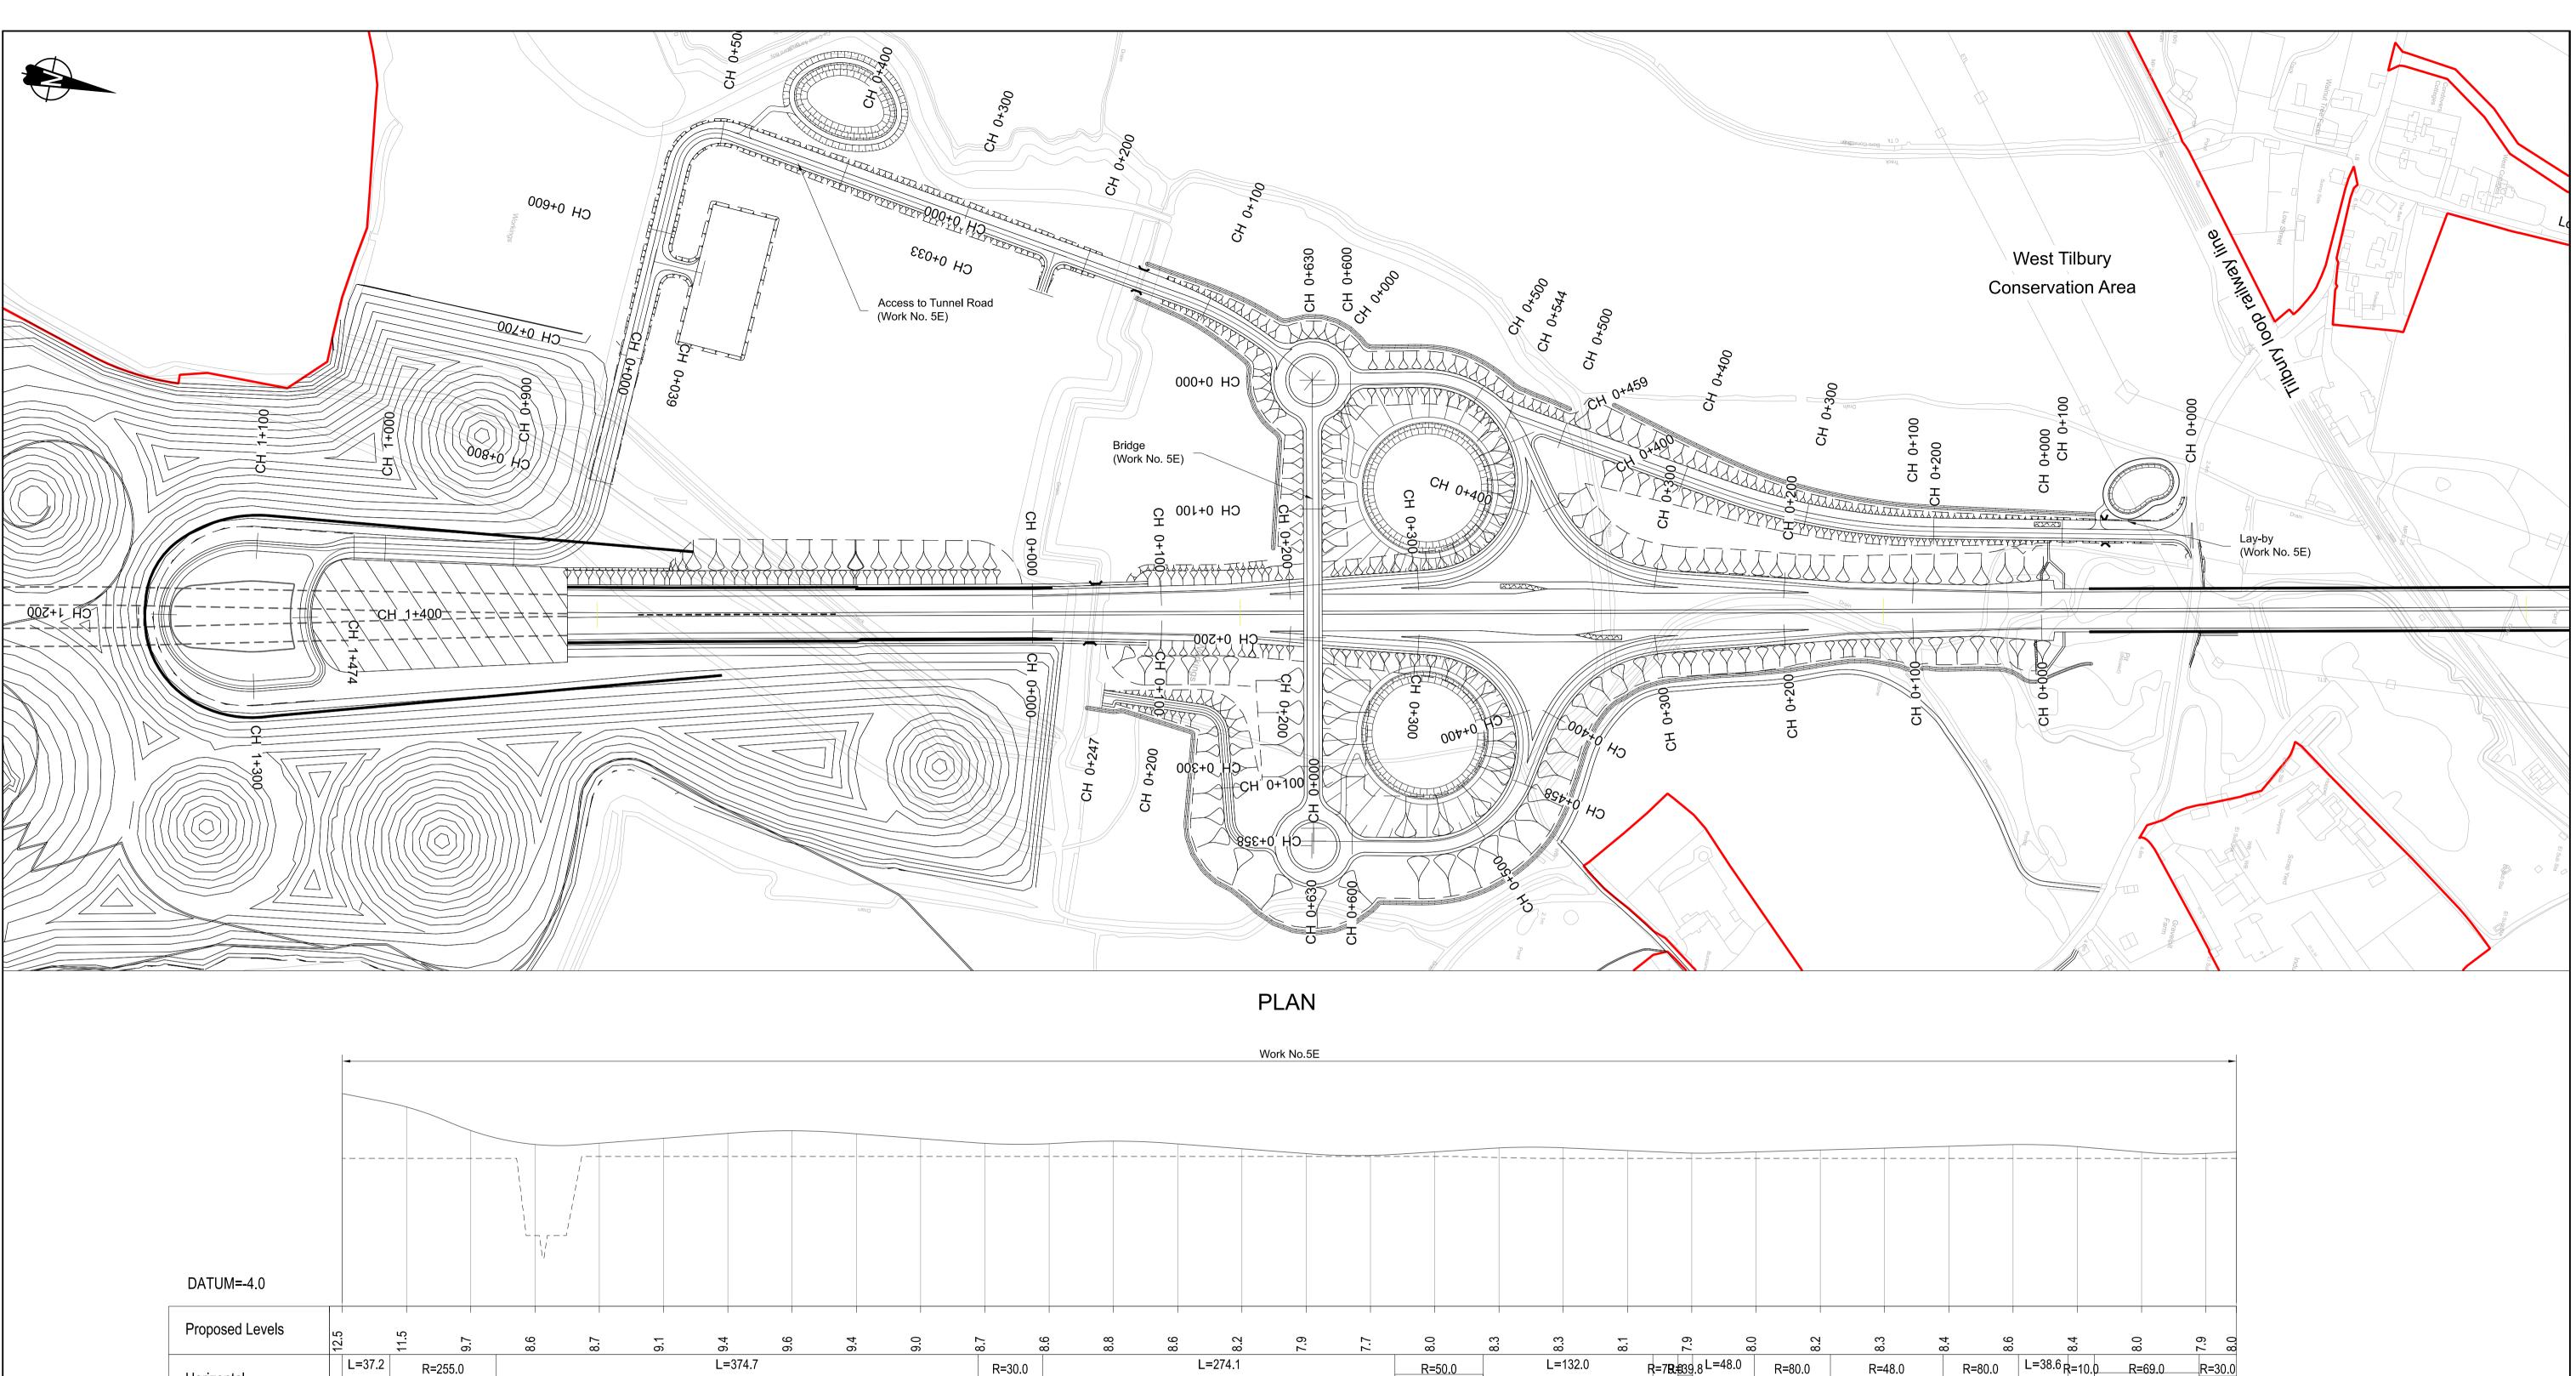


DATUM=-4.0										
Proposed Levels	12.5	11.5	9.7	8.6	8.7	9.1	9.4	9.6	9.4	0.0
Horizontal	L=37	.2 R=	255.0				L=374	.7		
Vertical	P=-2.	⁄R=2000.		2=2000.0 _=100.8	P=0.8%		L=121.3	R=5500.0 L=83.5	P=-0.8%	L=′
Ground Levels	7.5	7.5	7.5	1.5	7.6	7.6	7.6	7.6	7.6	7.6
Chainage	000+0	0+050	0+100	0+150	0+200	0+250	0+300	0+350	0+400	0+450

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P01	S8	19/10/2022	DCO Application	LY	BB	ASB	<ol> <li>Development Consent Order (application document reference TR010032/APP/3.1).</li> <li>These plans should be read in conjunction with Schedule 1 (Authorised Development) of the Development Consent Order (application document reference TR010032/APP/3.1).</li> <li>Do not scale from this drawing.</li> </ol>
P02	S8	24/08/2023	Deadline 3	LY	BB	ASB	<ol> <li>All dimensions are in metres unless stated otherwise.</li> <li>All levels are in metres relative to the Ordnance Datum.</li> </ol>
P03	S8	11/12/2023	Deadline 9	GP	RO	ASB	6. Profile uses an exaggerated scale of 1 horizontal : 10 Vertical.
Rev	Status	Rev. Date	Purpose of revision	Drawn	Chck'd	Apprv'd	

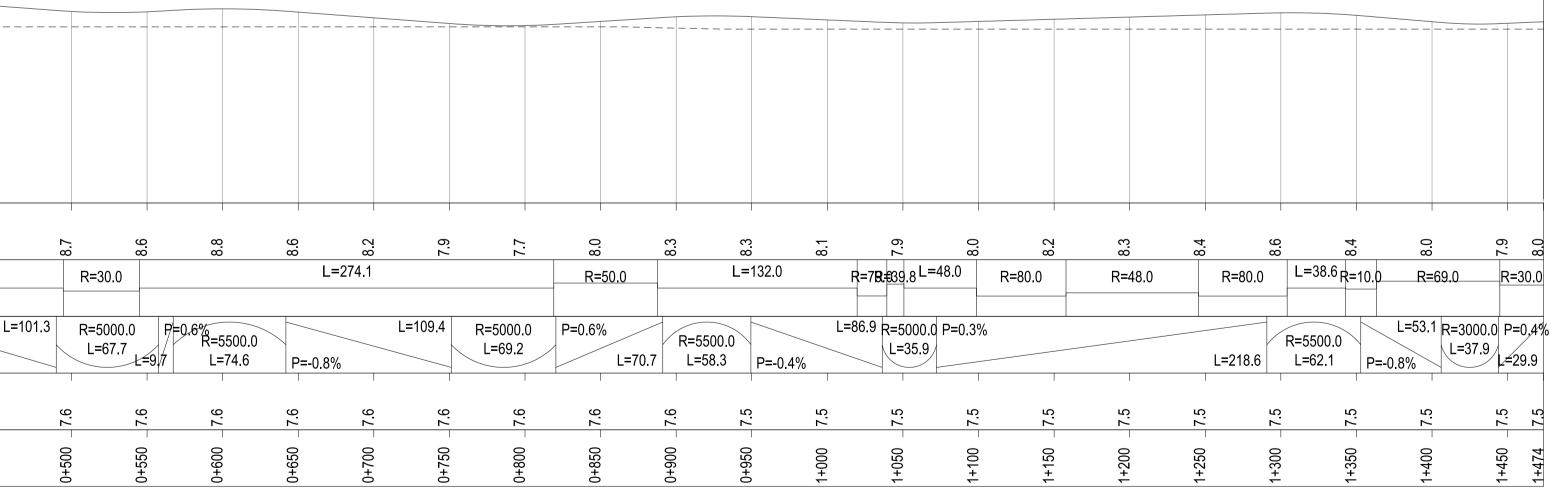

# ACCESS TO TUNNEL ROAD PROFILE

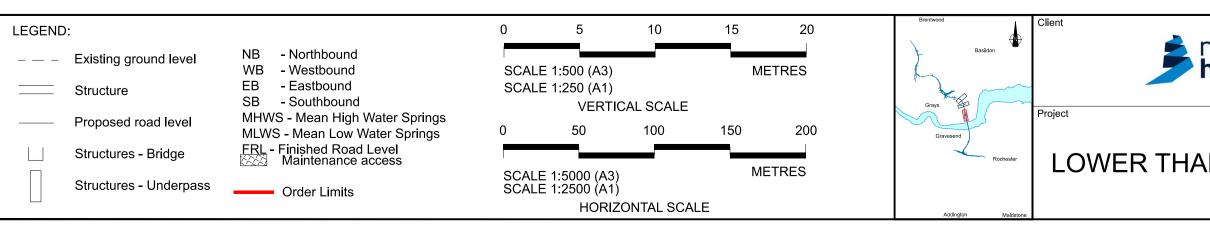

national	Status	DCO Examination	Original Size	Revision P03		
national <b>highways</b>	Application Document Numb	TR010032/APP/2.9		L SHOWN		
inginays	Drawing title TILBURY - PLAN AND PROFILES					
	REG	SULATION 5(2)(0) AND	6(2)			
AMES CROSSING		SHEET 6	. ,			
	Drawing Number HE540039-CJ	V-BOP-SZA_RX000000DR-	CH-1040	)7		

L=53.1 R=3000.0 P=0,4%

7.5

8

7.5 7.5

+474

+450

R=5500.0

7.5

350

7.5

-300

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