

Lower Thames Crossing

2.9 Engineering Drawings and Sections

Volume C (A2/M2 and A2 mainline plan and profiles)

APFP Regulation 5(2)(o) and 6(2)

Infrastructure Planning (Applications: Prescribed Forms and Procedure) Regulations 2009

Volume 2

DATE: October 2022

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Lower Thames Crossing

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1 Introduction

- 1.1.1 This document is submitted to the Planning Inspectorate on behalf of the Secretary of State in relation to an application made by National Highways (the Applicant) under section 37 of the Planning Act 2008.
- 1.1.2 The application is for the grant of development consent for the A122 Lower Thames Crossing. Should development consent be granted, the draft A122 (Lower Thames Crossing) Development Consent Order (Application Document 3.1) (the draft Order) will be made by the Secretary of State (subject to any modifications considered appropriate).
- 1.1.3 This document comprises part of the suite of application documentation and is included in the application to comply with Regulations 5(2)(0) and 6(2) of the Infrastructure Planning (Applications: Prescribed Forms and Procedure) Regulations 2009 (the 2009 Regulations), which require:
 - a. 5(2)(o) 'any other plans, drawings and sections necessary to describe the proposals for which development consent is sought, showing details of design, external appearance, and the preferred layout of buildings or structures, drainage, surface water management, means of vehicular and pedestrian access, any car parking to be provided, and means of landscaping.
 - b. 6(2) If the application is for highway related development or for the construction or alteration of a railway, it must be accompanied by section drawings to suitable horizontal and vertical scales, which show, by reference to Ordnance Survey or Chart datum:
 - c. the levels of the proposed works, including in particular and where relevant:
 - i. ground levels;
 - ii. the height of every proposed bridge, viaduct, aqueduct, embankment and elevated guideway;
 - iii. the depth of every proposed cutting and tunnel;
 - iv. the levels of the bed of any tidal waters or inland waterway in which it is proposed that any works should be situated;
 - the height of every structure or device (including a cable, but not catenary and related equipment) intended to be erected above, on or below the surface of, or on or beneath the bed of tidal waters or an inland waterway; and
 - vi. drainage outfall details for highways;

- 1.1.4 The purpose of the Engineering Drawings and Sections Plans is to show the key features of the Project for which development consent is sought. The set shows details of the proposed road plan and longitudinal profile including the ground levels, the height of certain structures and embankments, the depth of proposed cuttings and tunnel, and the indicative location and level of drainage outfall features.
- 1.1.6 For each section, the Applicant has provided a key plan of the corresponding geographical area that provides the sheet number and a description of the associated road works to help with its identification within the set. It is important to note that the plans are numbered in each of the aforementioned sections and that the numbering system does not apply to the set as whole.
- 1.1.7 The key plans use a smaller scale than that prescribed in Regulation 5(3) of the 2009 Regulations so that the Project or the section of the Project can be represented in a single sheet plan. The scales in the key plans vary from 1:50000 to 1:5000. The remaining sheets in the set containing the plan and profiles and the cross sections have been prepared at a horizontal scale of 1:2500 and a vertical scale of 1:250.
- 1.1.8 As this document has been informed by and is part of the application documentation it should be read alongside the other application documents. In particular, the plans should be read alongside the Works Plans (Application Document 2.6) and Schedule 1 of the draft Order (Application Document 3.1). Article 6 of the draft Order should also be referred to as it provides the reference points for the application of the upwards and downwards vertical limits of deviation applicable to the elements of the works.
- 1.1.9 Numbered works shown in the Engineering Drawings and Sections Plans are consistent with the information presented in the Works Plans (Application Document 2.6) and Schedule 1 of the draft Order (Application Document 3.1). Further details of the proposed bridges and tunnel structures are provided in the Structures Plans (Application Document 2.13).
- 1.1.10 The information shown on the plans is commensurate with the preliminary design status of the Project. The detailed design will be in accordance with the extent of the defined limits of deviation provided and any approval required under the DCO requirements set out in Schedule 2 of the draft Order (Application Document 3.1).
- 1.1.11 The lateral limits of deviation for the works are shown in the Works Plans (Application Document 2.6) and in the Tunnel Limits of Deviation (Application Document 2.15); article 6 of the draft Order establishes the vertical limits of deviation. Further information about the limits of deviation is provided in the Introduction to the Application (Application Document 1.3).
- 1.1.6 The Engineering Drawings and Sections show the Order Limits. In this plan set, 'the Order Limits' mean the limits of lands to be acquired or used, permanently or temporarily, within which the authorised development may be carried out (see article 2 of the draft Order (Application Document 3.1)).
- 1.1.7 To ensure that the file size of this document does not exceed the 50MB limit prescribed by the Planning Inspectorate, the set has been split into eight volumes:

- a. Volume A contains the A122 Lower Thames Crossing Plan and Profiles;
- b. Volume B contains the A122 Lower Thames Crossing Cross Sections;
- c. Volume C contains the A2/M2 Plan and Profiles and A2 Mainline Plan and Profiles;
- d. Volume D contains the A122 Lower Thames Crossing/A2 Junction Plan and Profiles;
- e. Volume E contains the South Portal Plan and Profiles and Tilbury Plan and Profiles;
- f. Volume F contains the A13 Junction Plan and Profile;
- g. Volume G contains the A122 Lower Thames Crossing/M25 Junction Plan; and
- h. Volume H contains the Overhead Diversion Route and Pylon general arrangements.

2 Schedule of Plans included in this application document

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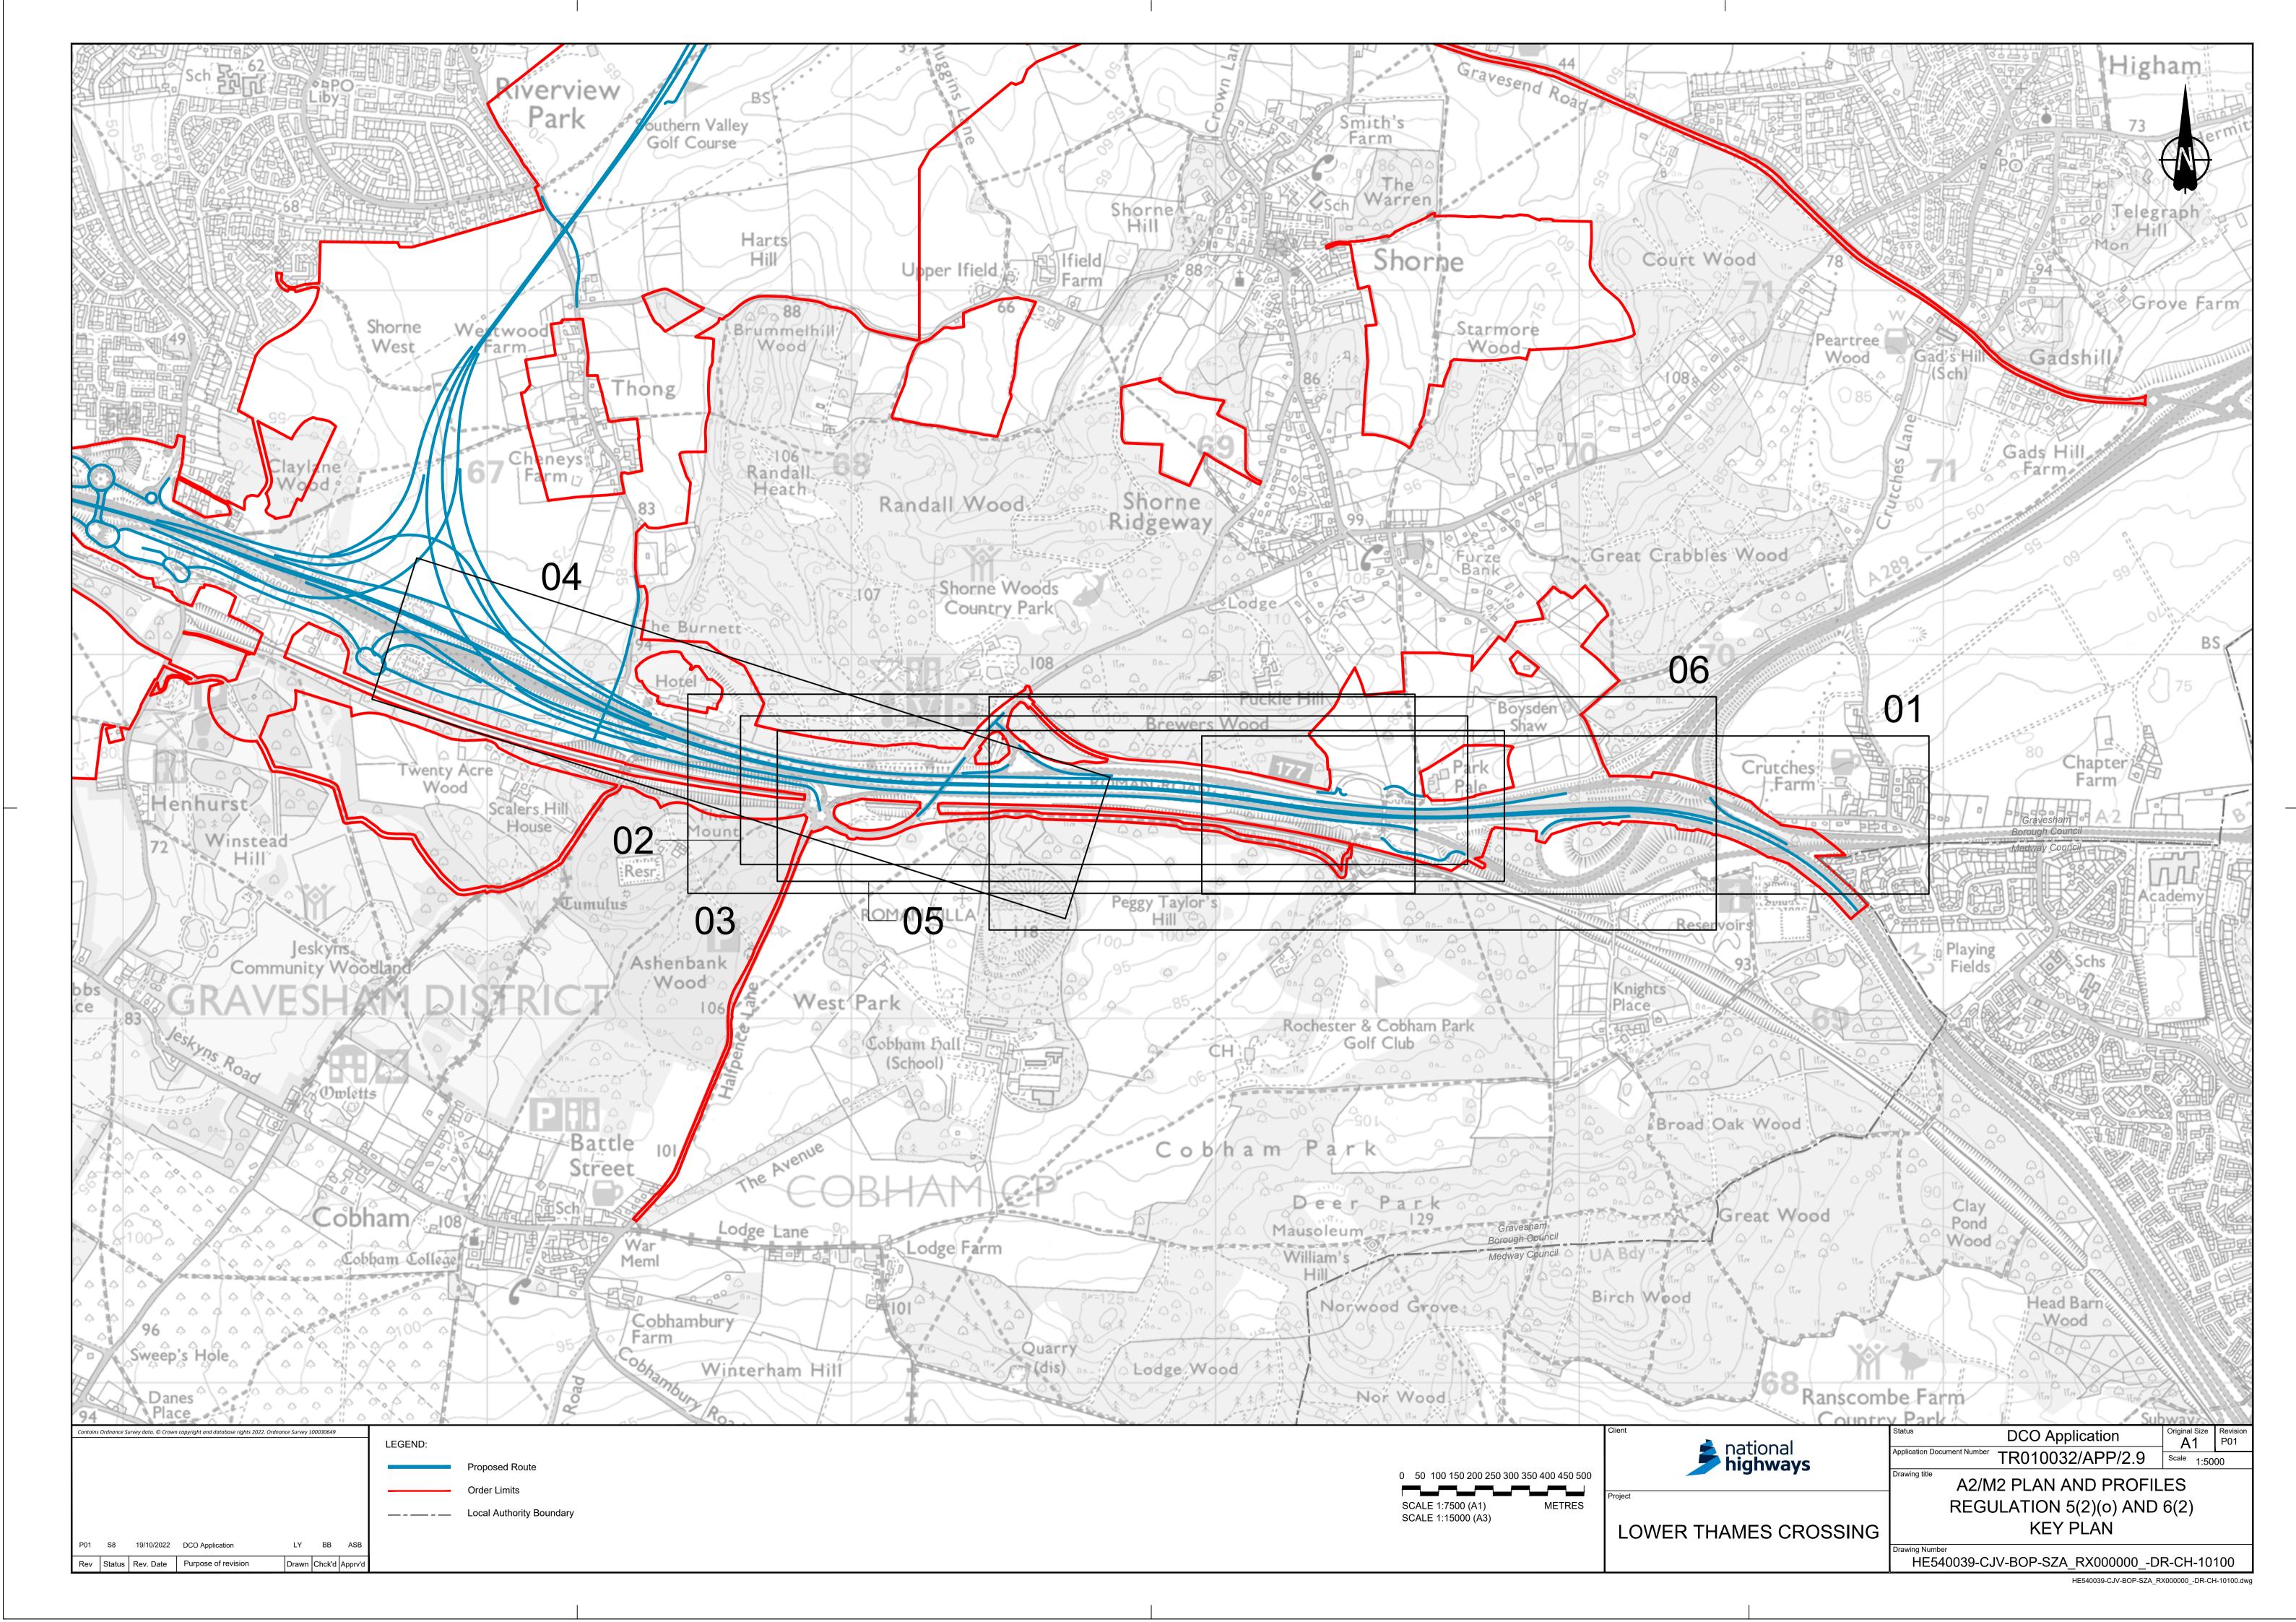
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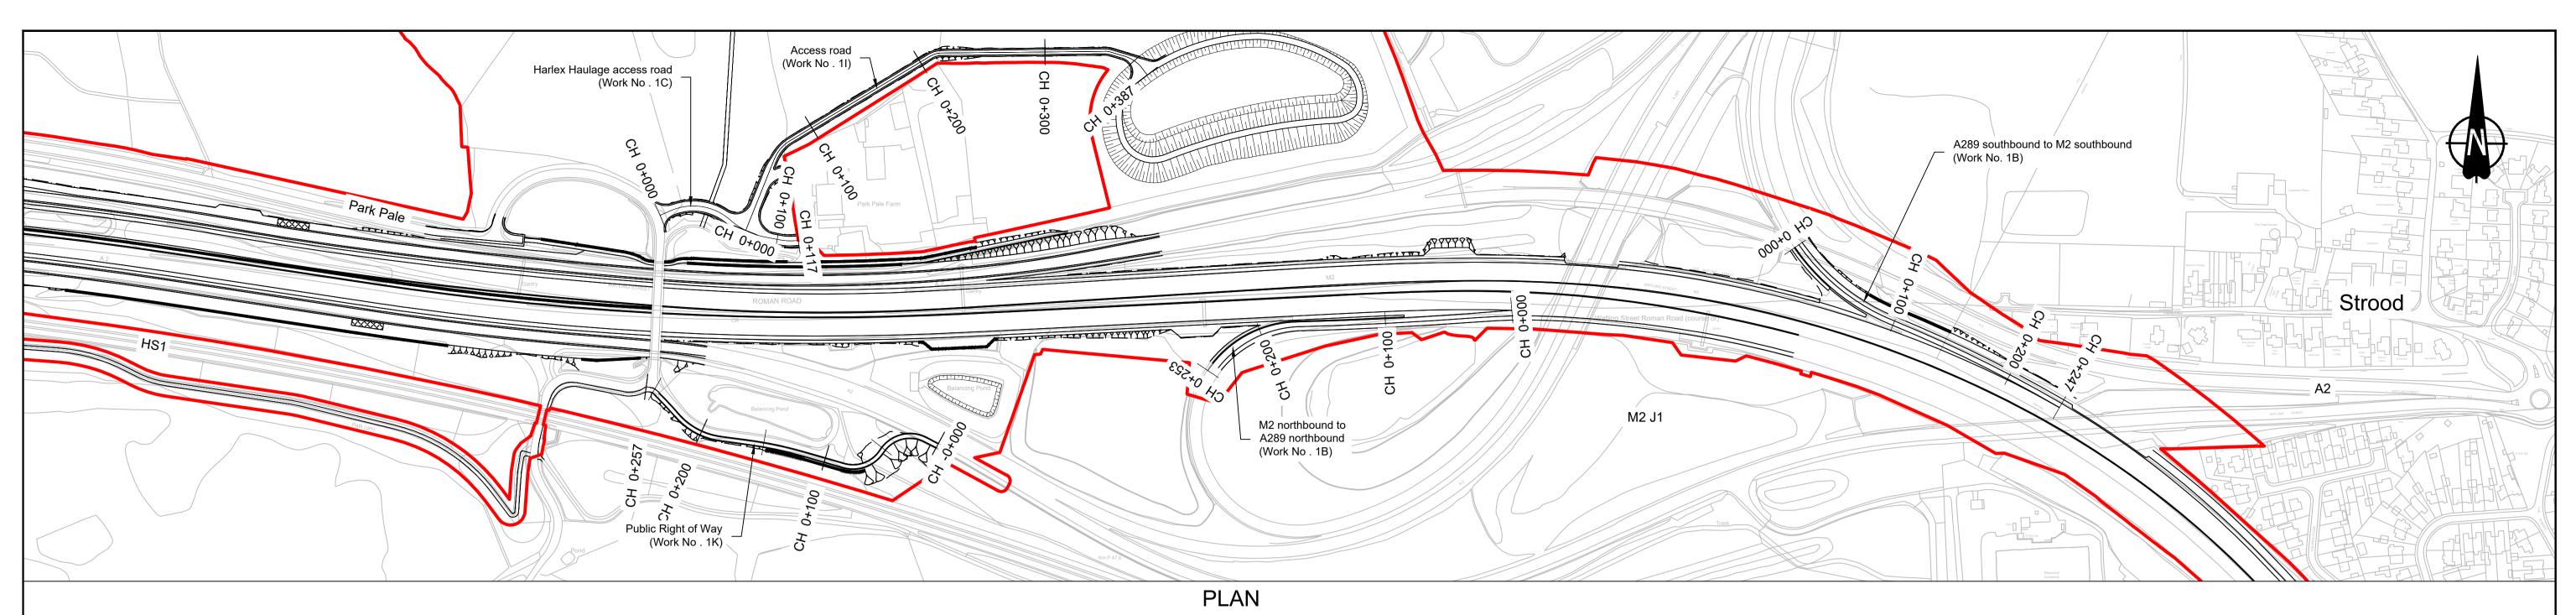
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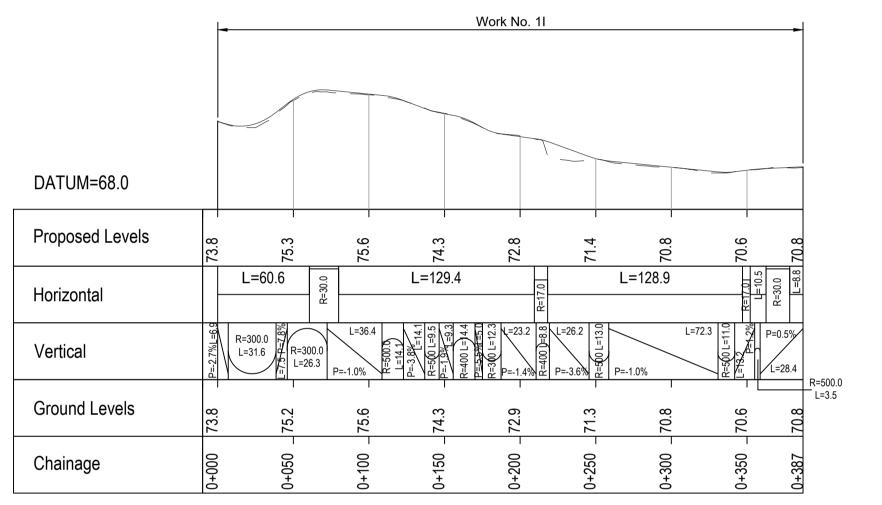
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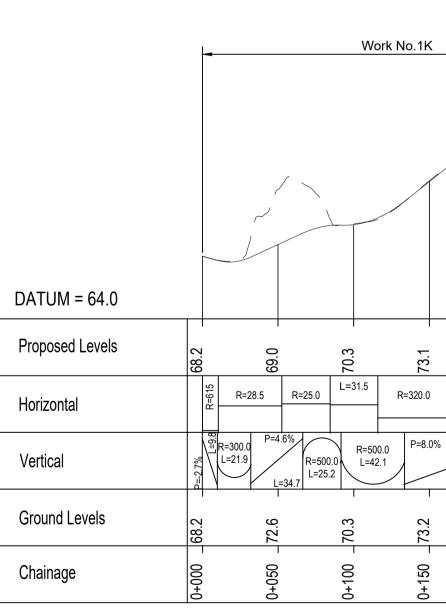
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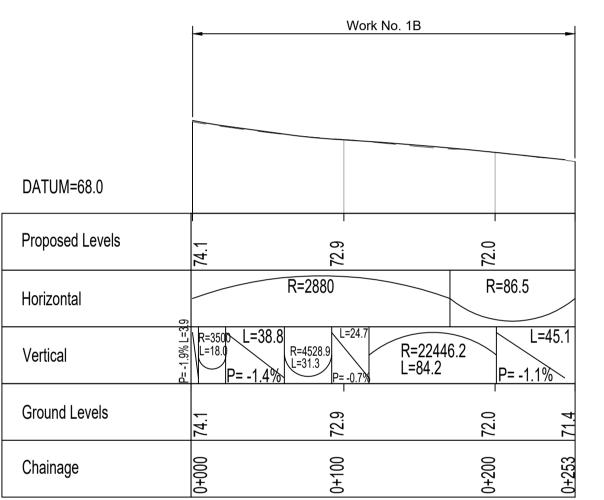
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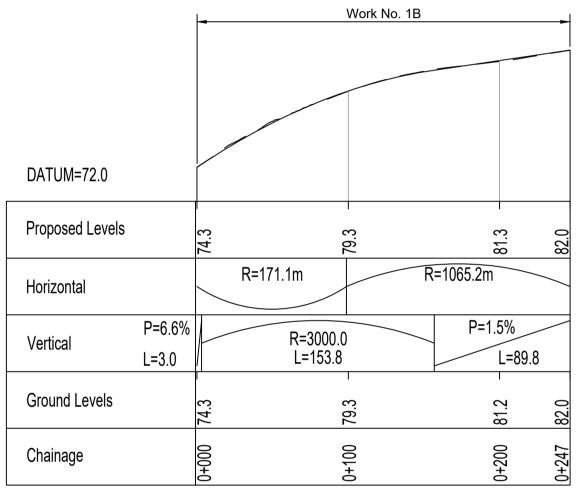
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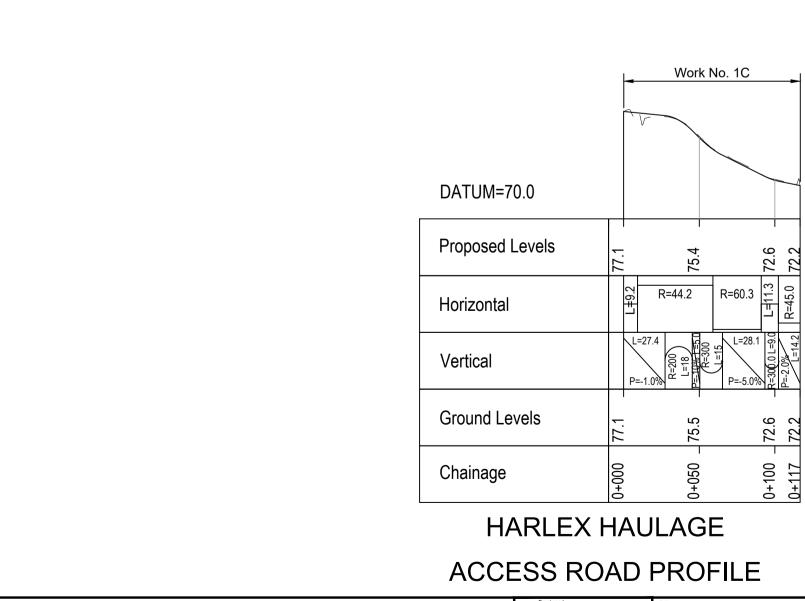
PUBLIC RIGHT OF WAY PROFILE


Contains	Oranance St	irvey data. © Crowi	n copyright and database rights 2022.	. Oranance Survey	100030649		NOTES:	LEGE
							1. The proposed works shown are illustrative only and will be subject to change as part of detailed design development. Any changes will be limited to being within the constraints included in the	
							Development Consent Order (application document reference TR010032/APP/3.1). 2. These plans should be read in conjunction with Schedule 1 (Authorised Development) of the	—
							Development Consent Order (application document reference TR010032/APP/3.1). 3. Do not scale from this drawing.	
							 All dimensions are in metres unless stated otherwise. All levels are in metres relative to the Ordnance Datum. 	
P01	S8	19/10/2022	DCO Application	LY	BB	ASB	6. Profile uses an exaggerated scale of 1 horizontal : 10 Vertical.	Π
Rev	Status	Rev. Date	Purpose of revision	Drawn	Chck'd	Apprv'd		L






M2 NORTHBOUND TO A289 NORTHBOUND PROFILE




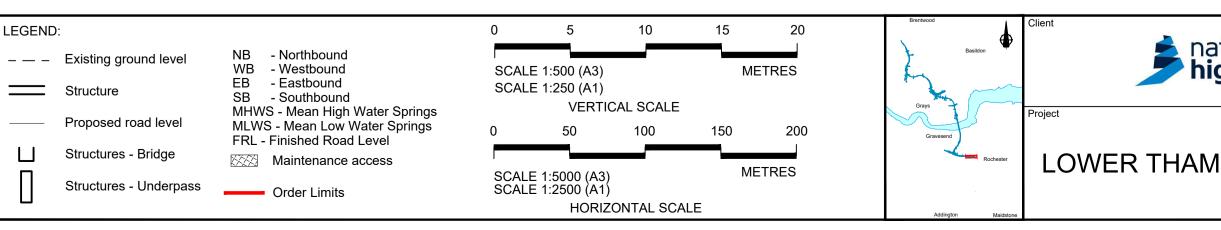


A289 SOUTHBOUND TO M2 SOUTHBOUND PROFILE

national	Status DCO Application	Original Size	Revision P01				
national highways	Application Document Number TR010032/APP/2.9	Scale AS SHOWN					
·	Drawing title A2/M2 PLAN AND PROFILES						
	REGULATION 5(2)(0) AND 6(2)						
HAMES CROSSING	SHEET 1						
	Drawing Number HE540039-CJV-BOP-SZA RX000000 -DR-0	CH-1010 ⁻	1				

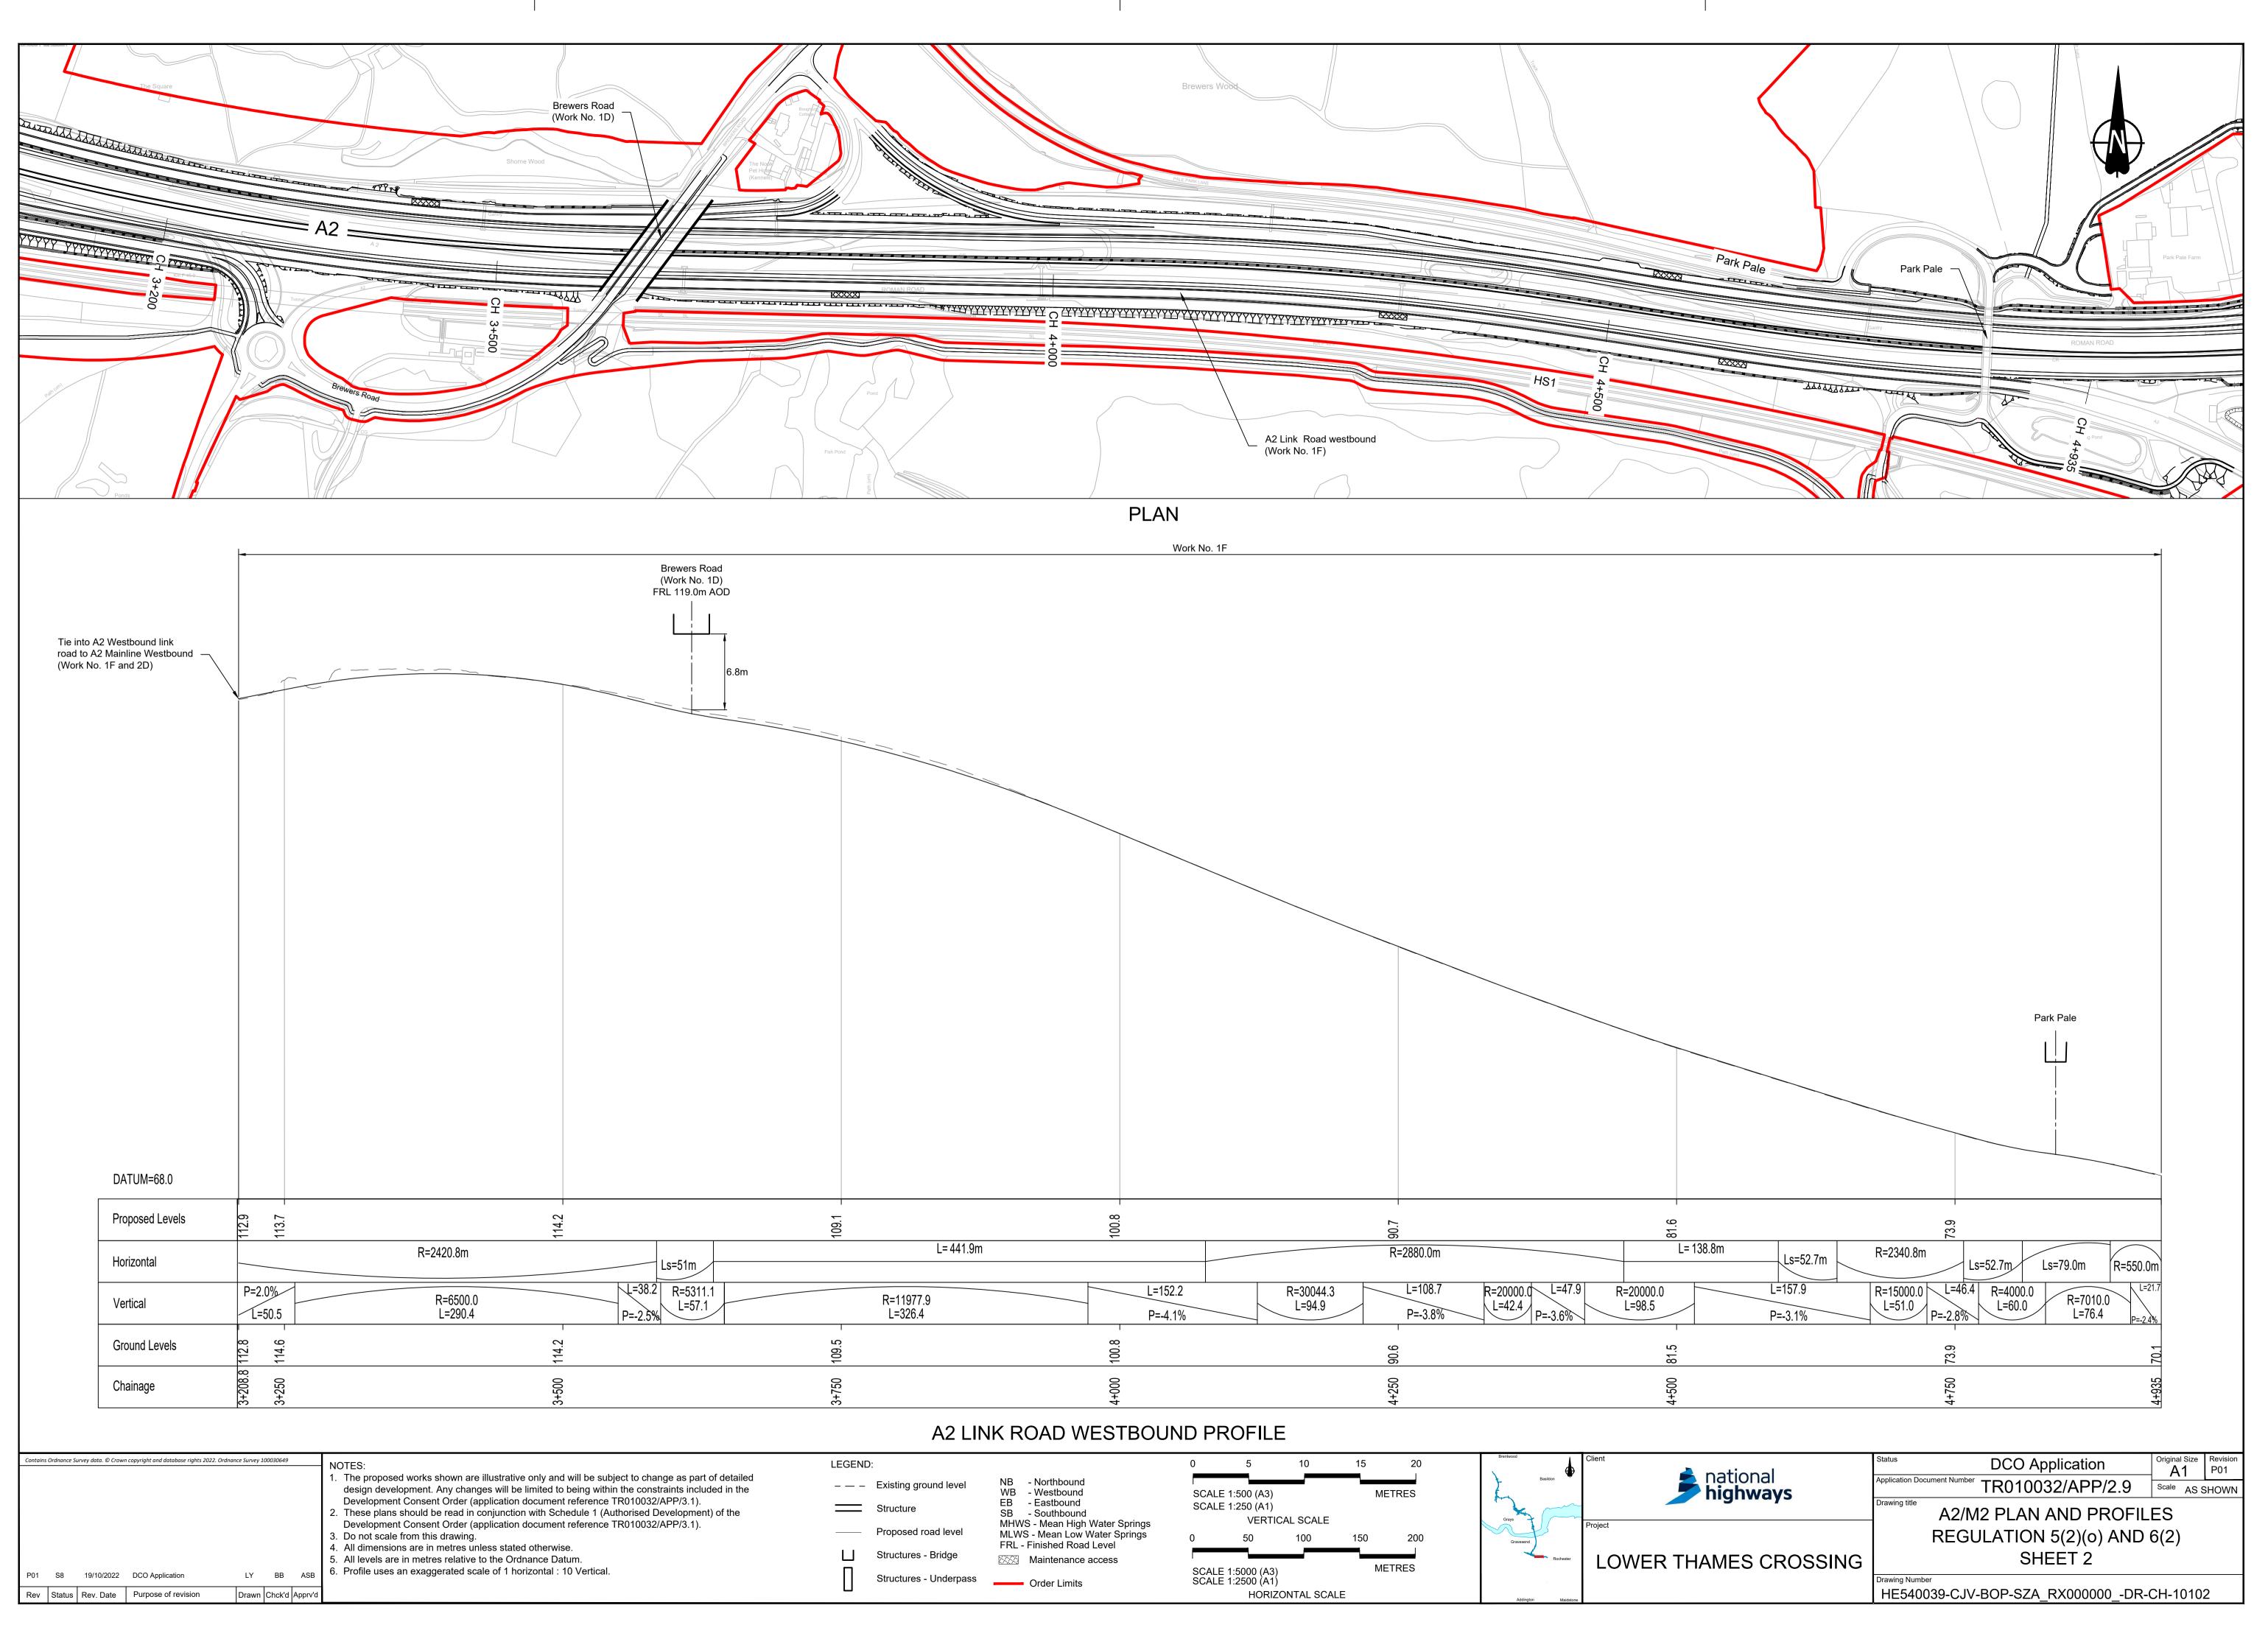

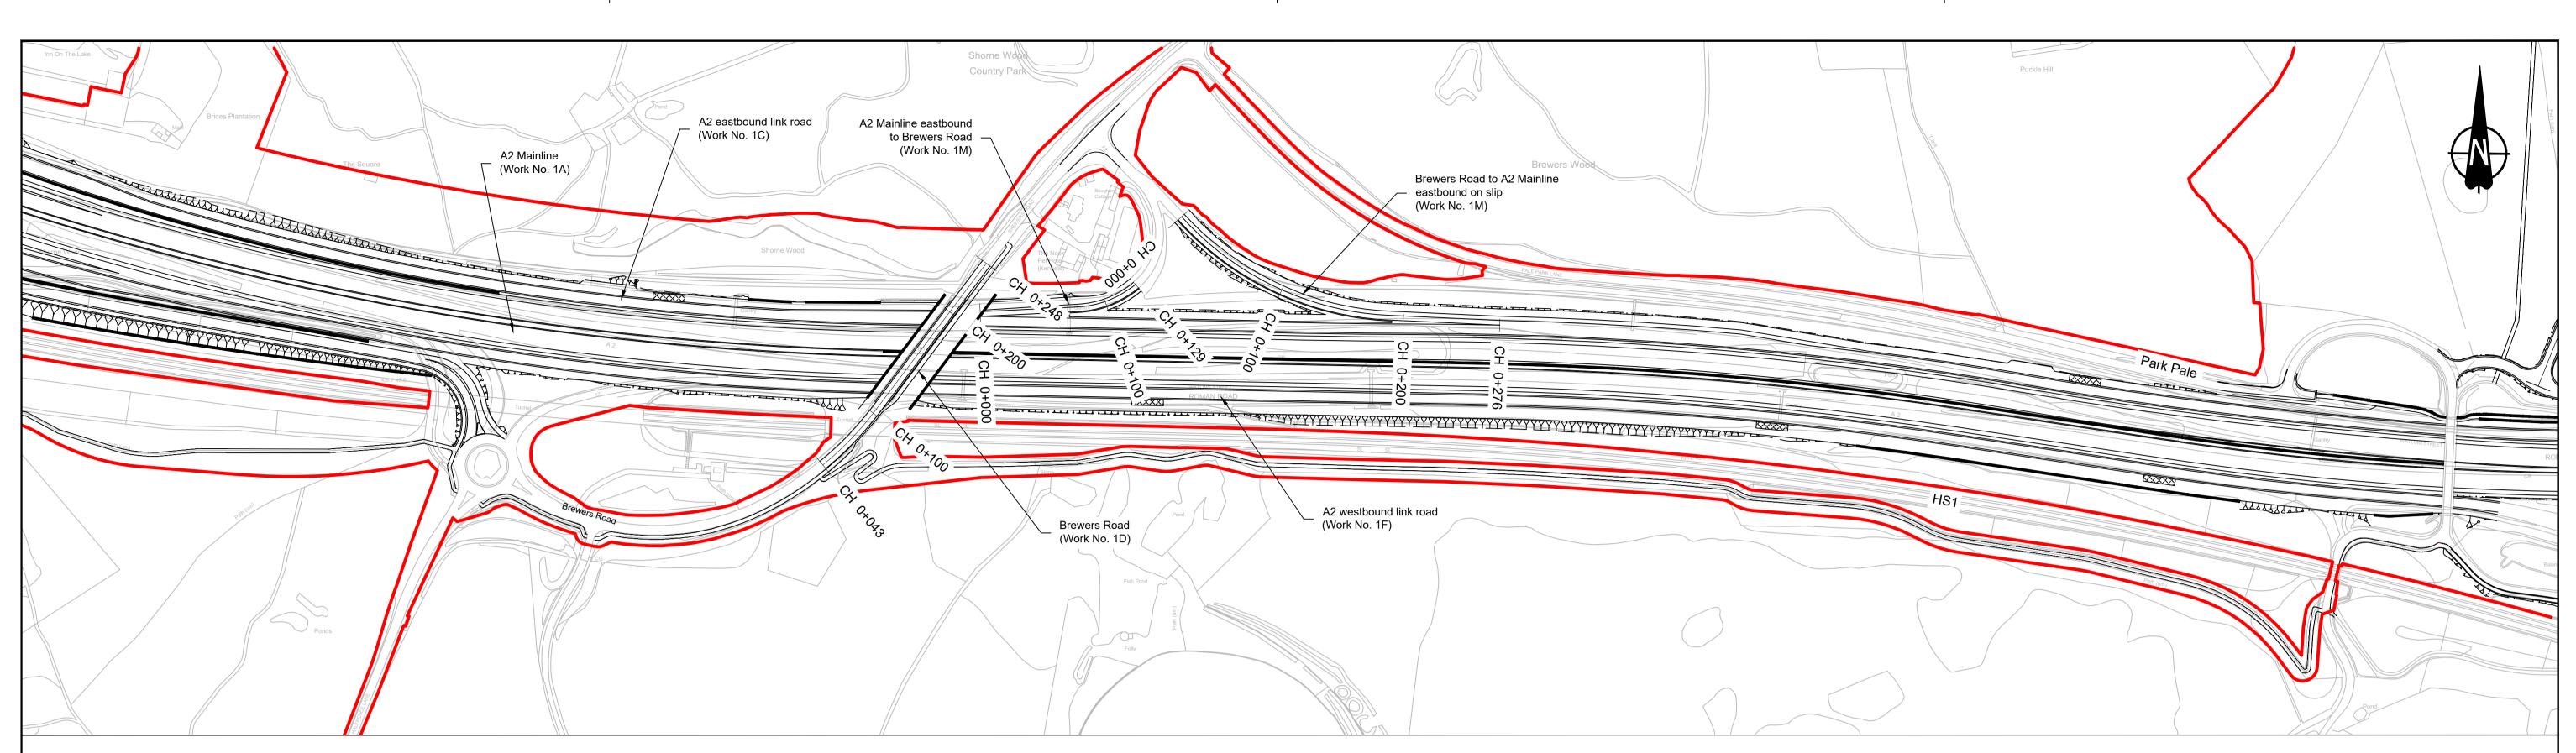

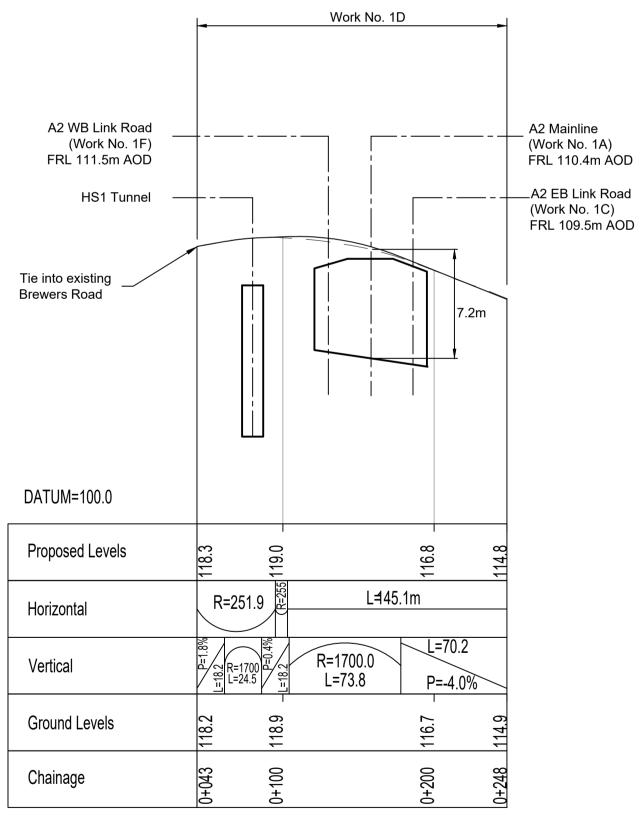

BREWERS ROAD PROFILE

			n copyright and database rights 2022. (NOTES: The proposed works shown are illustrative only and will be subject to change as part of detailed design development. Any changes will be limited to being within the constraints included in the Development Consent Order (application document reference TR010032/APP/3.1). These plans should be read in conjunction with Schedule 1 (Authorised Development) of the Development Consent Order (application document reference TR010032/APP/3.1). Do not scale from this drawing. All dimensions are in metres unless stated otherwise. All levels are in metres relative to the Ordnance Datum. Profile uses an exaggerated scale of 1 horizontal : 10 Vertical. 	
P01	S8	19/10/2022	DCO Application	LY	BB	ASB	0. FIDILE USES ALL EXAUGUERATED SCALE OF I HOLIZOIRAL. TO VERICAL.	
Rev	Status	Rev. Date	Purpose of revision	Drawn	Chck'd	Apprv'd		



A2 Mainline (Work No. 1A) FRL 110.4m AOD

(Work No. 1C) FRL 109.5m AOD

	Work No	o. 1M
DATUM=102.0		
Proposed Levels	108.7	105.5
Horizontal	L= 76.9	R=80.0
Vertical	R=10000 R=10000 L=80.2	0.0 R=806.0 L=31.8
Ground Levels	108.6	105.5 105.1
Chainage	000+0	0+100 0+129

A2 MAINLINE EASTBOUND TO BREWERS ROAD PROFILE


DATUM=92.0 Proposed Levels

Horizontal Vertical


Ground Levels

Chainage

BREWERS ROAD TO A2 MAINLINE EASTBOUND ON SLIP PROFILE

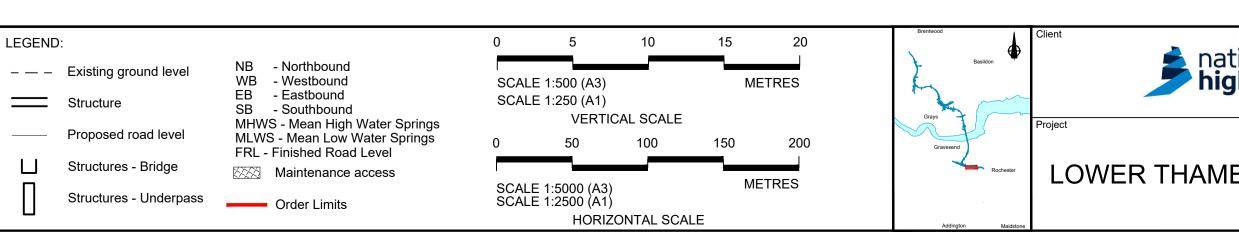

ational	Status DCO Application	Original Size	Revision P01						
ghways	Application Document Number TR010032/APP/2.9	Scale AS S	SHOWN						
9	Drawing title A2/M2 PLAN AND PROFILES								
	REGULATION 5(2)(o) AND	6(2)							
IES CROSSING	SHEET 3								
	Drawing Number HE540039-CJV-BOP-SZA_RX000000DR-CH- 10103								
	HE540039-CJV-BOP-SZA_R	(000000DR-CH	I-10103.dwg						

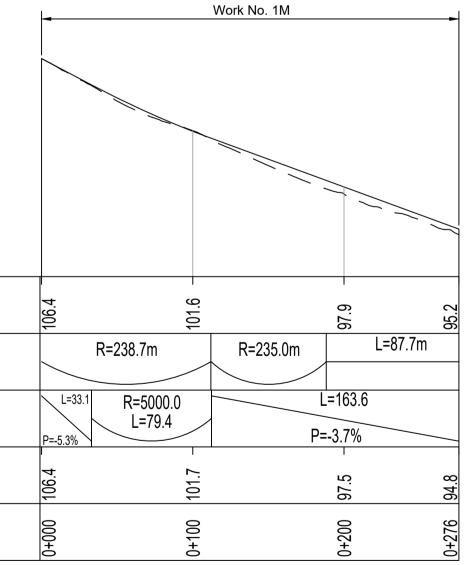


				Brewers Road	
puod				24	
Addiddddddddddddddawranna Addidddddddddddddawranna Emmanuna Emmanuna			poom aurous		
			DATUM=76.0		
			Proposed Levels	112.9	110.9
			Horizontal	₹ R=2880.0m	
			Vertical	L= P=-2.0	=123.0
			Ground Levels	112.00	112.0
			Chainage	0+000	0+100
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	1. The proposed w design developr	vorks shown are illustrative only and nent. Any changes will be limited to onsent Order (application document ould be read in conjunction with Sch	being within the constraints	included in the	


Rev	Status	Rev. Date	Purpose of revision	Drawn	Chck'd	Apprv'd	
P01	S8	19/10/2022	DCO Application	LY	BB	ASB	 Development Consent Order (application document reference TR010032/APP/3.1). Do not scale from this drawing. All dimensions are in metres unless stated otherwise. All levels are in metres relative to the Ordnance Datum. Profile uses an exaggerated scale of 1 horizontal : 10 Vertical.





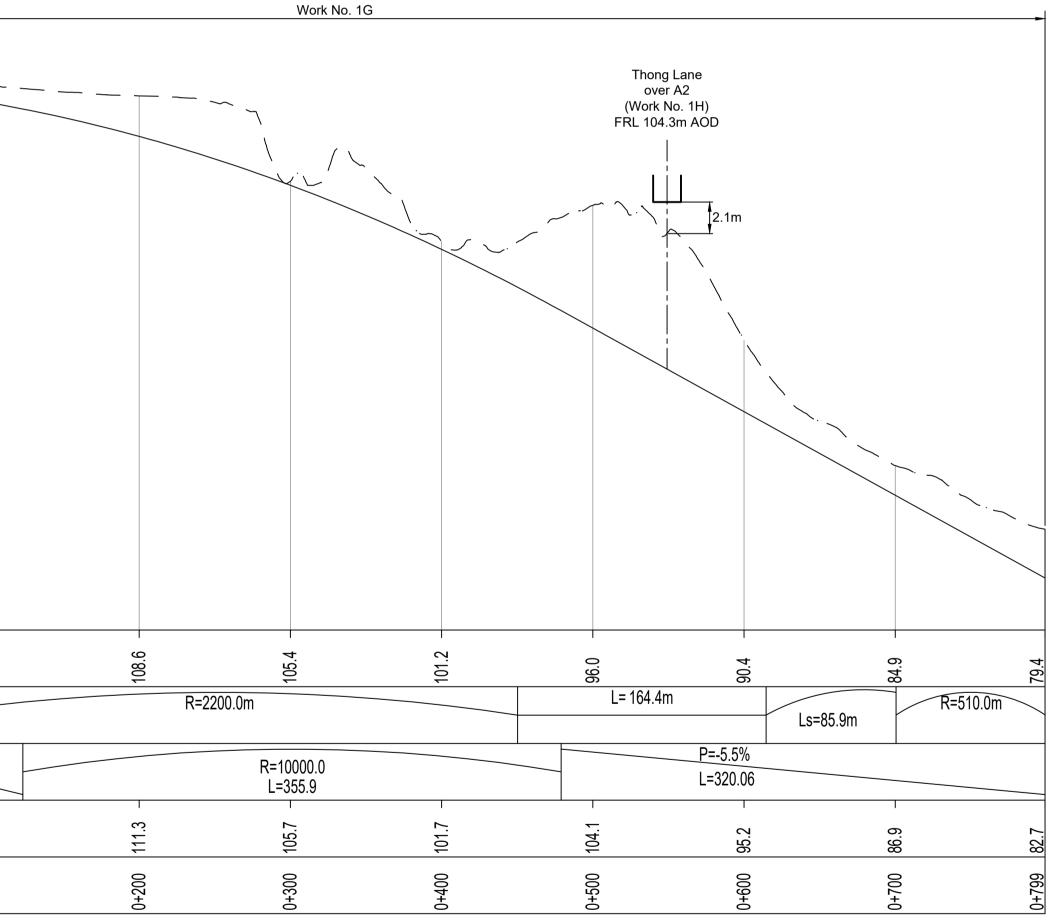


WESTBOUND LINK ROAD TO A122 LTC NORTHBOUND PROFILE

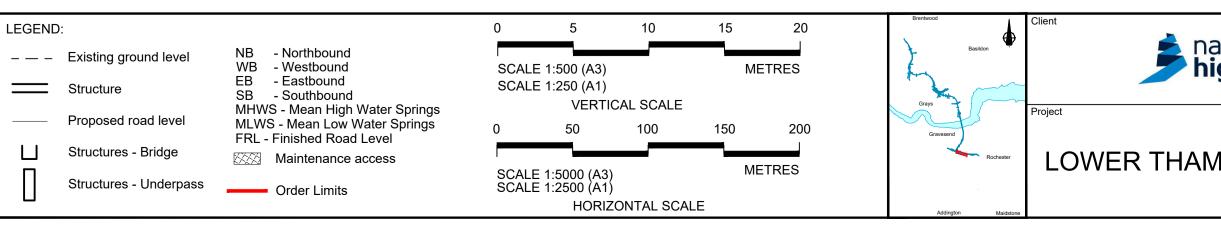



ational	Status DCO Application	Original Size	Revision P01					
ational ighways	Application Document Number TR010032/APP/2.9		SHOWN					
iginiays	Drawing title A2/M2 PLAN AND PROFILES							
	REGULATION 5(2)(0) AND 6(2)							
MES CROSSING	SHEET 4							
	Drawing Number HE540039-CJV-BOP-SZA_RX000000DR-0	CH-10104	4					


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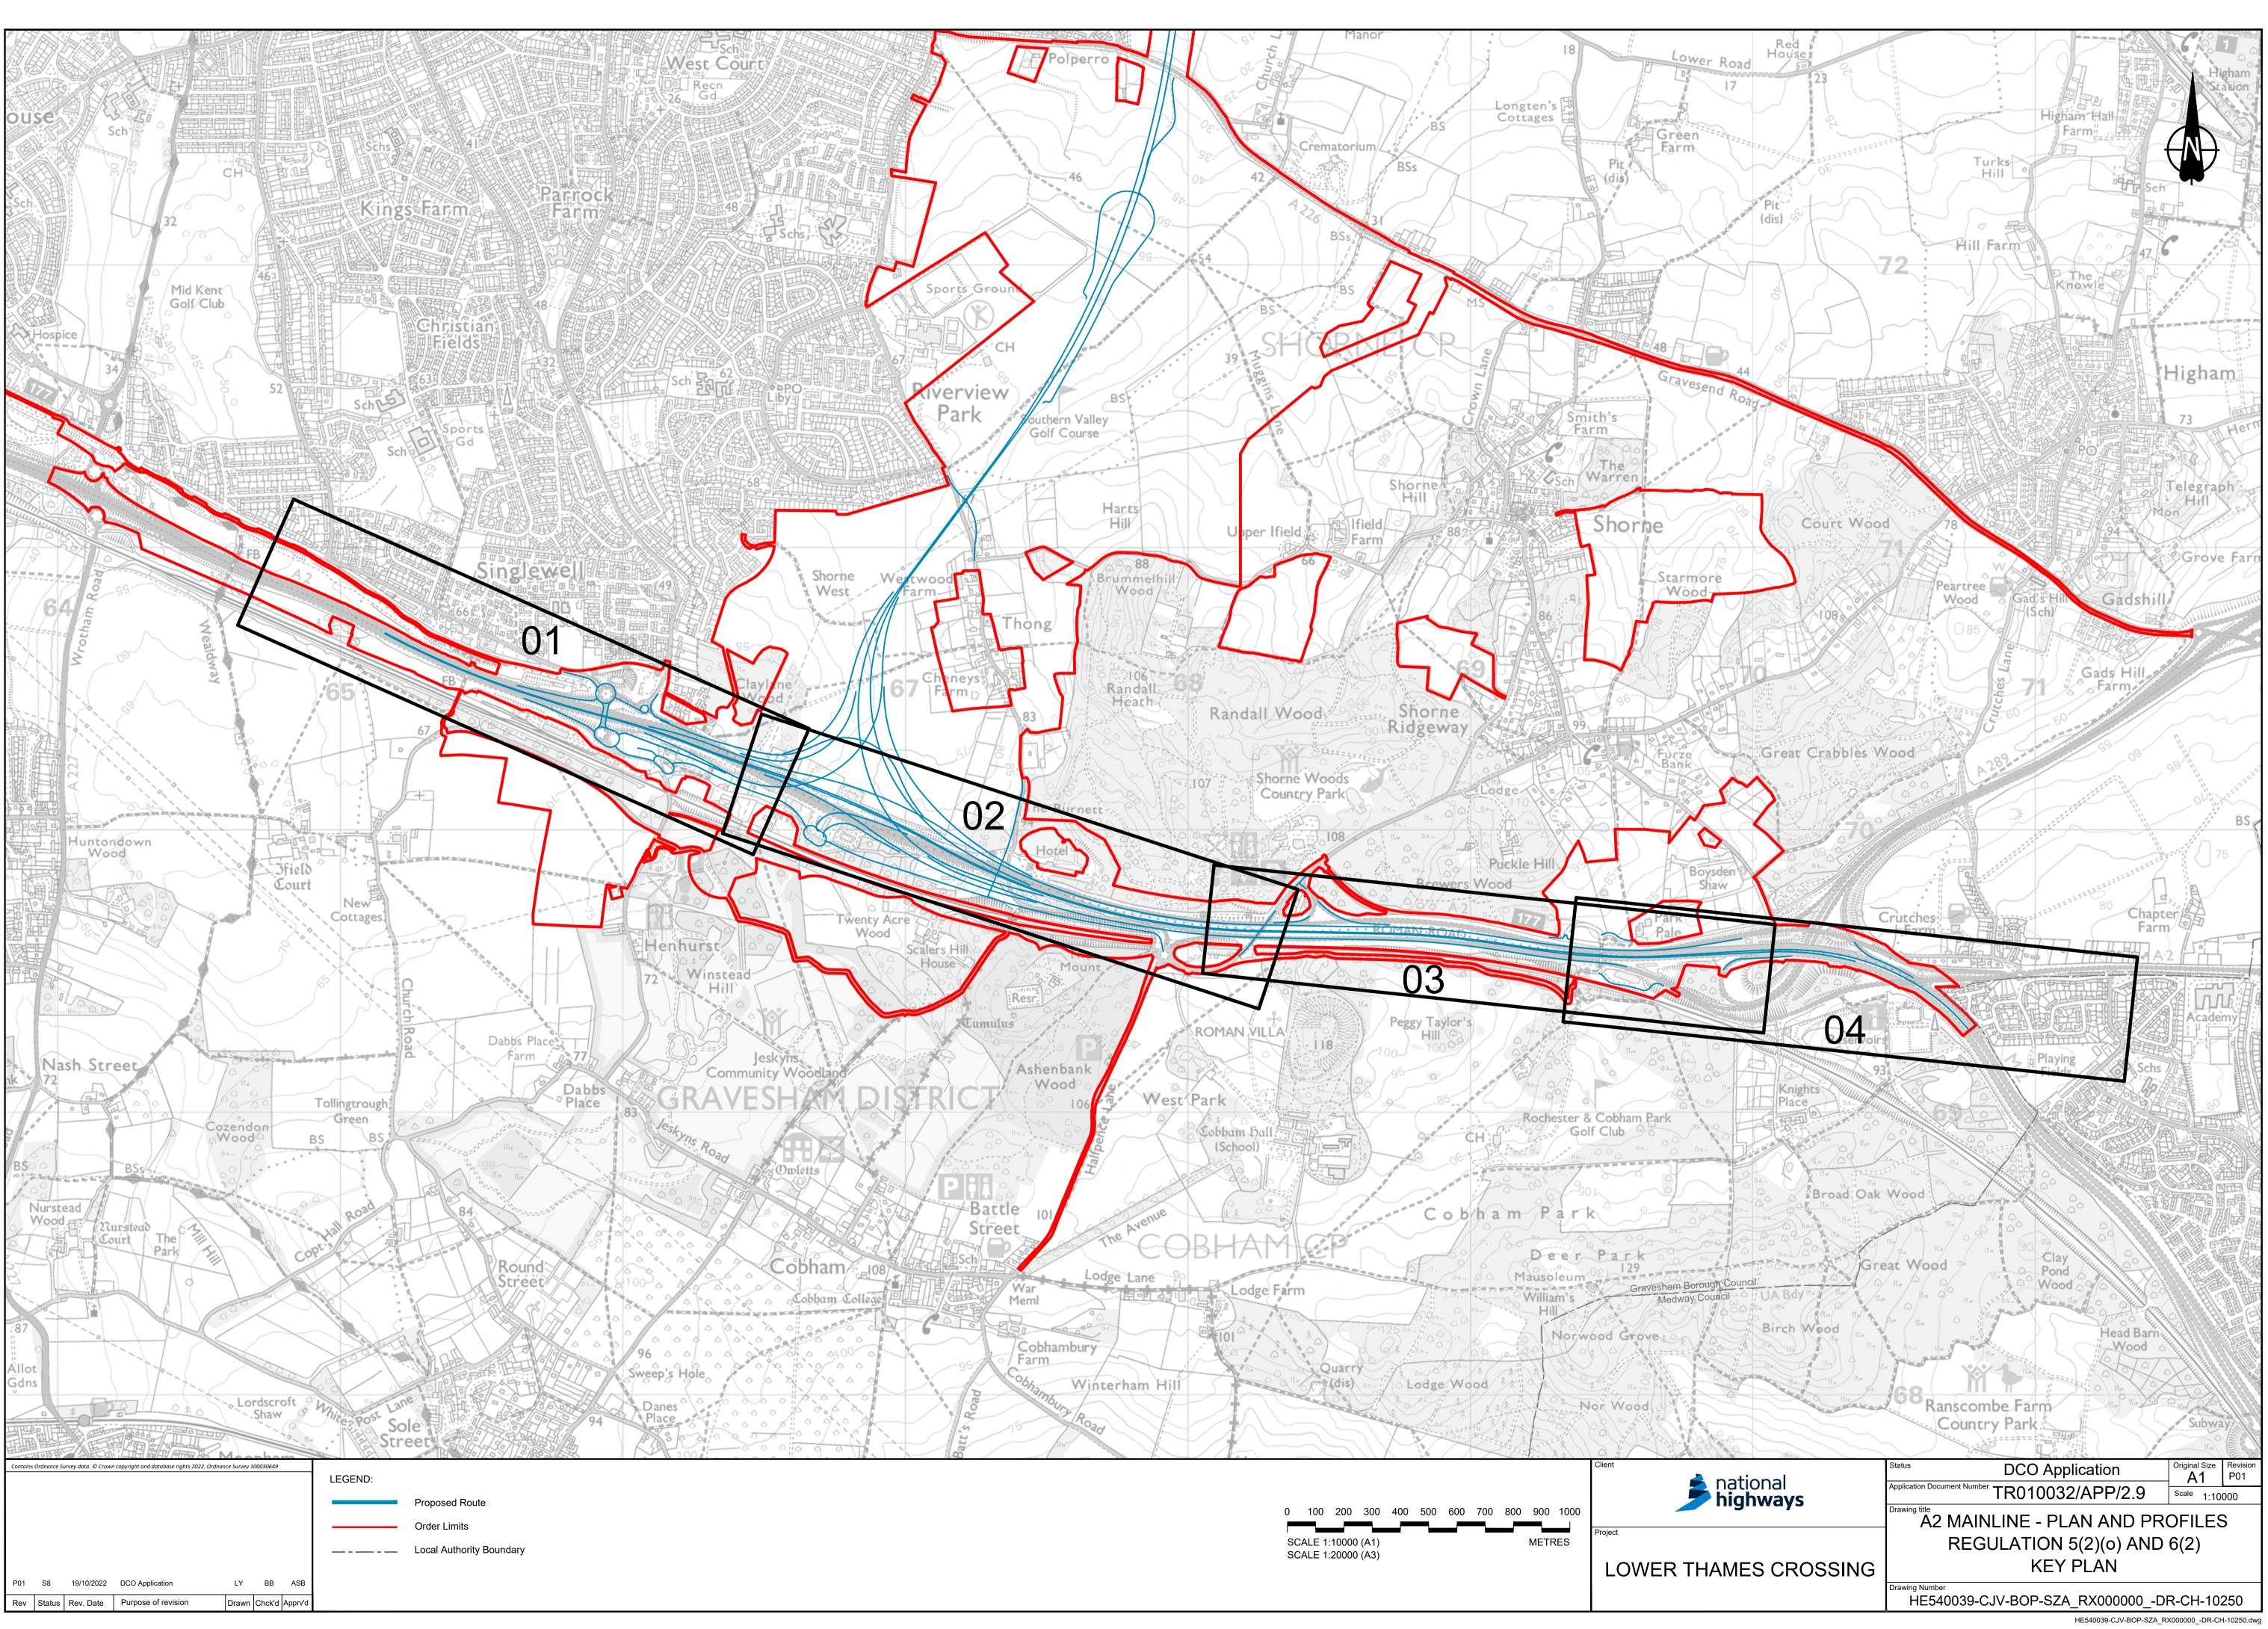


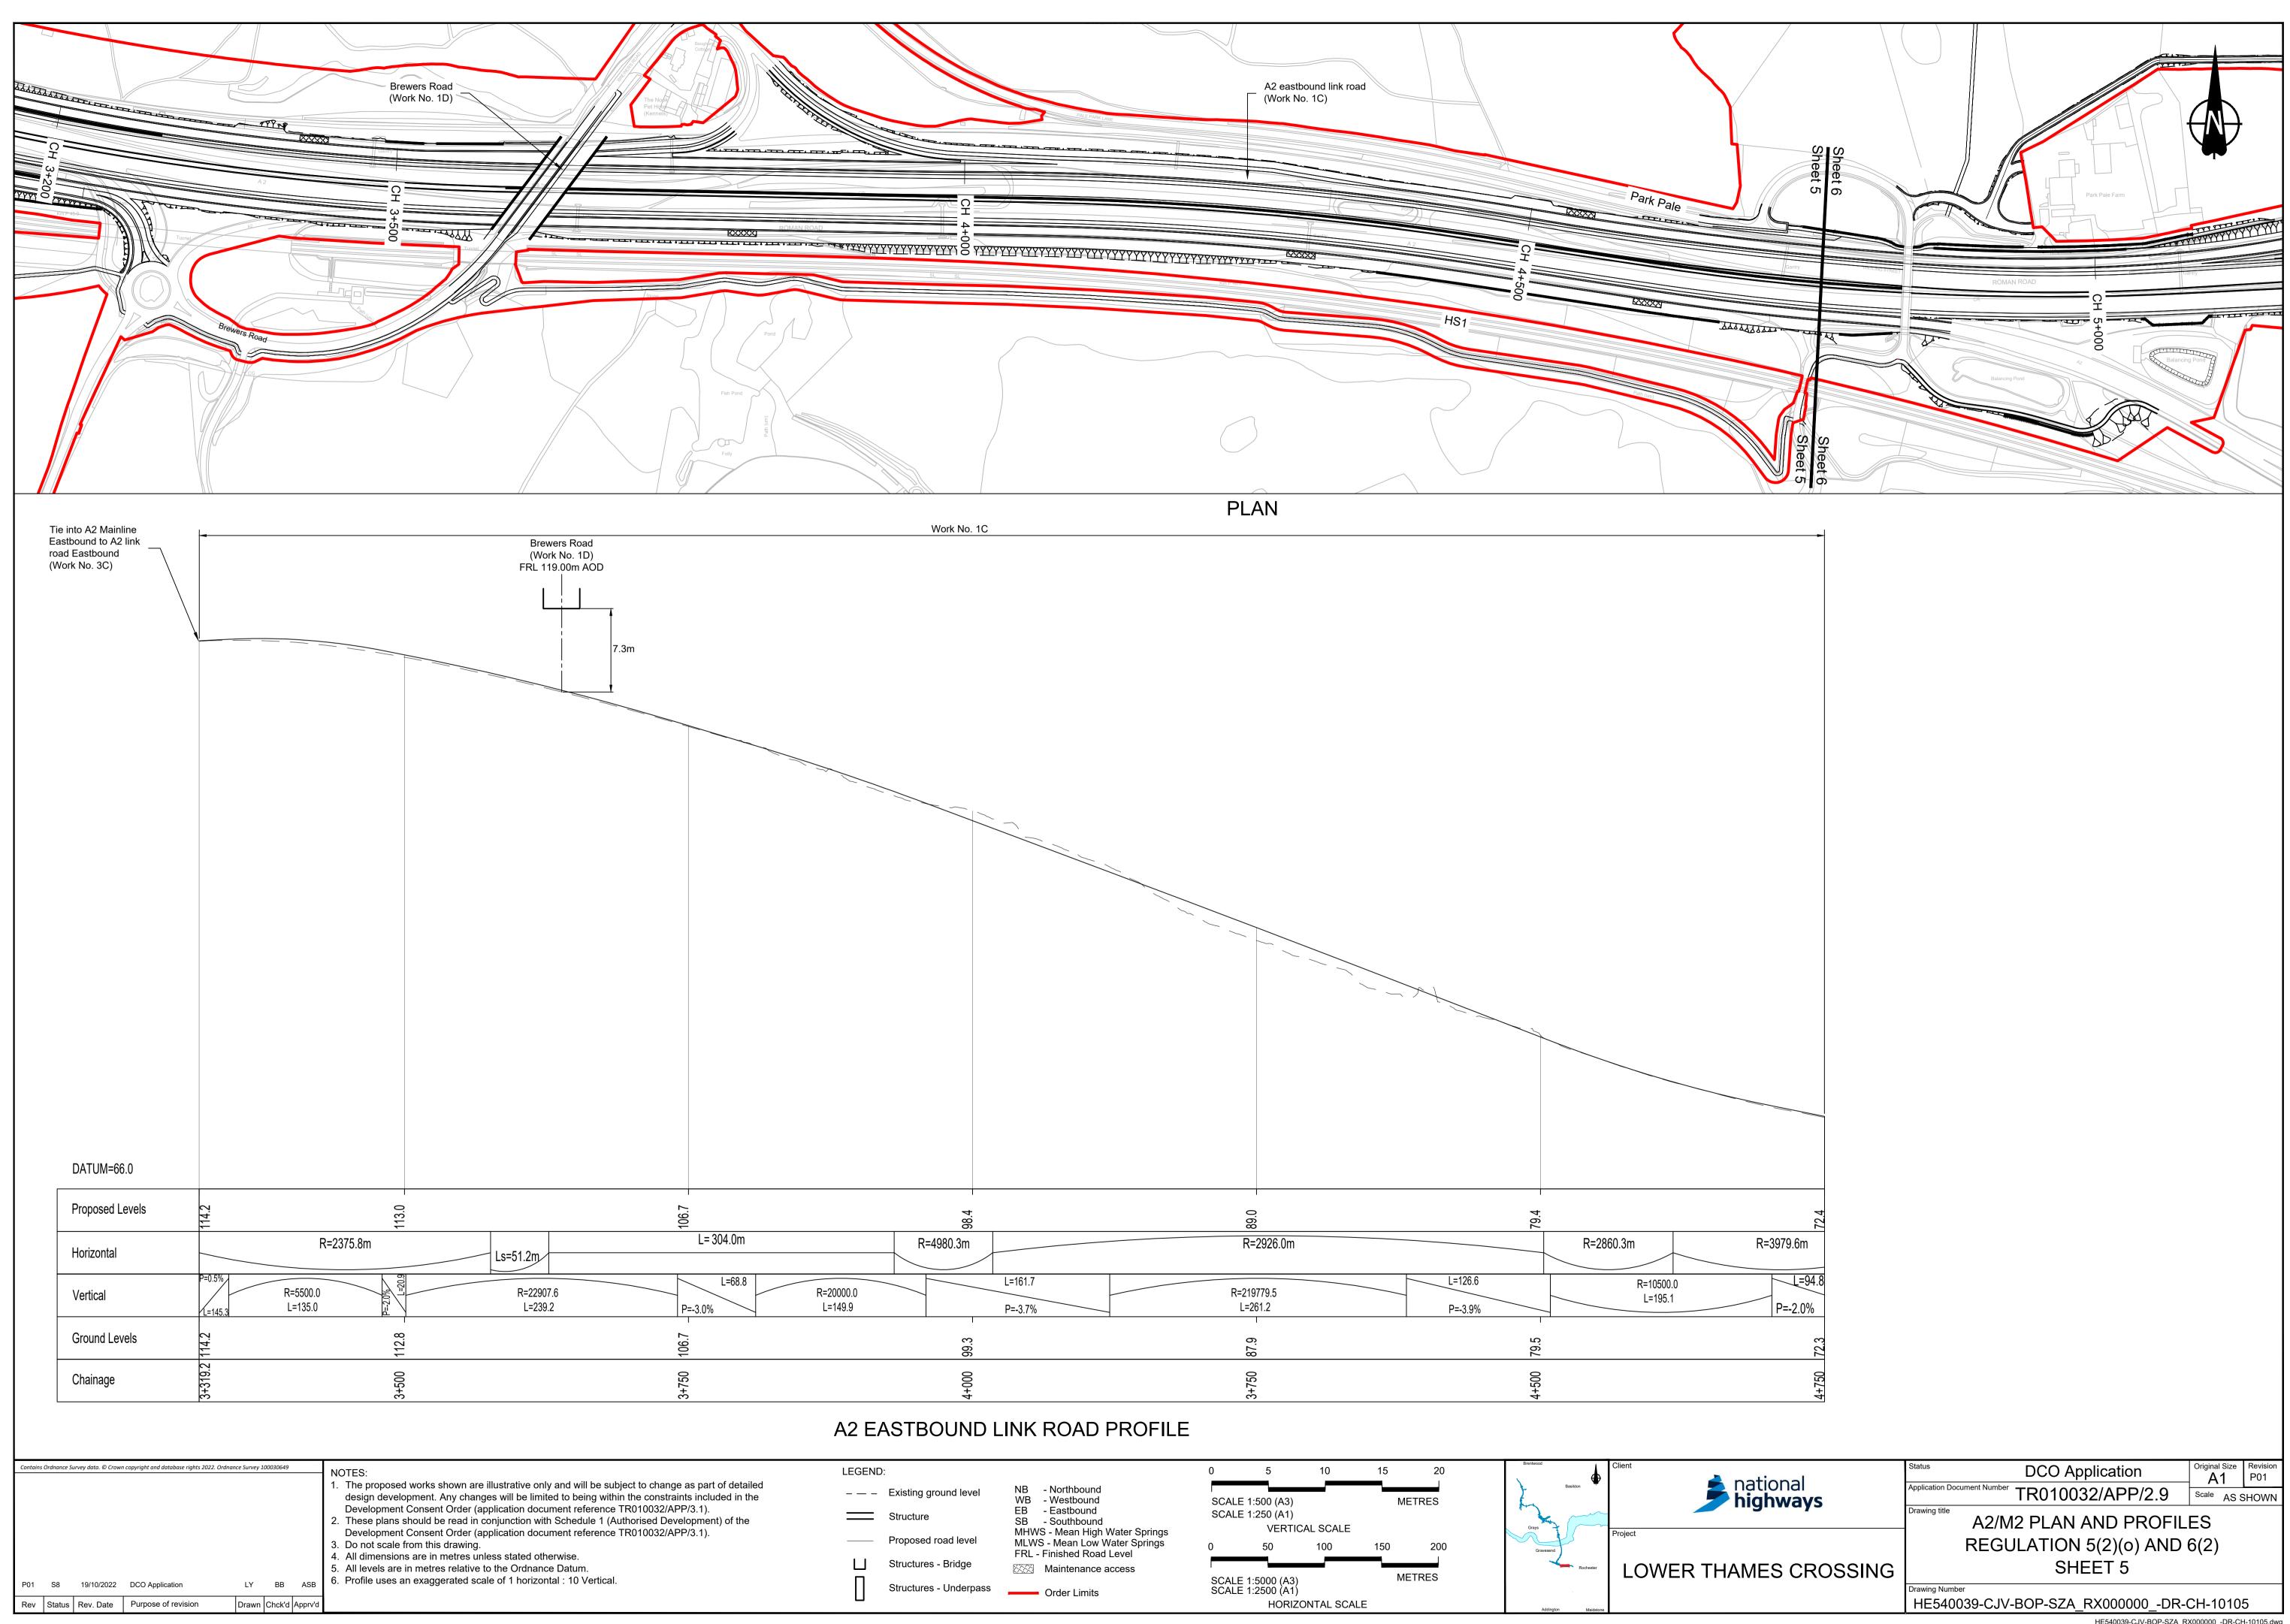
5- Boughligt Cottage	Brewers	Wood	
Fish Pond (up) ga			
Ponti		Golf Course Peg	gy Taylor's Hill
tains Ordnance Survey data. © Crown copyright and database rights 2022. Ordnance Survey 10	NOTES: 1. The proposed works sho design development. Any Development Consent O 2. These plans should be re Development Consent O 3. Do not scale from this dra	wn are illustrative only and will be subject to chan v changes will be limited to being within the const rder (application document reference TR010032/ ead in conjunction with Schedule 1 (Authorised D rder (application document reference TR010032/ awing. tres unless stated otherwise.	raints included in the APP/3.1). evelopment) of the




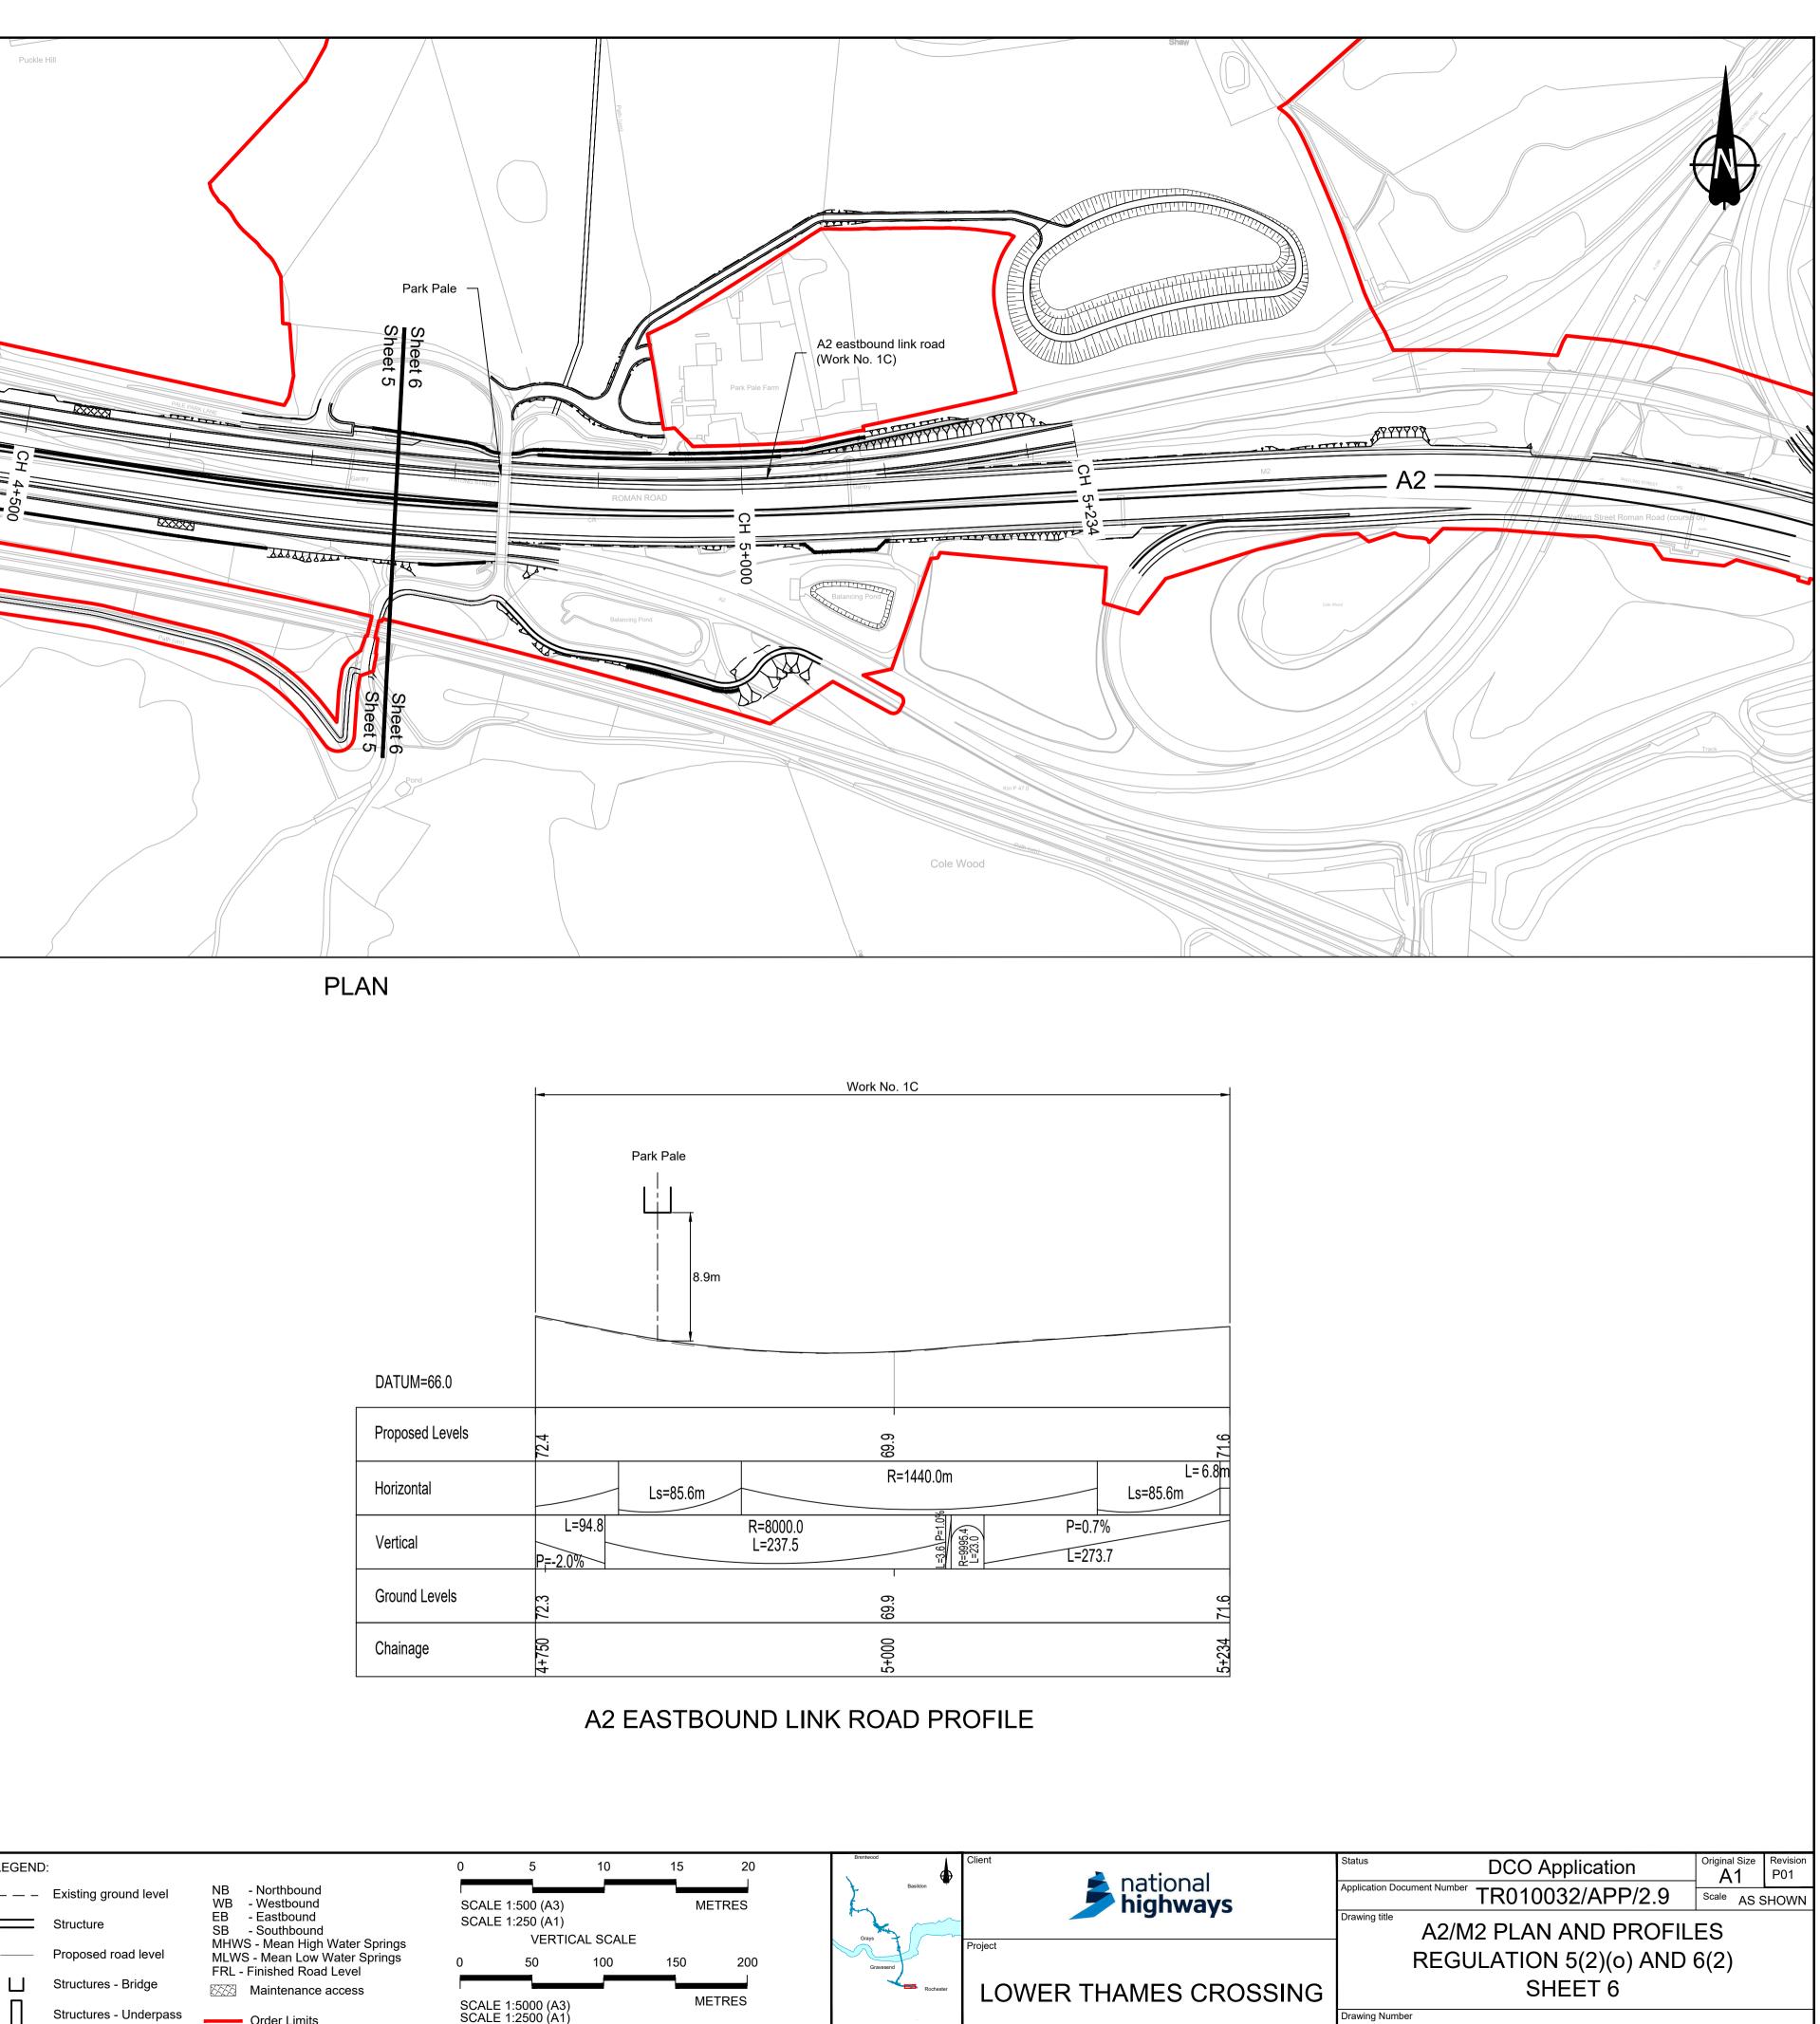

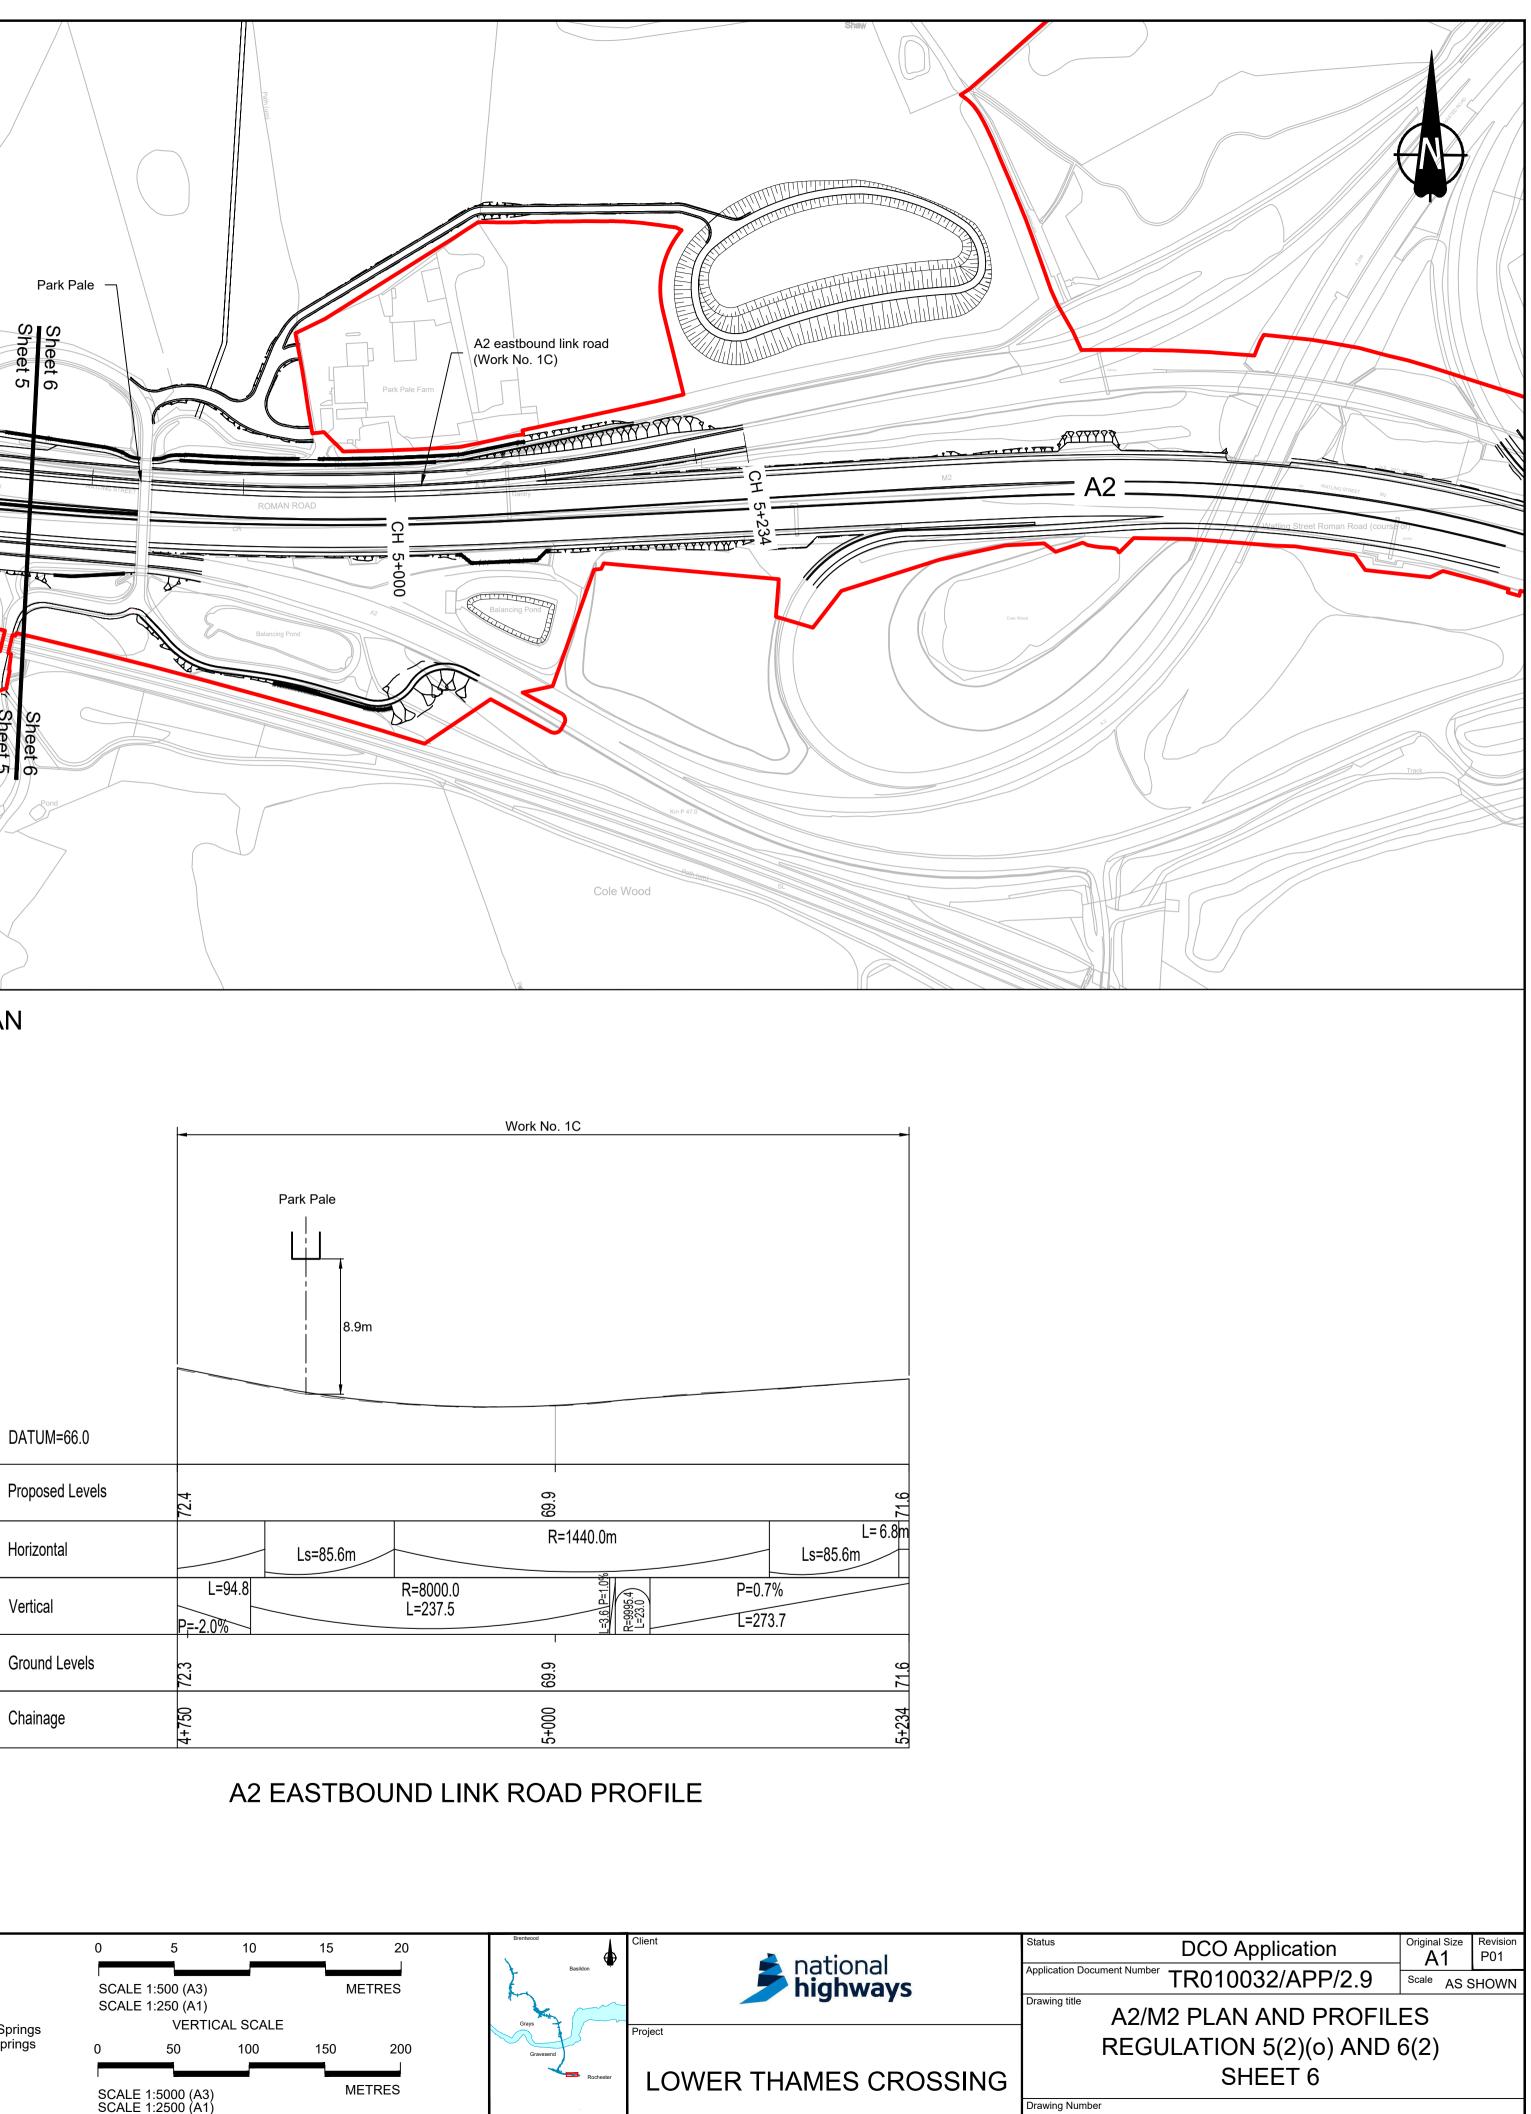


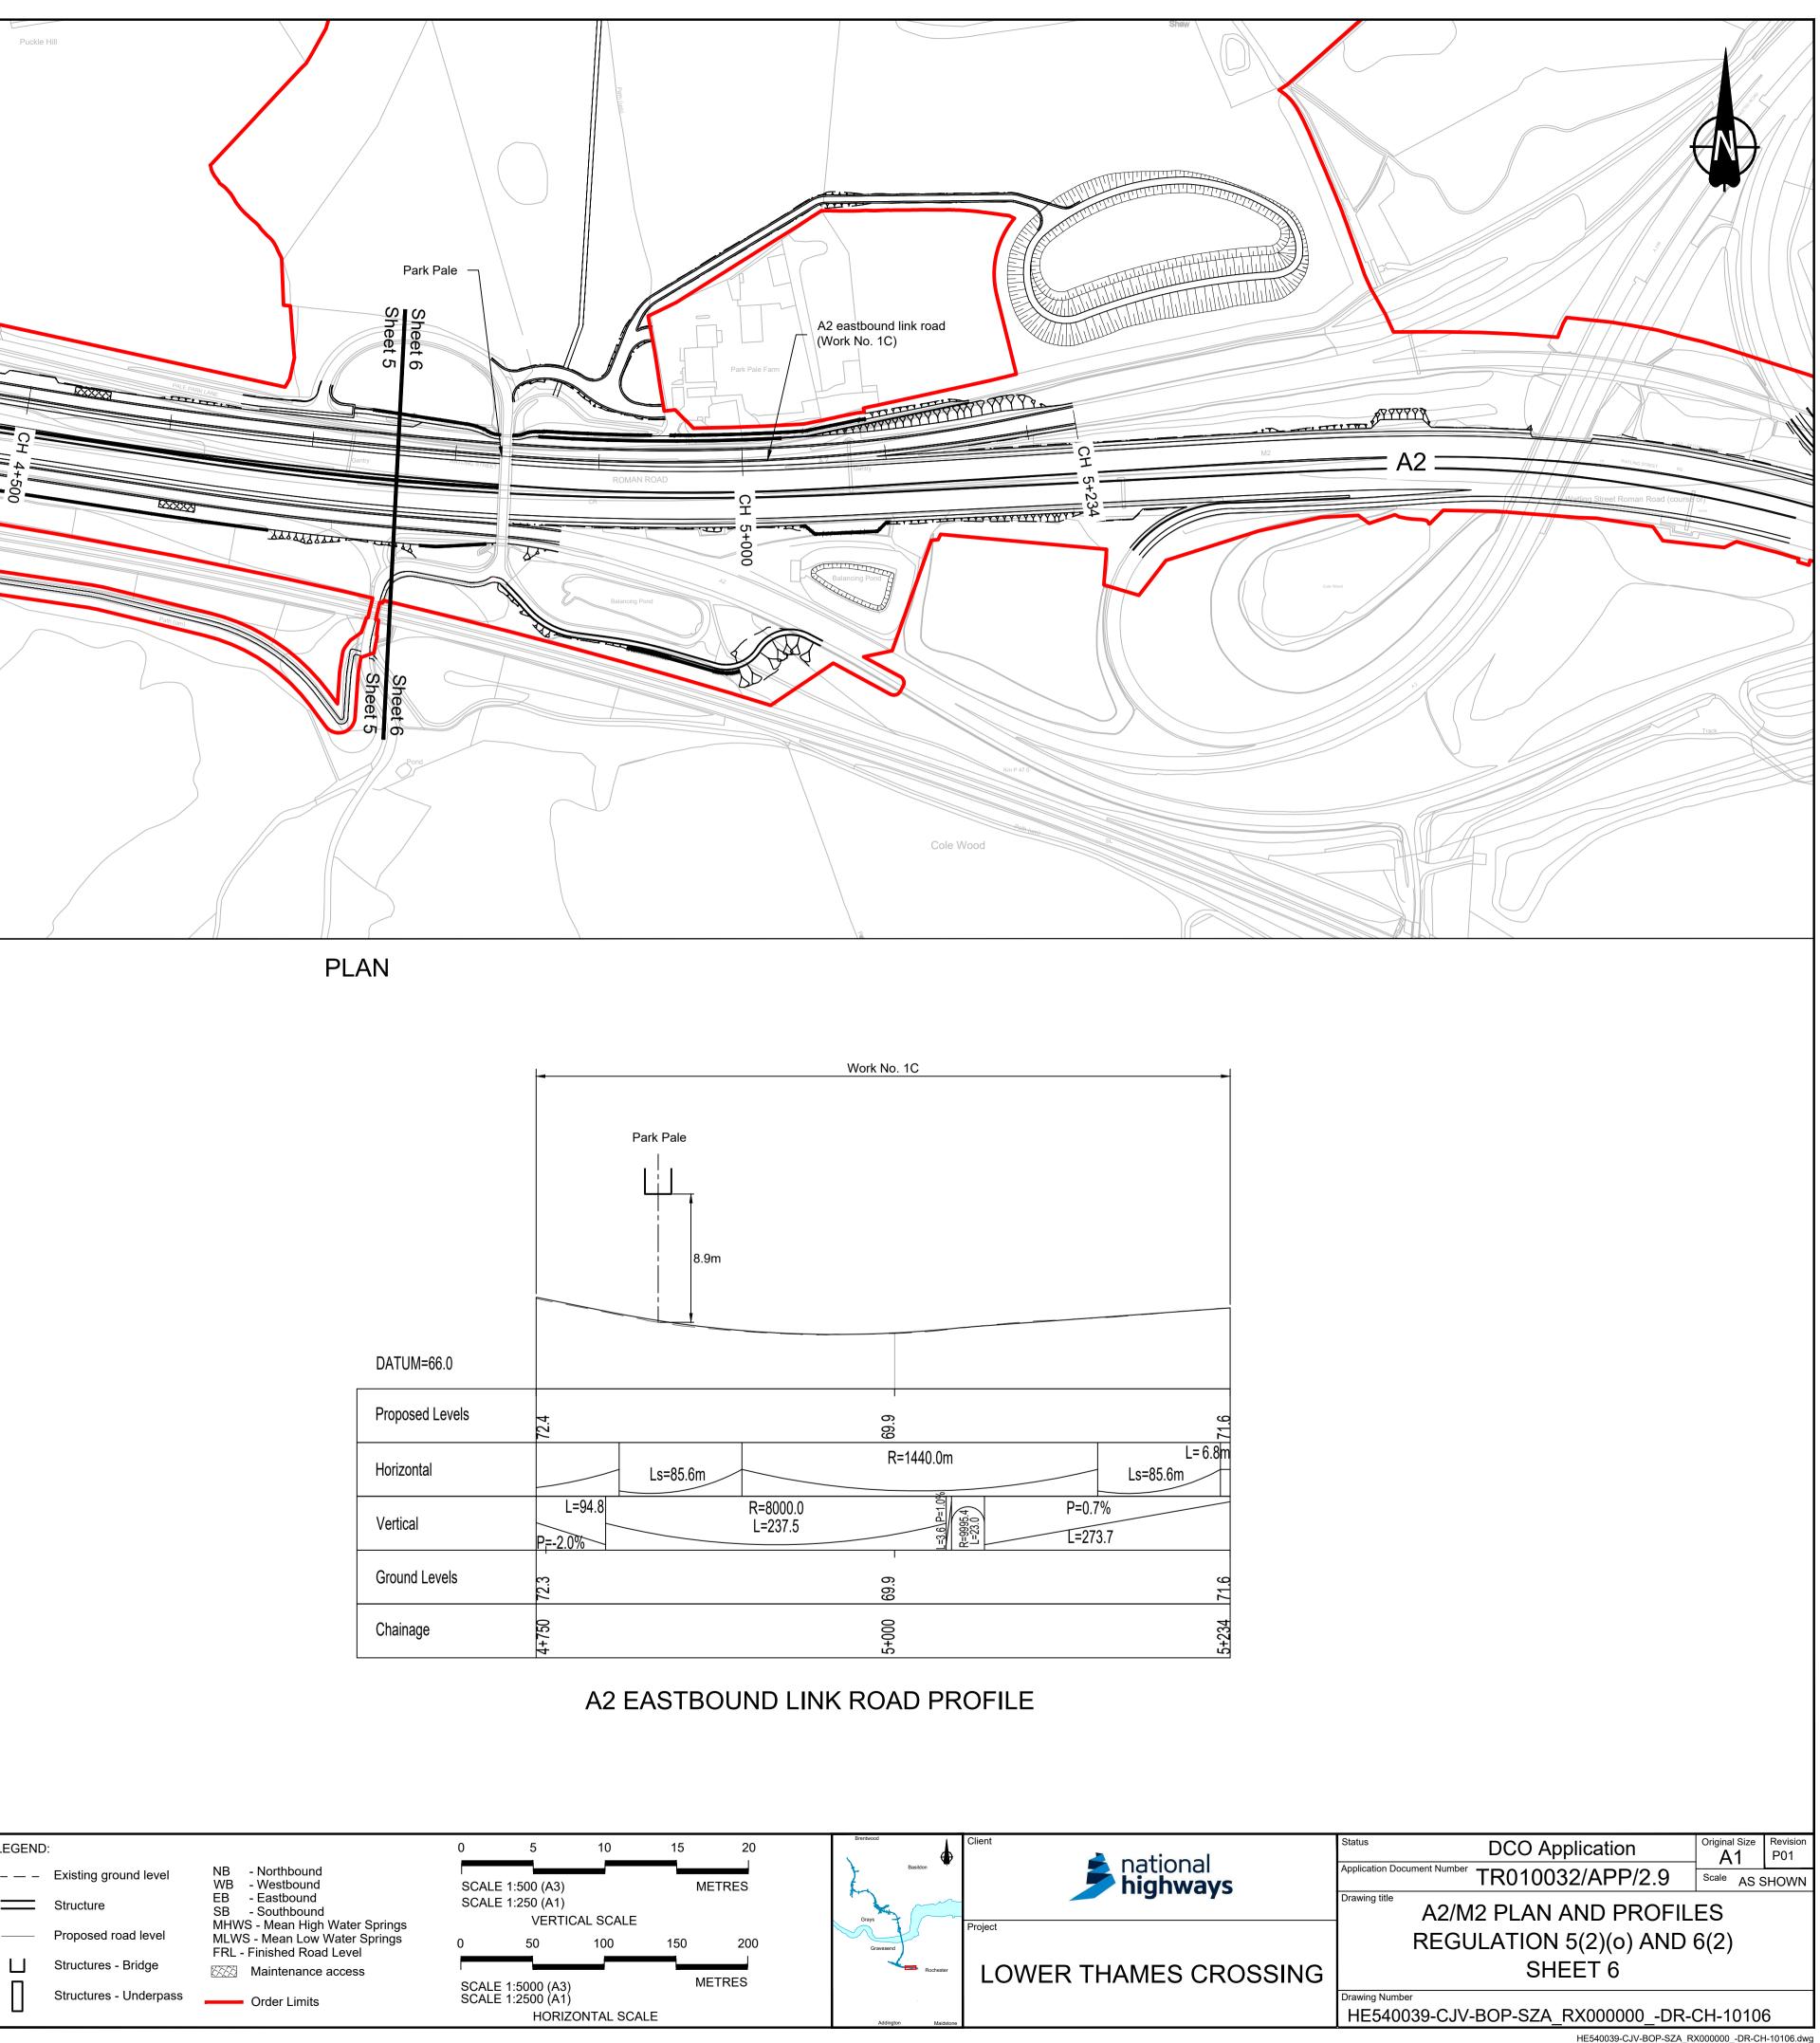

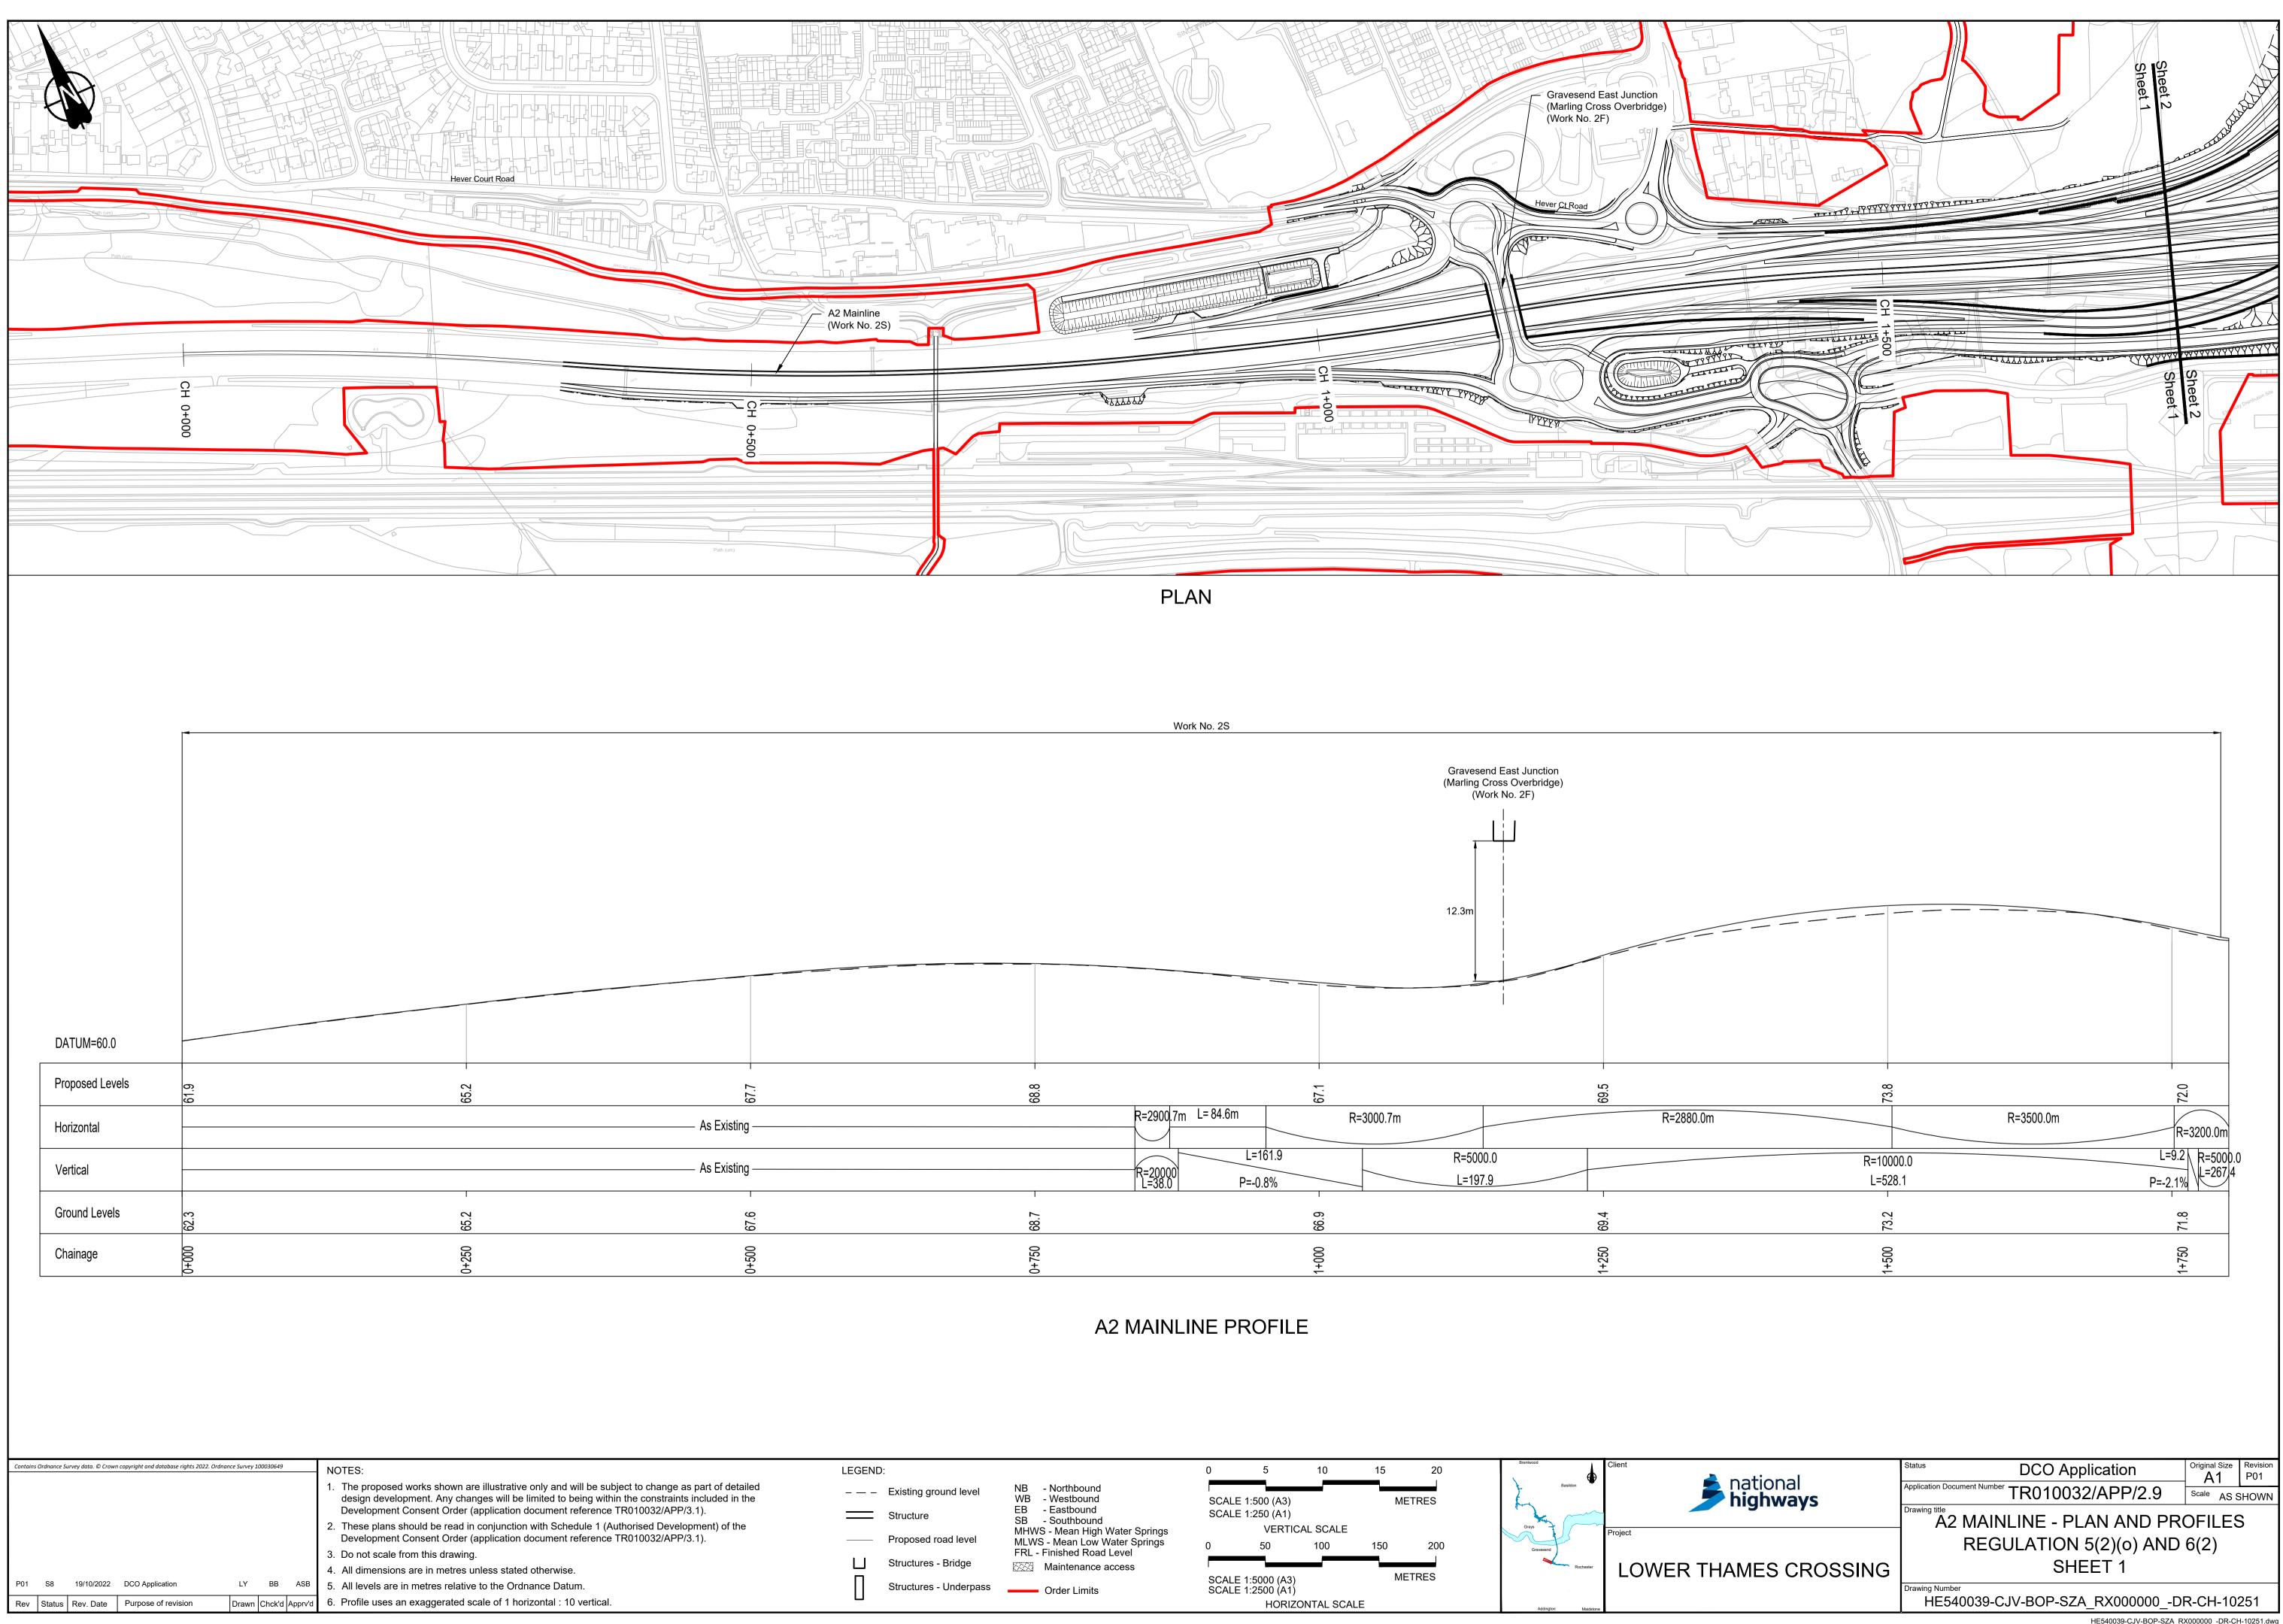

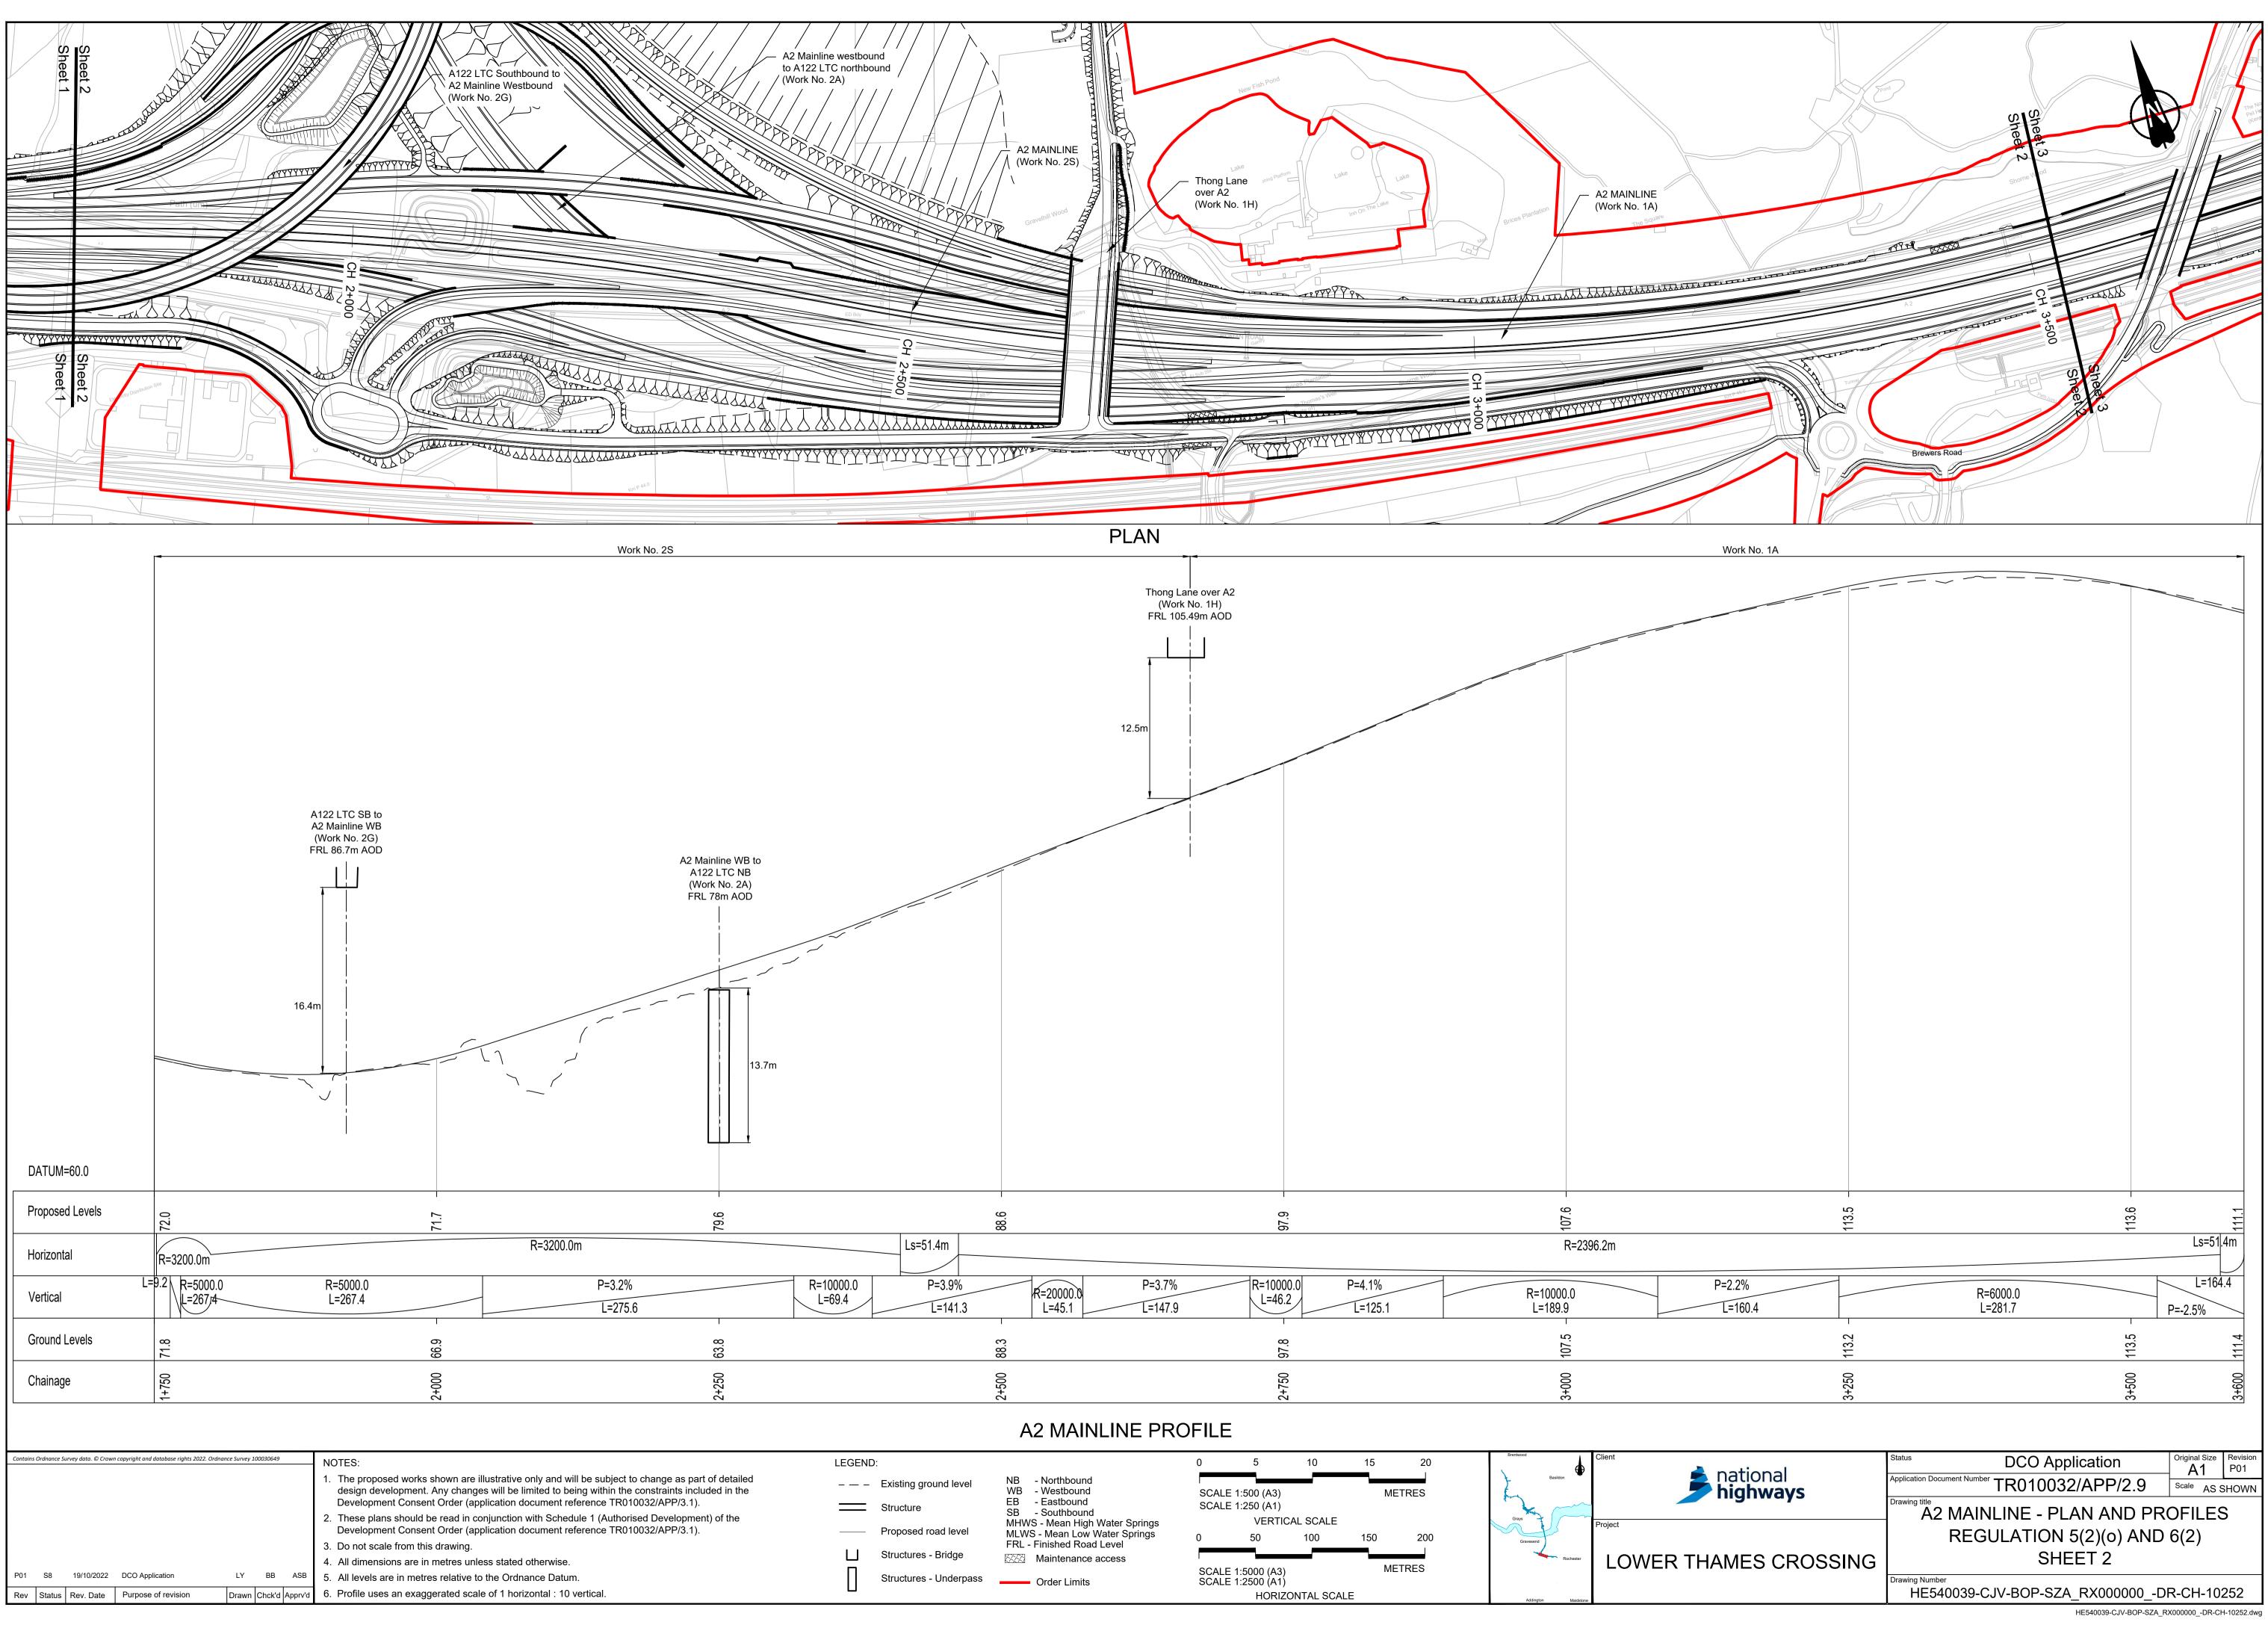


Status DCO Application	Original Size	Revision P01					
Application Document Number TR010032/APP/2.9	a .	SHOWN					
A2 MAINLINE - PLAN AND PROFILES							
REGULATION 5(2)(0) AND 6(2)							
SHEET 2	. ,						
	R-CH-10	252					
	Application DCO Application Application Document Number TR010032/APP/2.9 Drawing title A2 MAINLINE - PLAN AND PRO REGULATION 5(2)(0) AND SHEET 2 Drawing Number	Application DCO Application A1 Application Document Number TR010032/APP/2.9 Drawing title A2 MAINLINE - PLAN AND PROFILES REGULATION 5(2)(0) AND 6(2) SHEET 2					

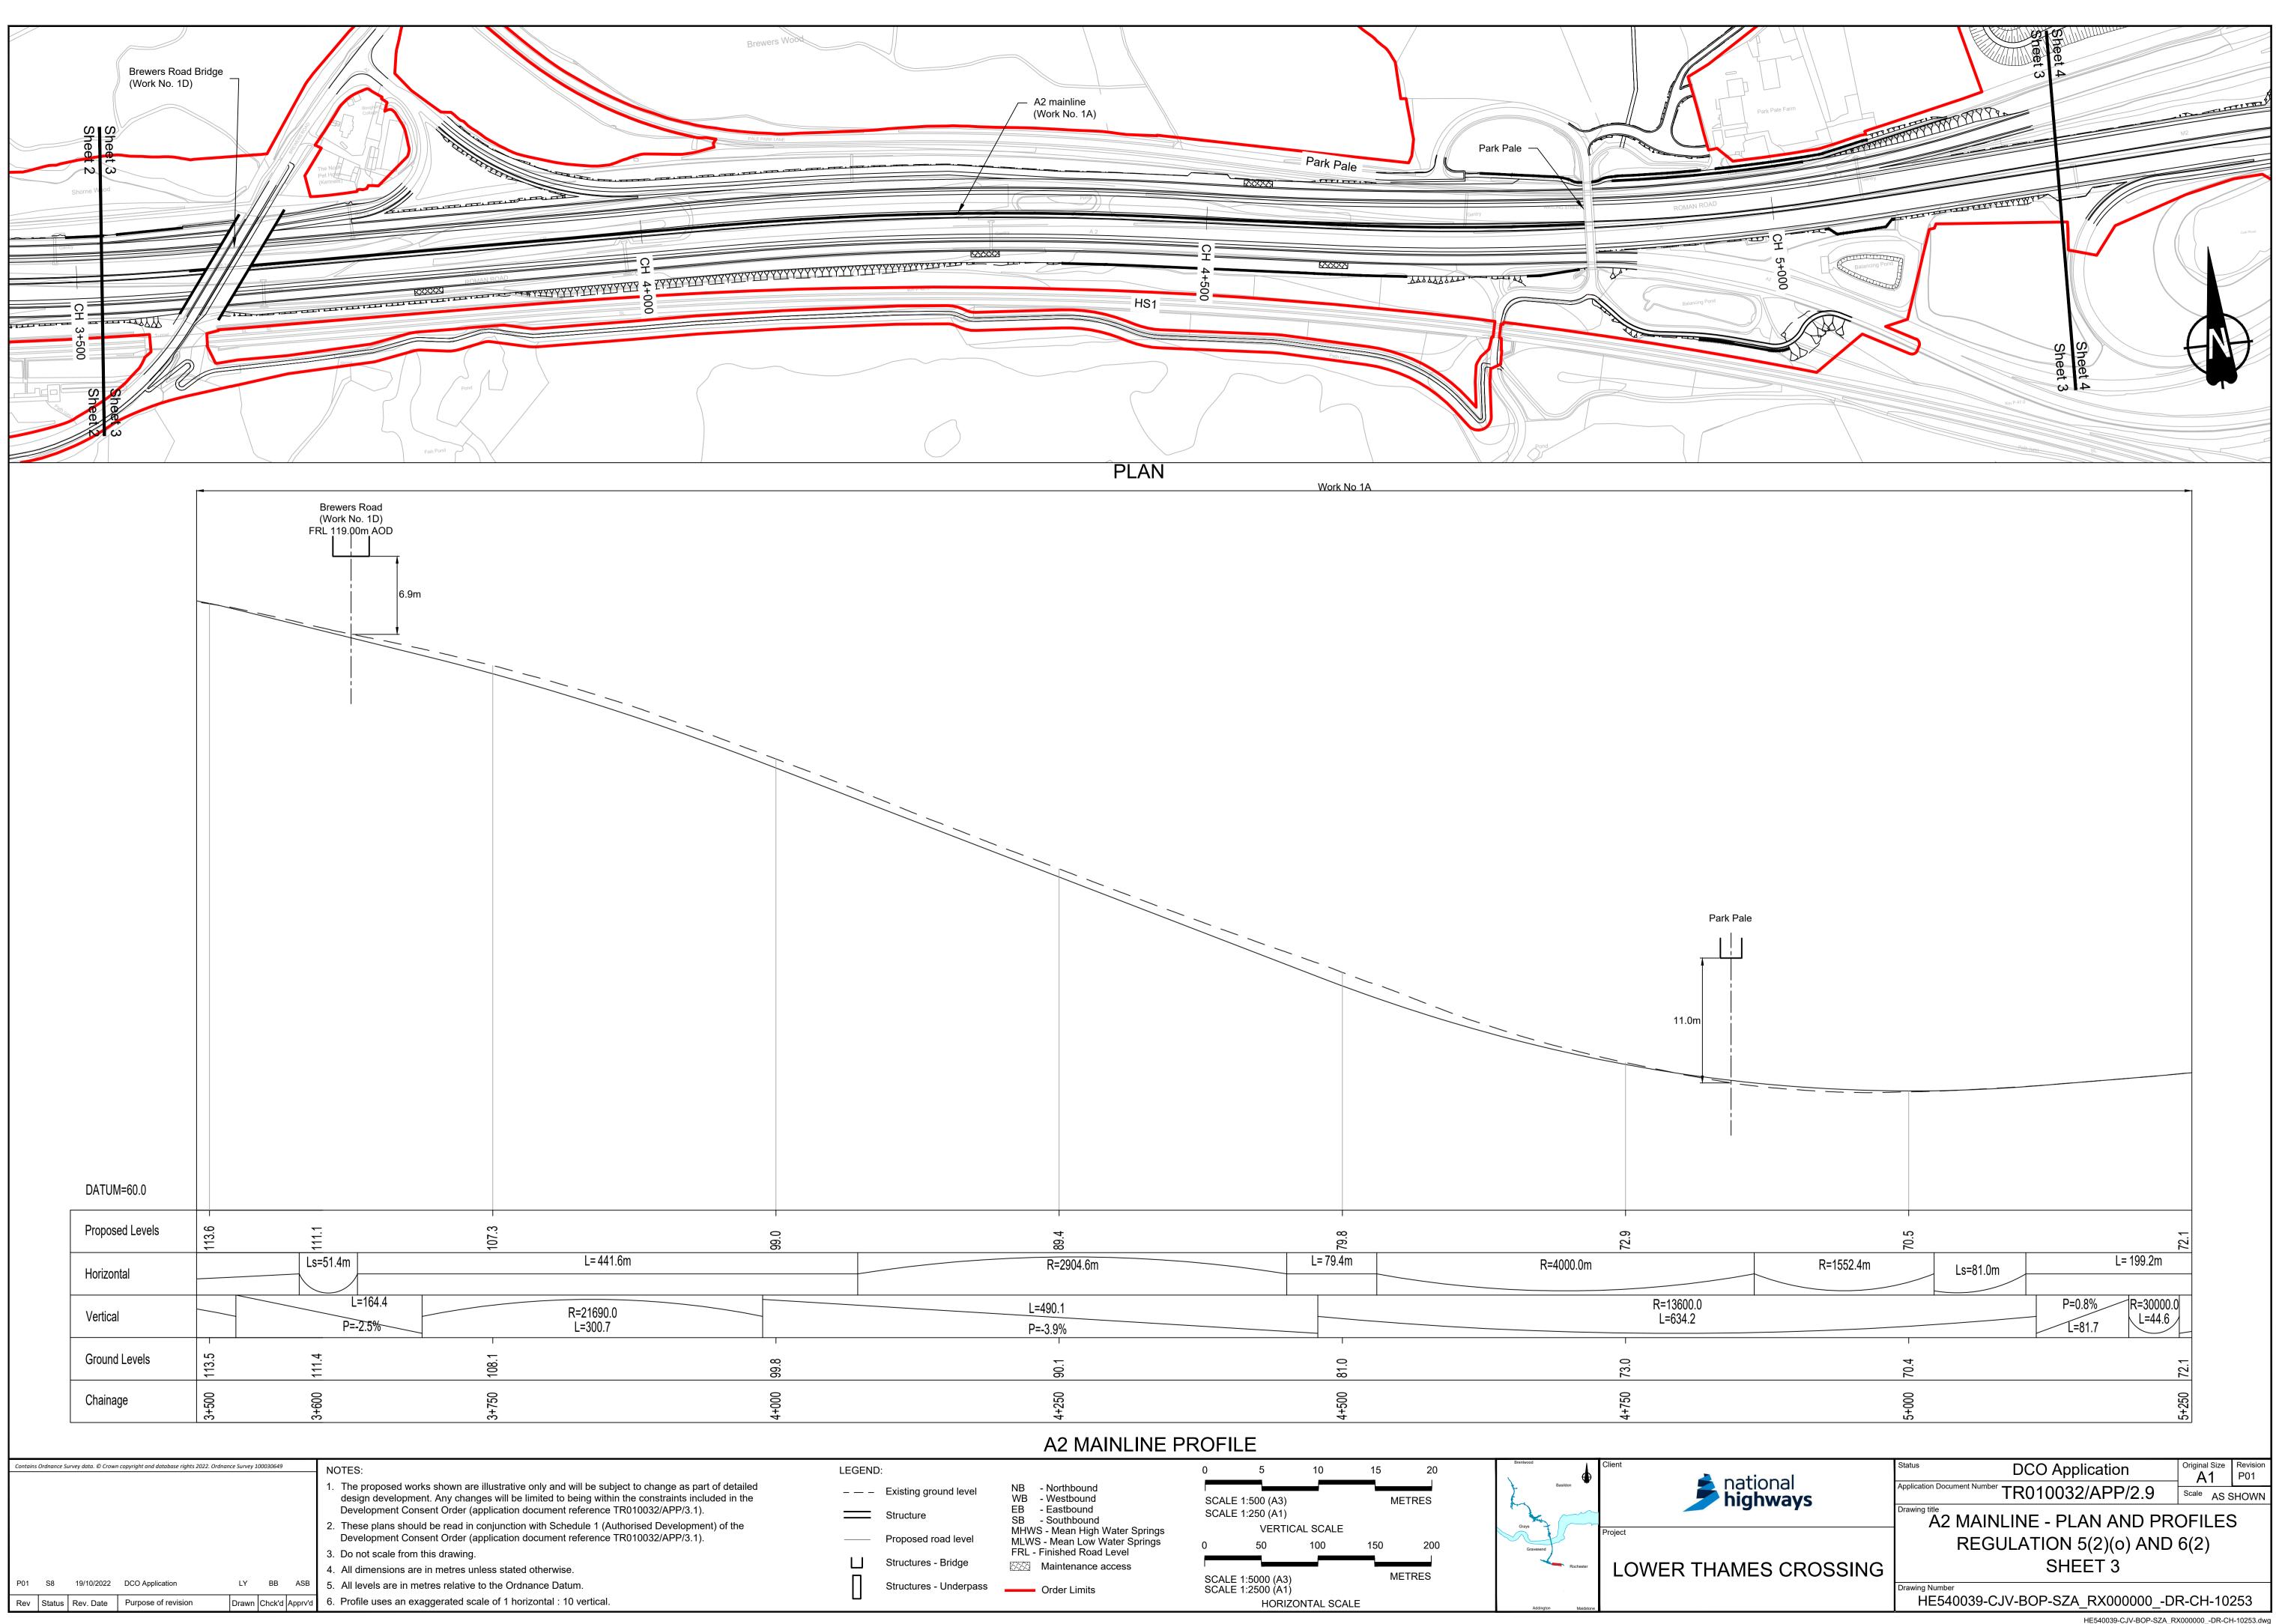


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Balancing Pond		
	Sheet 4	
	15 June 200	
Pond	Cole Wood	
		HS1
	-	
	DATUM=60.0	
	Proposed Levels	
	Horizontal	
		P=1.0%
	Vertical	L=189
	Ground Levels	
	Chainage Chainage	
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Development Cons 3. Do not scale from t	sent Order (application document reference TR010032/APP/3.1).	


P01	S8	19/10/2022	DCO Application	LY	BB	ASB	5. All levels are in metres relative to the Ordnance Datum.
Rev	Status	Rev. Date	Purpose of revision	Drawn	Chck'd	Apprv'd	6. Profile uses an exaggerated scale of 1 horizontal : 10 vertica

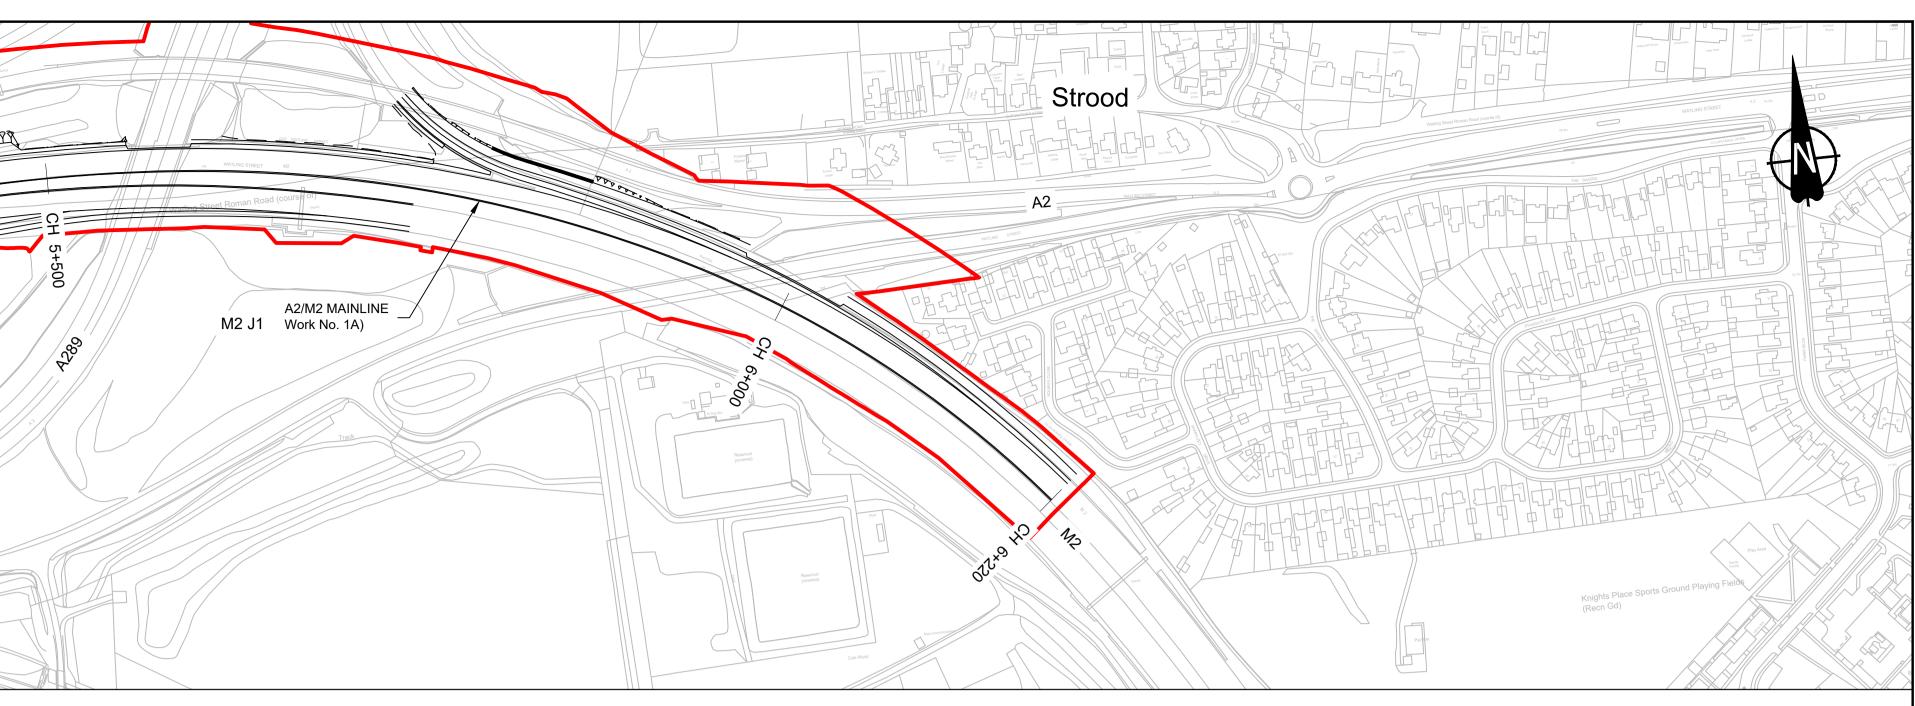

PLAN

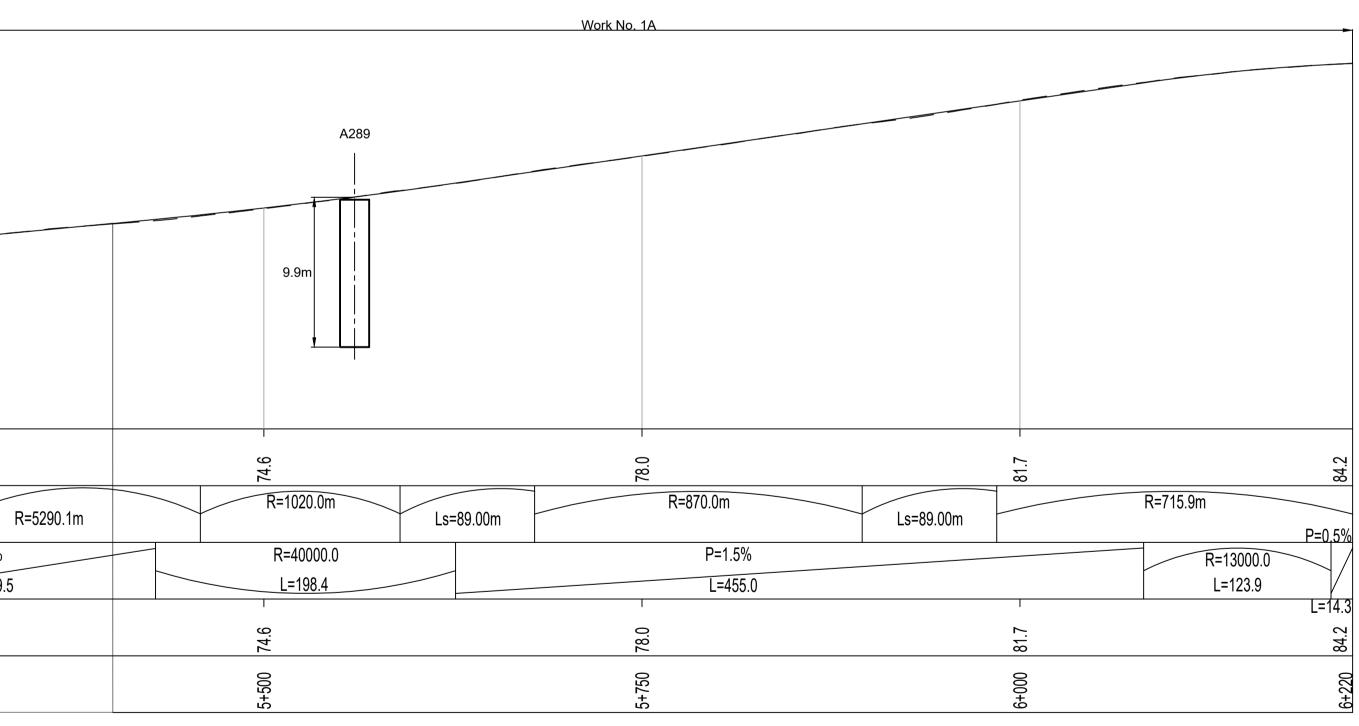

A2 MAINLINE PROFILE

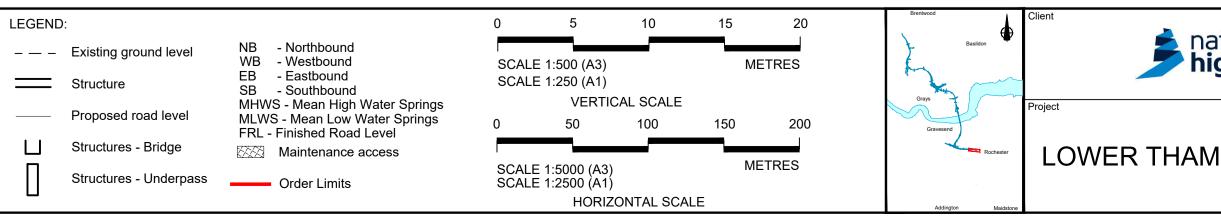

ational	Status DCO Application	Original Size	Revision P01					
national Nighways	Application Document Number TR010032/APP/2.9	- ·	SHOWN					
	A2 MAINLINE - PLAN AND PROFILES							
	REGULATION 5(2)(0) AND 6(2)							
MES CROSSING	SHEET 4							
	Drawing Number HE540039-CJV-BOP-SZA_RX000000DF	R-CH-102	254					

HE540039-CJV-BOP-SZA_RX000000_-DR-CH-10254.dwg

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