

ENVIRONMENTAL STATEMENT (VOLUME III)

Block Valve Stations Elevations

HyNet Carbon Dioxide Pipeline DCO

Planning Act 2008

The Infrastructure Planning (Applications: Prescribed Forms and Procedure) Regulations 2009 –
Regulations 5(2)(o)

Document Reference Number D.2.8

Applicant: Liverpool Bay CCS Limited

Inspectorate Reference: EN070007

English Version

REVISION: A


DATE: September 2022

DOCUMENT OWNER: WSP UK Limited


PUBLIC

QUALITY CONTROL


Issue/Revision	First Issue	Revision 1	Revision 2	Revision 3
Document Reference	D.2.8			
Revision	A			
Author Name and Sign	PT			
Approver Name and Sign	NC			
Document Owner	WSP			

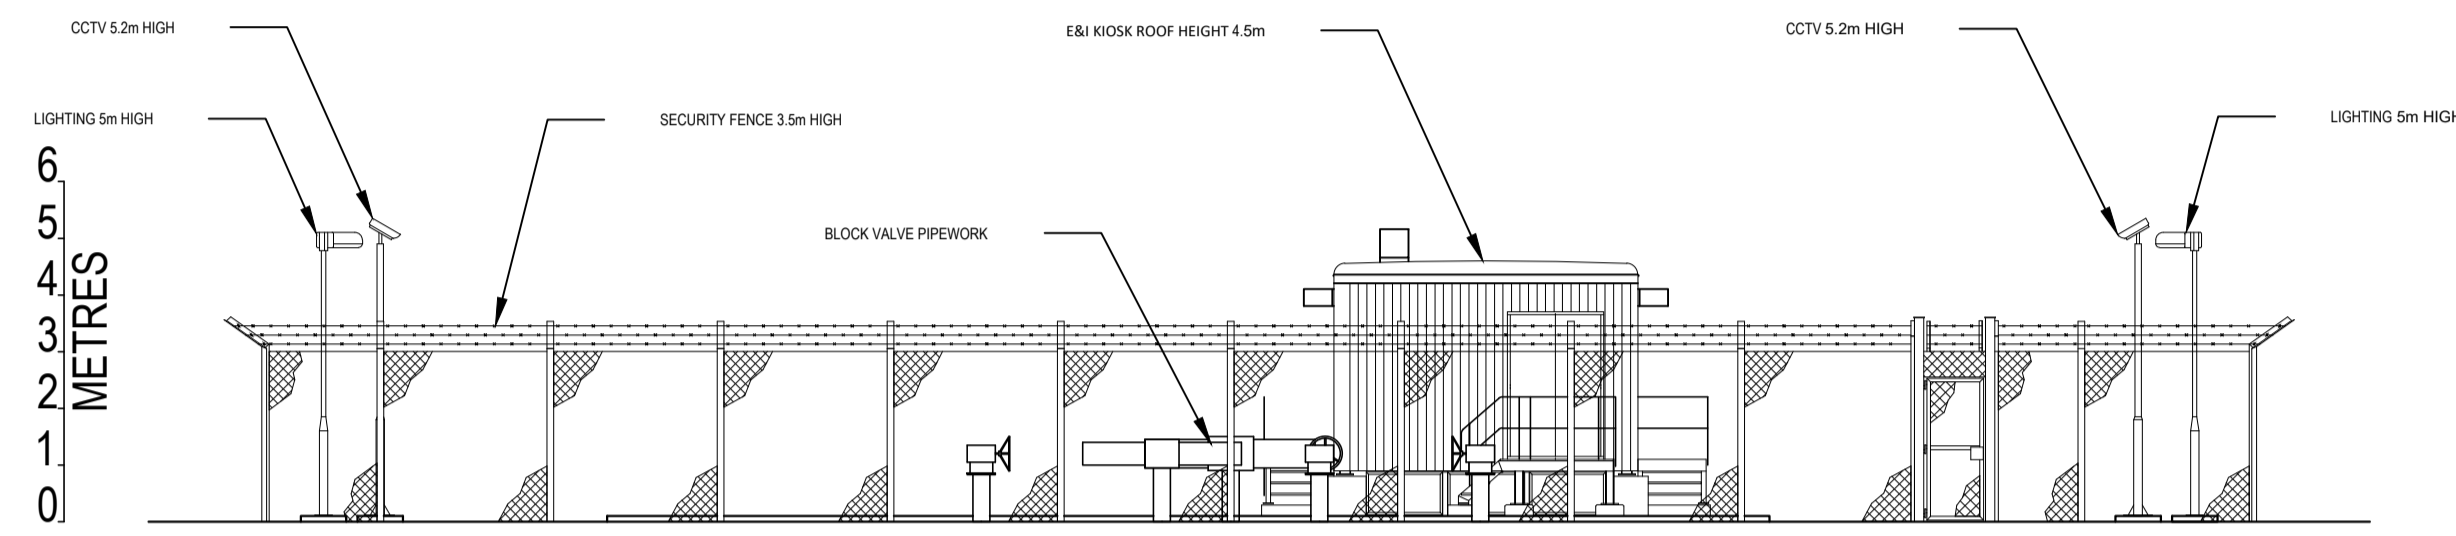


NORTH ELEVATION A-A

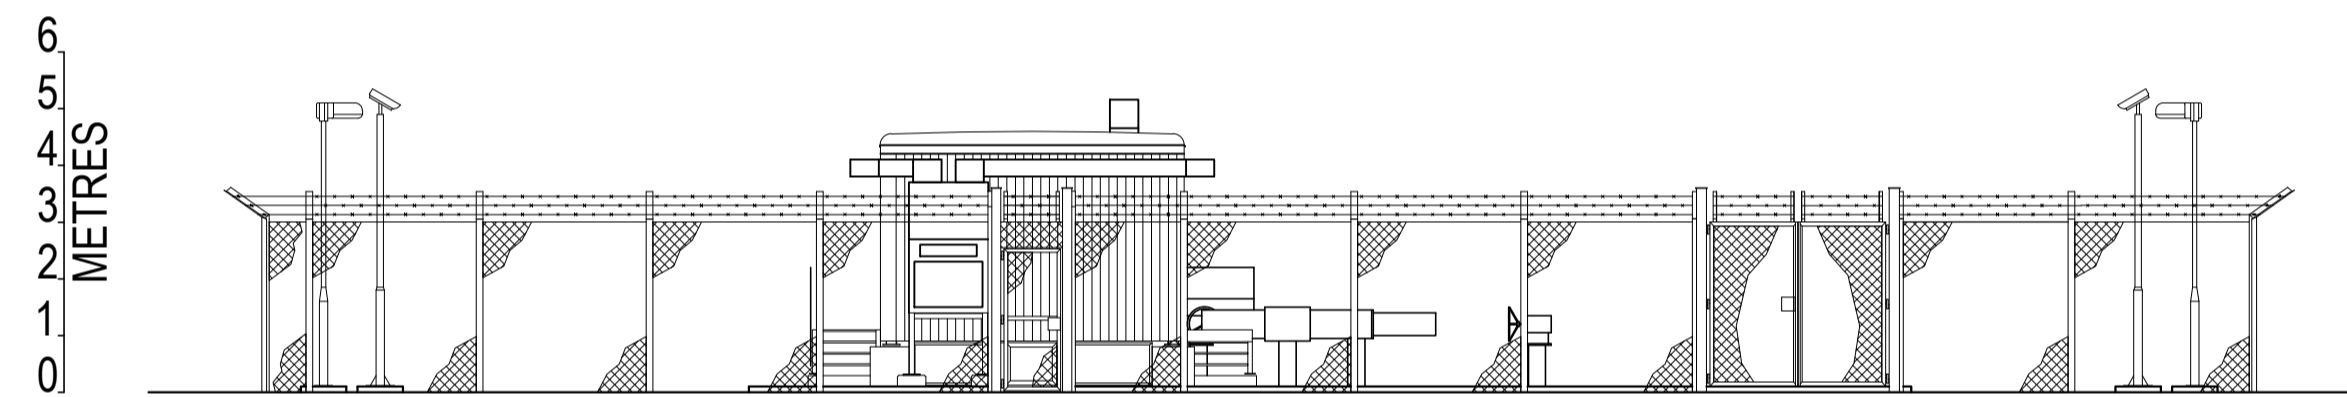


SOUTH ELEVATION B-B

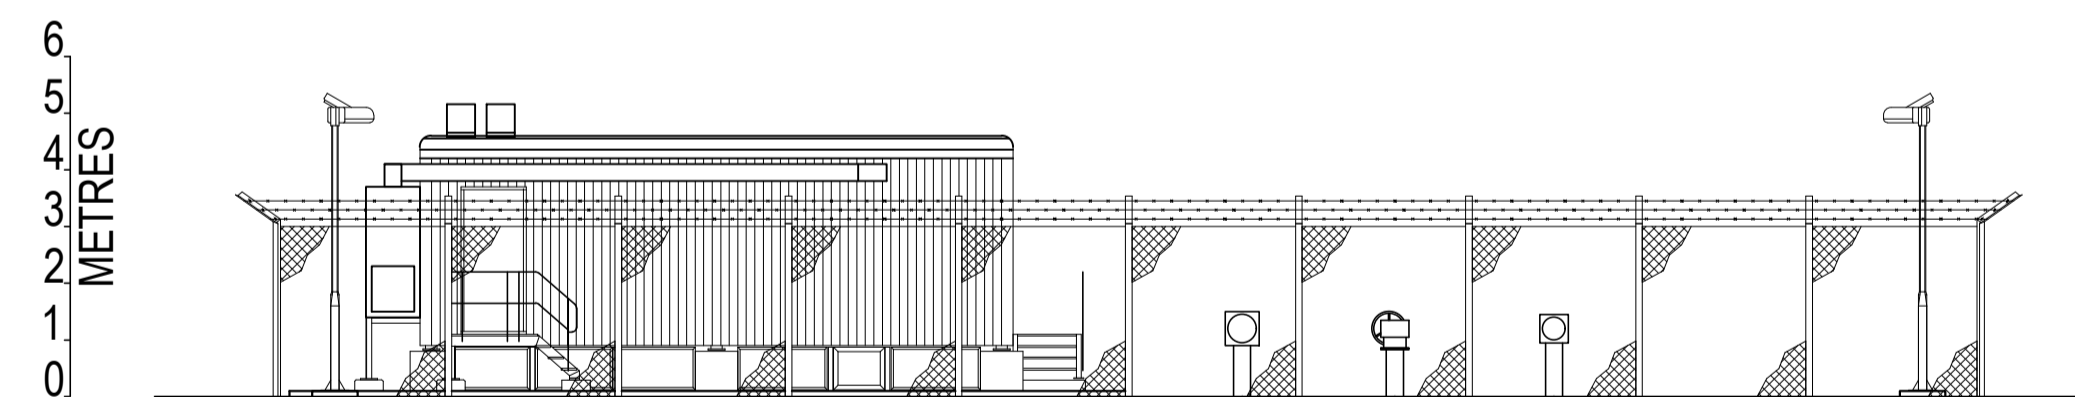

EAST ELEVATION C-C

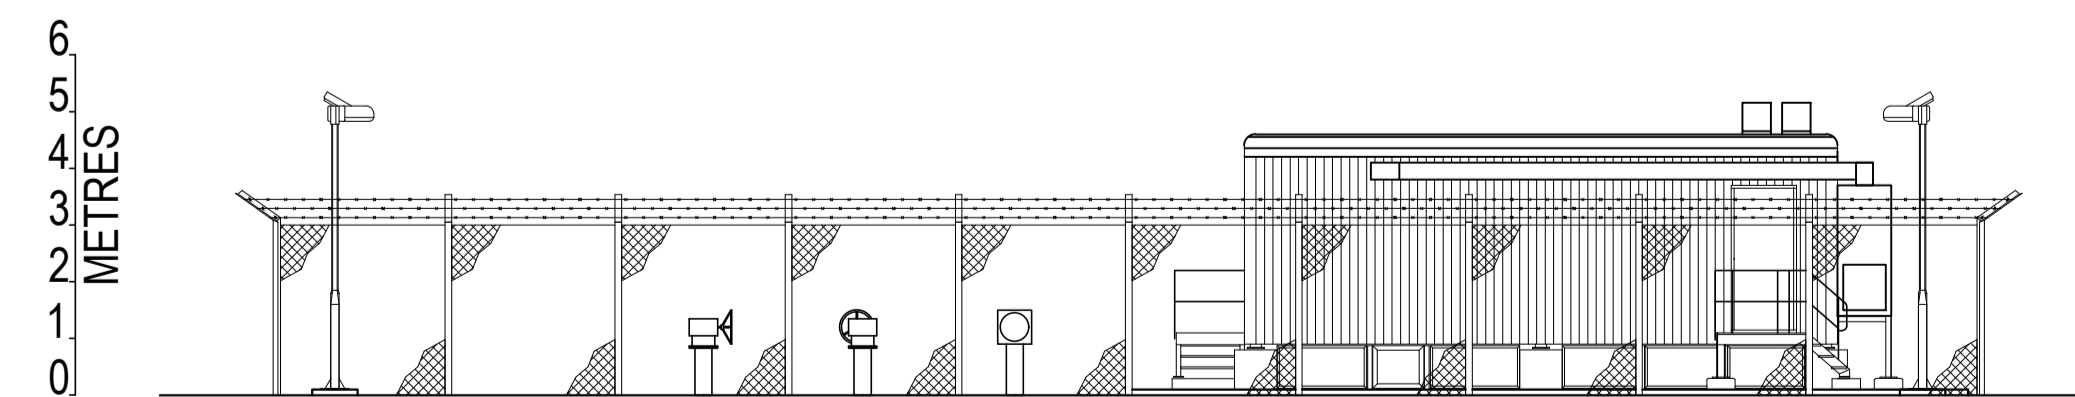


WEST ELEVATION D-D

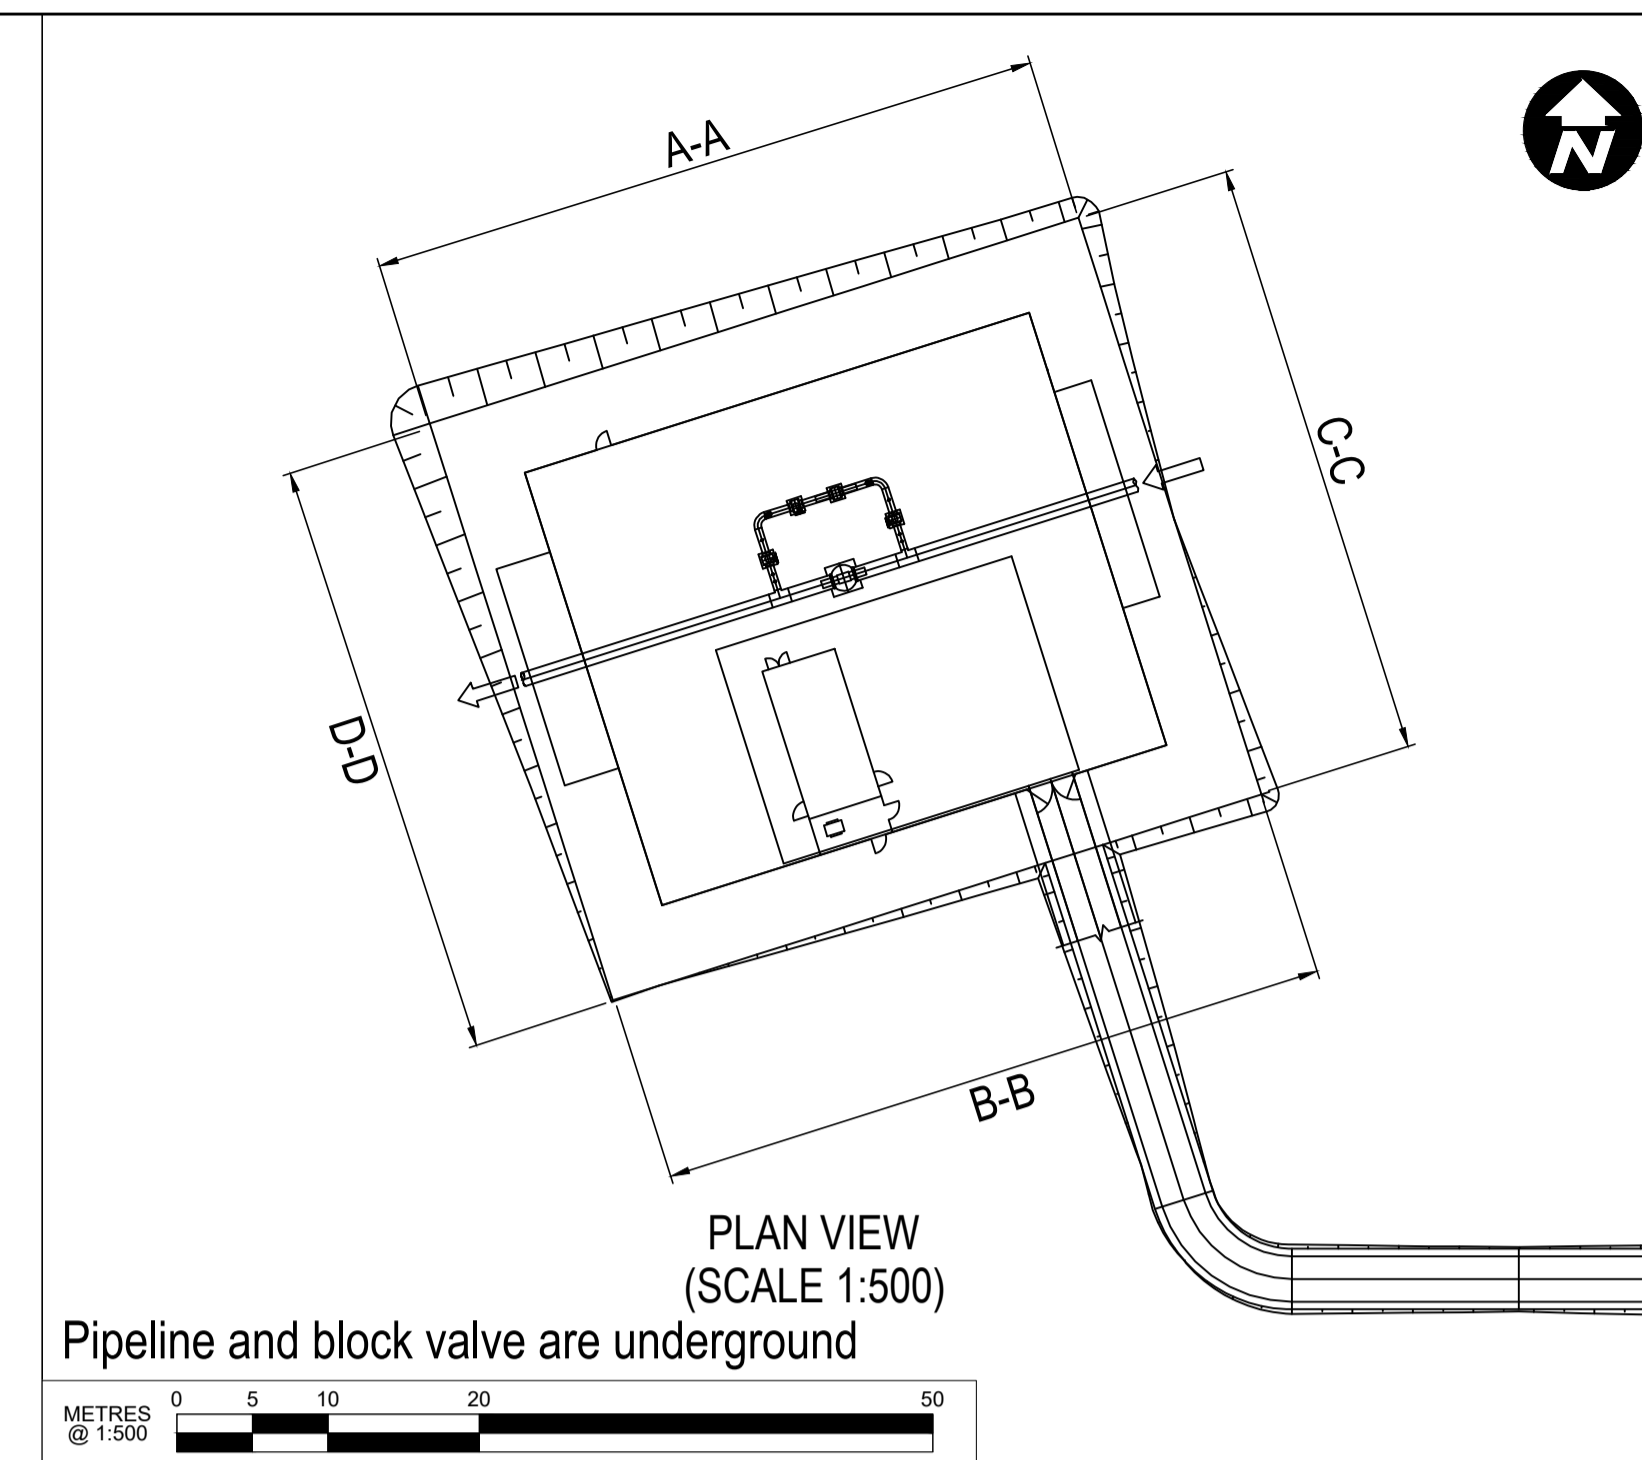


PLAN VIEW
(SCALE 1:500)

Pipeline and block valve are underground

METRES @ 1:500

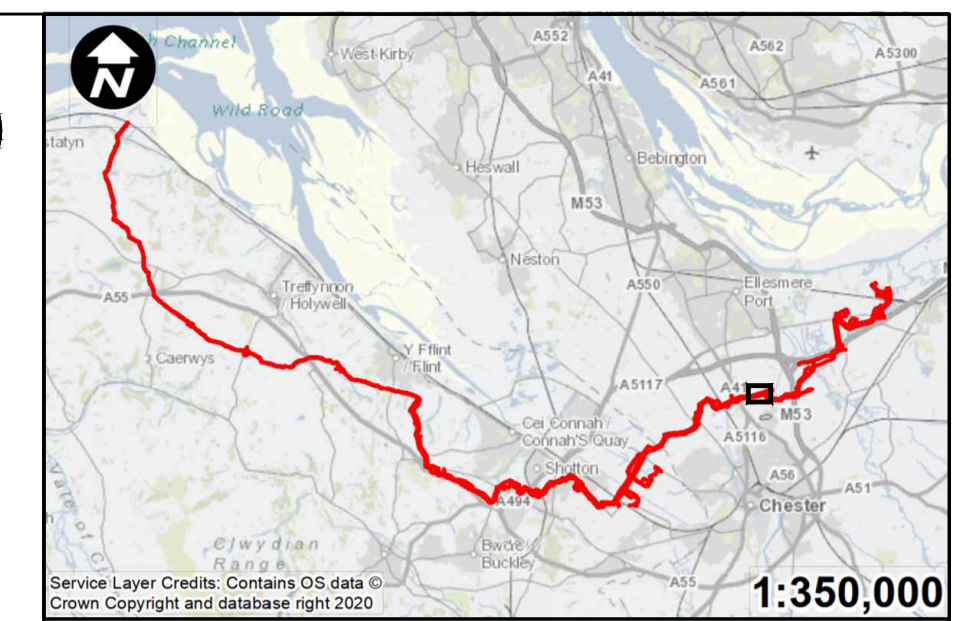

SCALE: 1:2500

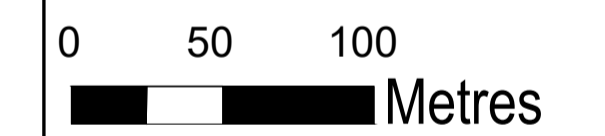

Contains OS data © Crown Copyright and database right 2020

HyNet North West

PROJECT TITLE
HyNet Carbon Dioxide Pipeline DCO


DRAWING TITLE
ROCK BANK BVS
ELEVATION PLAN
REGULATION 5(2)(c)
APPLICATION DOCUMENT REFERENCE D.2.8
SHEET 1 OF 6

DRAWING STATUS
FOR DCO SUBMISSION


DRAWN TO	CHECKED JH	APPROVED VB	AUTHORISED AV
----------	------------	-------------	---------------

SCALE @ A1 SIZE 1:150	DATE 27/09/2022	REVISION A
--------------------------	--------------------	---------------


DRAWING NUMBER
EN070007-D.2.8-EL-Sheet 1

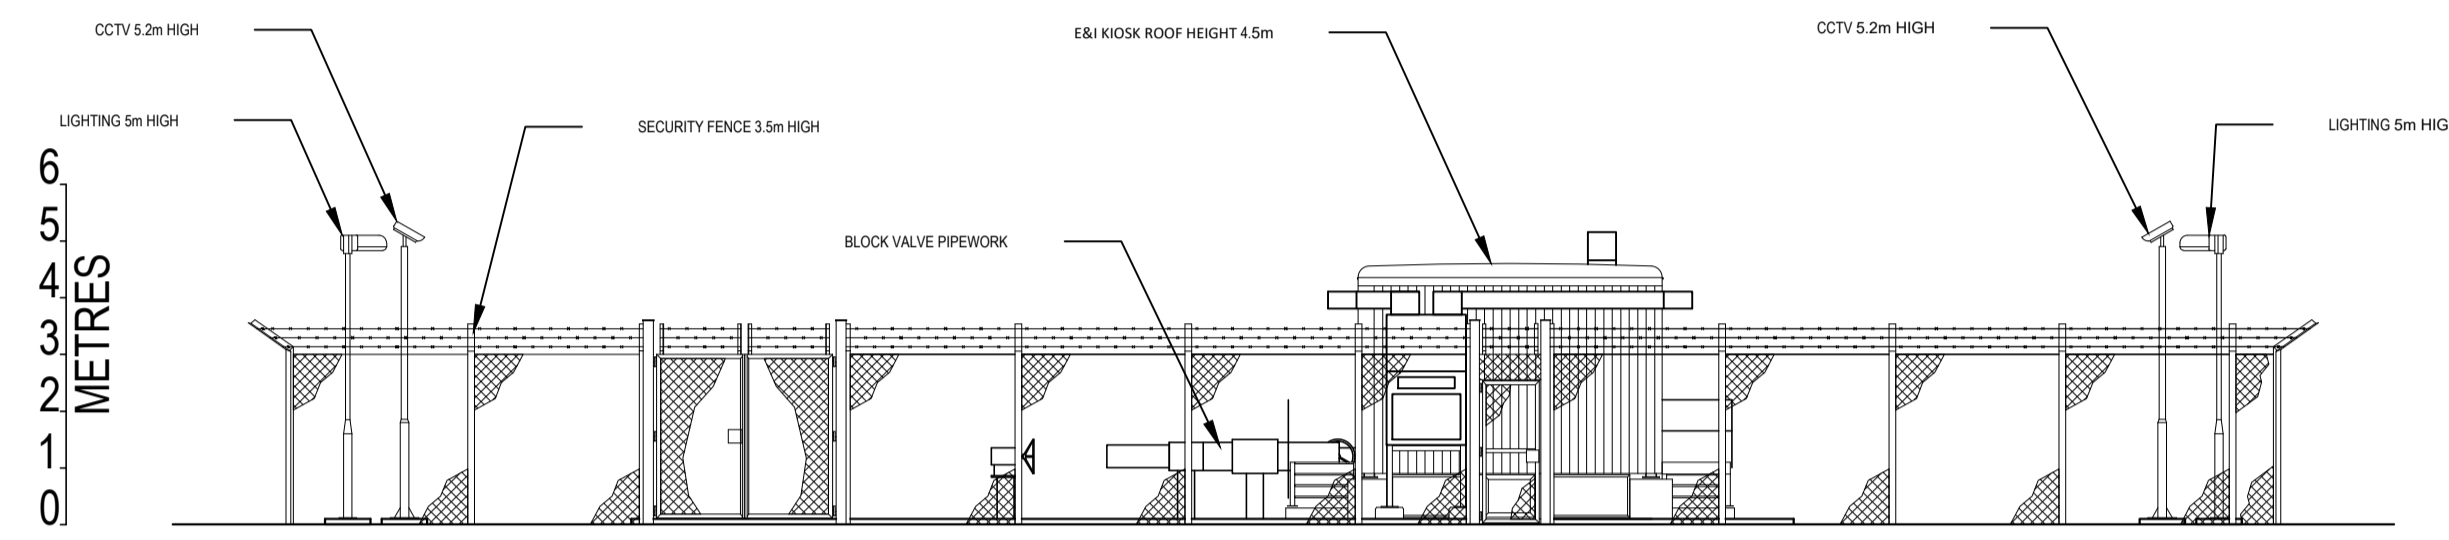


NORTH ELEVATION

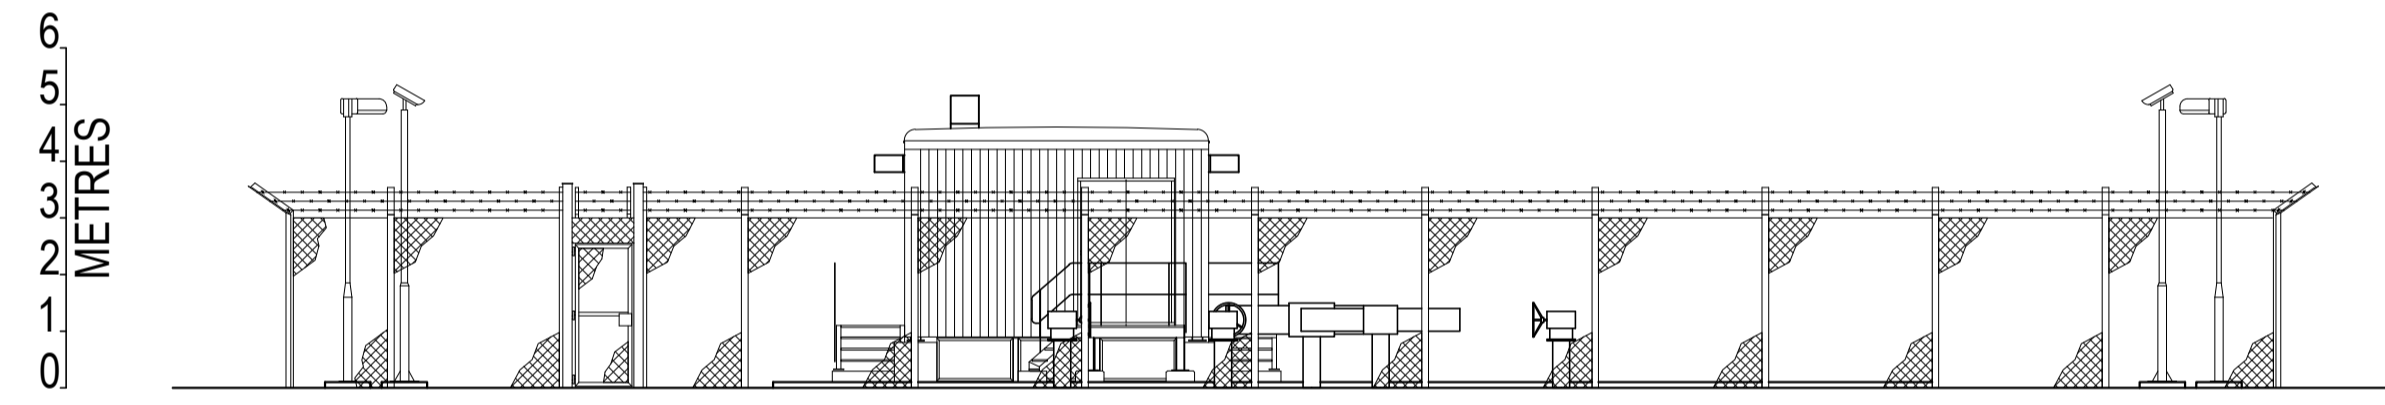


SOUTH ELEVATION

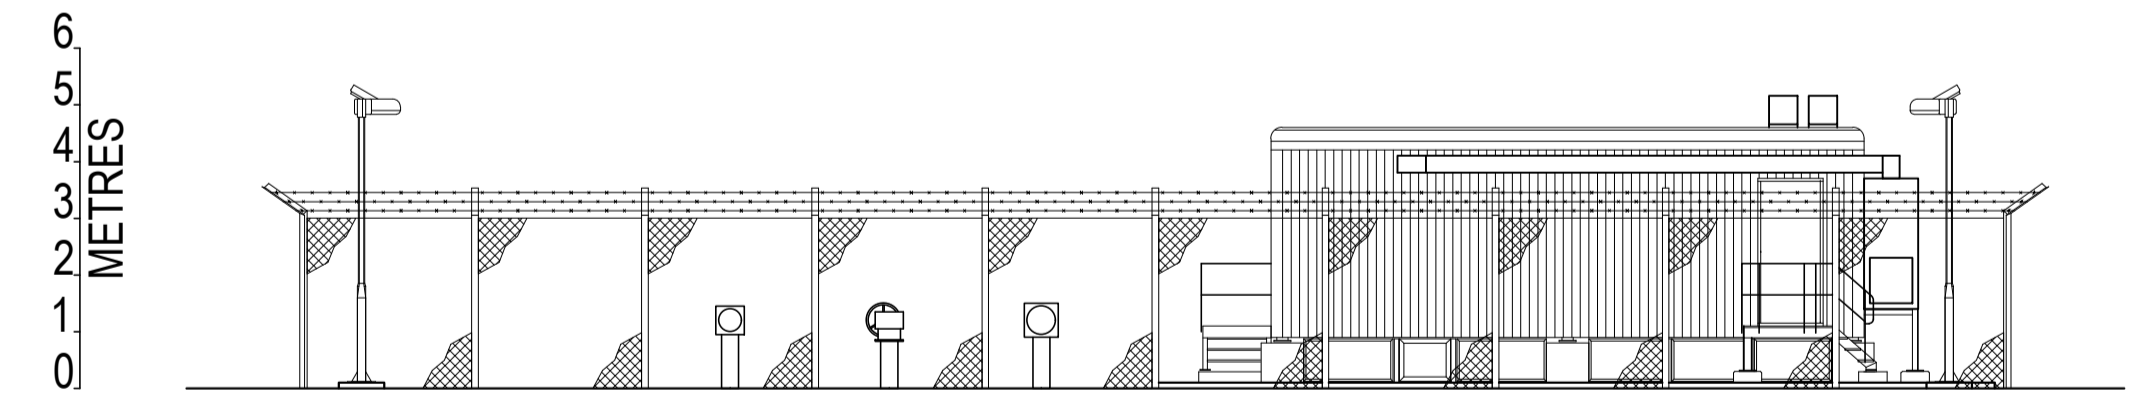

EAST ELEVATION

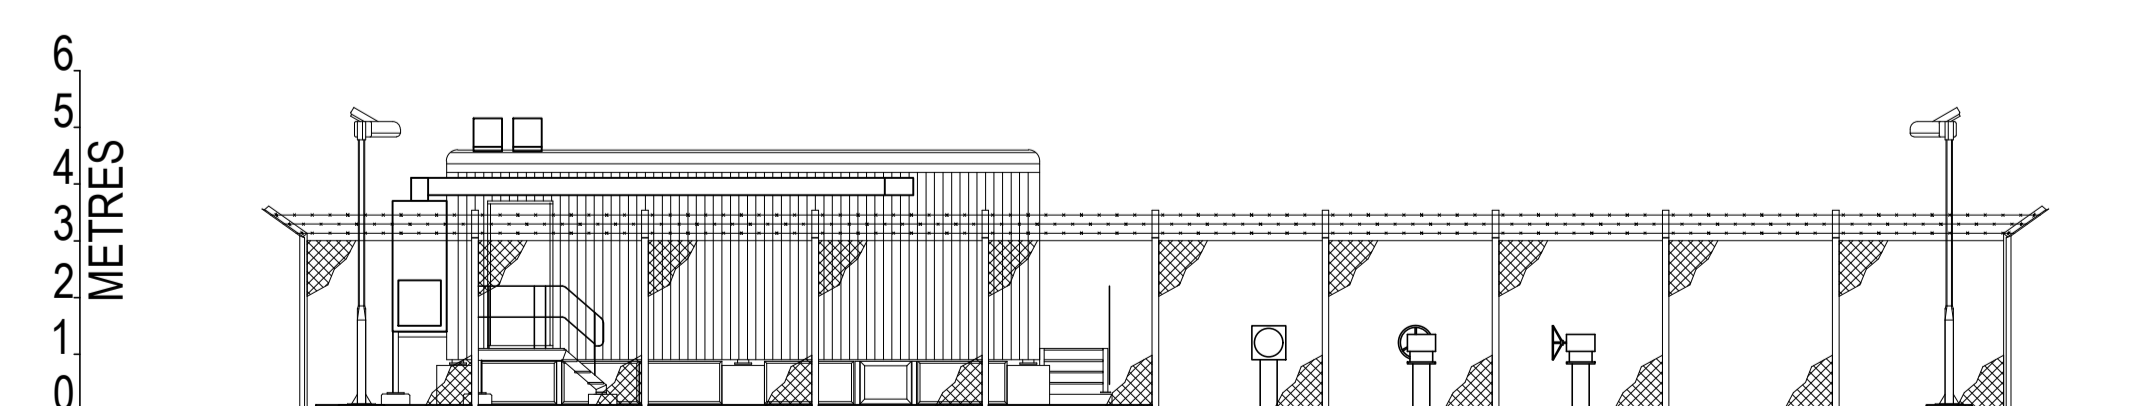


WEST ELEVATION

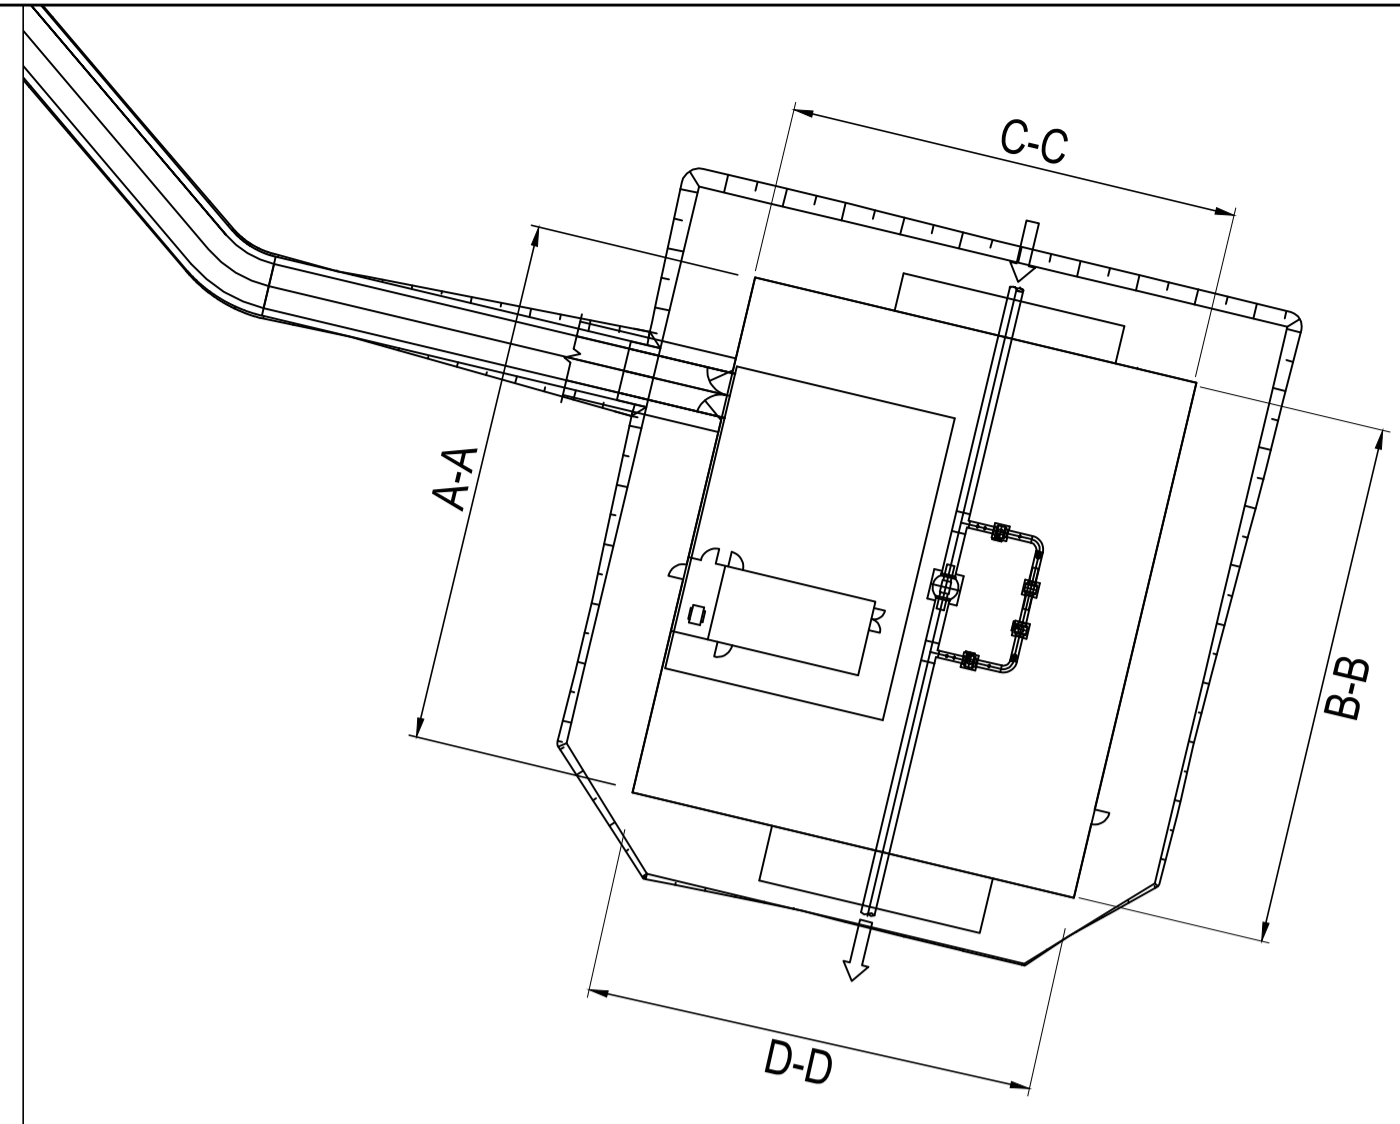

PLAN VIEW
(SCALE 1:500)

Pipeline and block valve are underground

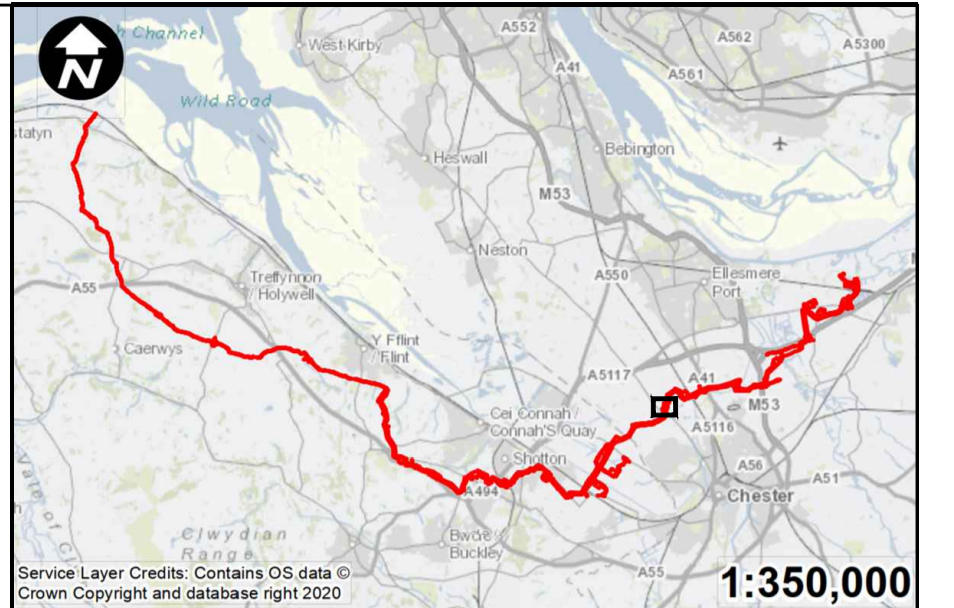

SCALE: 1:2500
0 50 100
Metres

Contains OS data © Crown Copyright and database right 2020



PROJECT TITLE
HyNet Carbon Dioxide Pipeline DCO


DRAWING TITLE
MOLLINGTON BVS
ELEVATION PLAN
REGULATION 5(2)(c)
APPLICATION DOCUMENT REFERENCE D.2.8
SHEET 2 OF 6

DRAWING STATUS
FOR DCO SUBMISSION


DRAWN TO	CHECKED JH	APPROVED VB	AUTHORISED AV
-------------	---------------	----------------	------------------

SCALE @ A1 SIZE 1:150	DATE 27/09/2022	REVISION A
--------------------------	--------------------	---------------


DRAWING NUMBER
EN070007-D.2.8-EL-Sheet 2

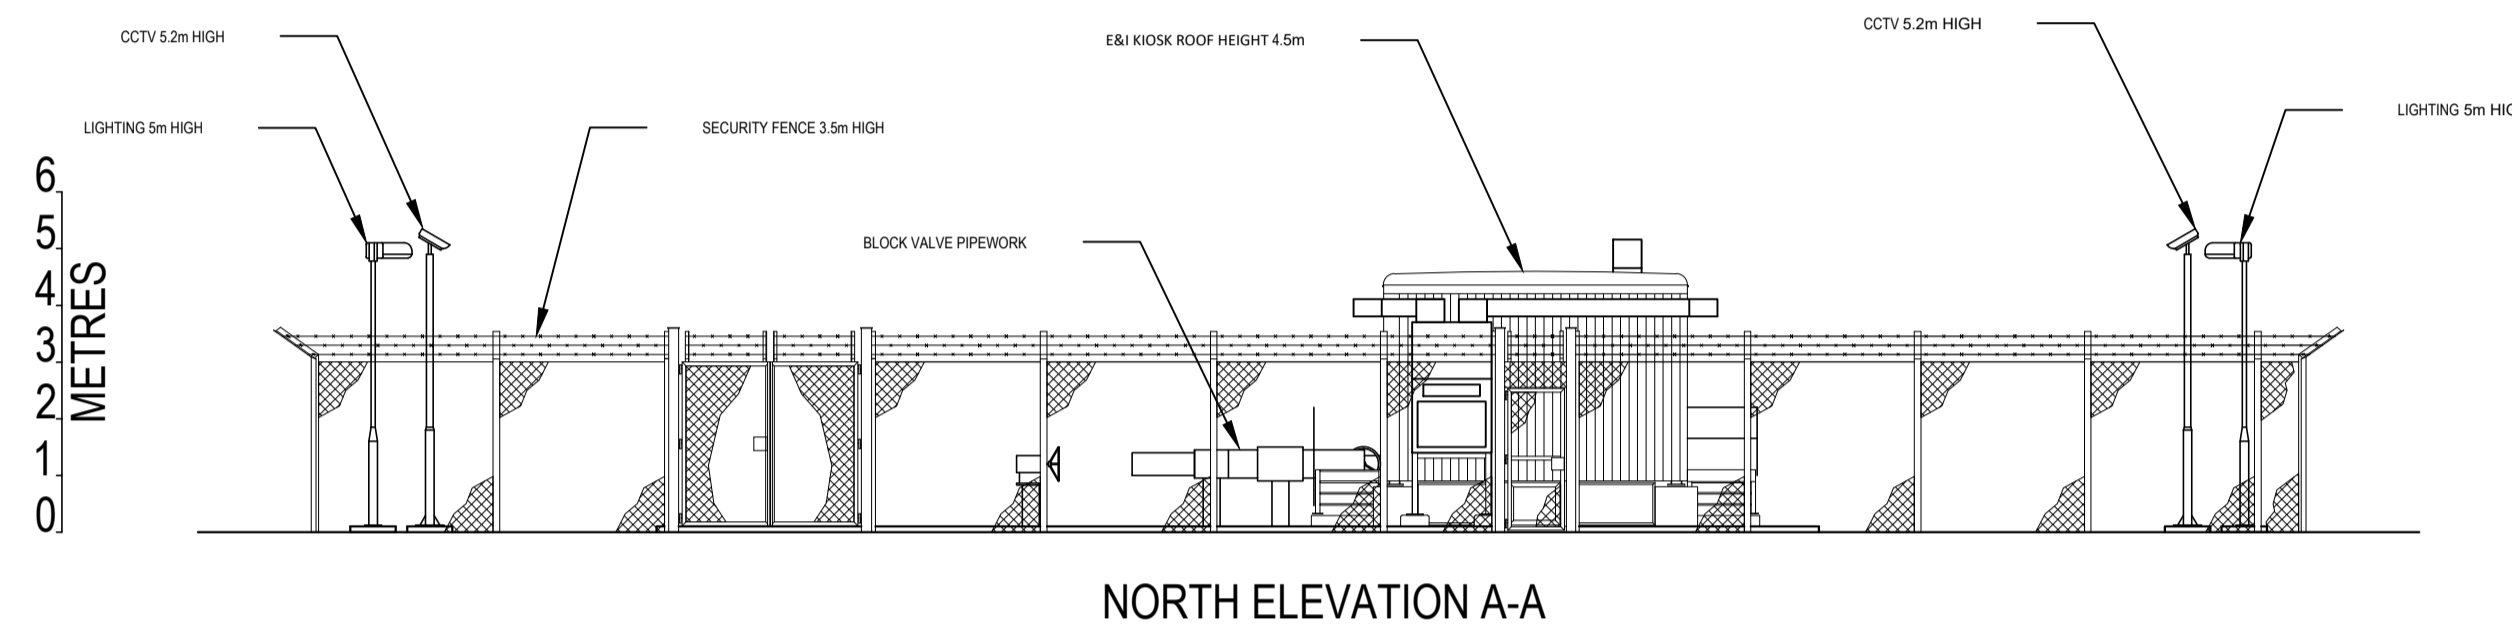


NORTH ELEVATION A-A

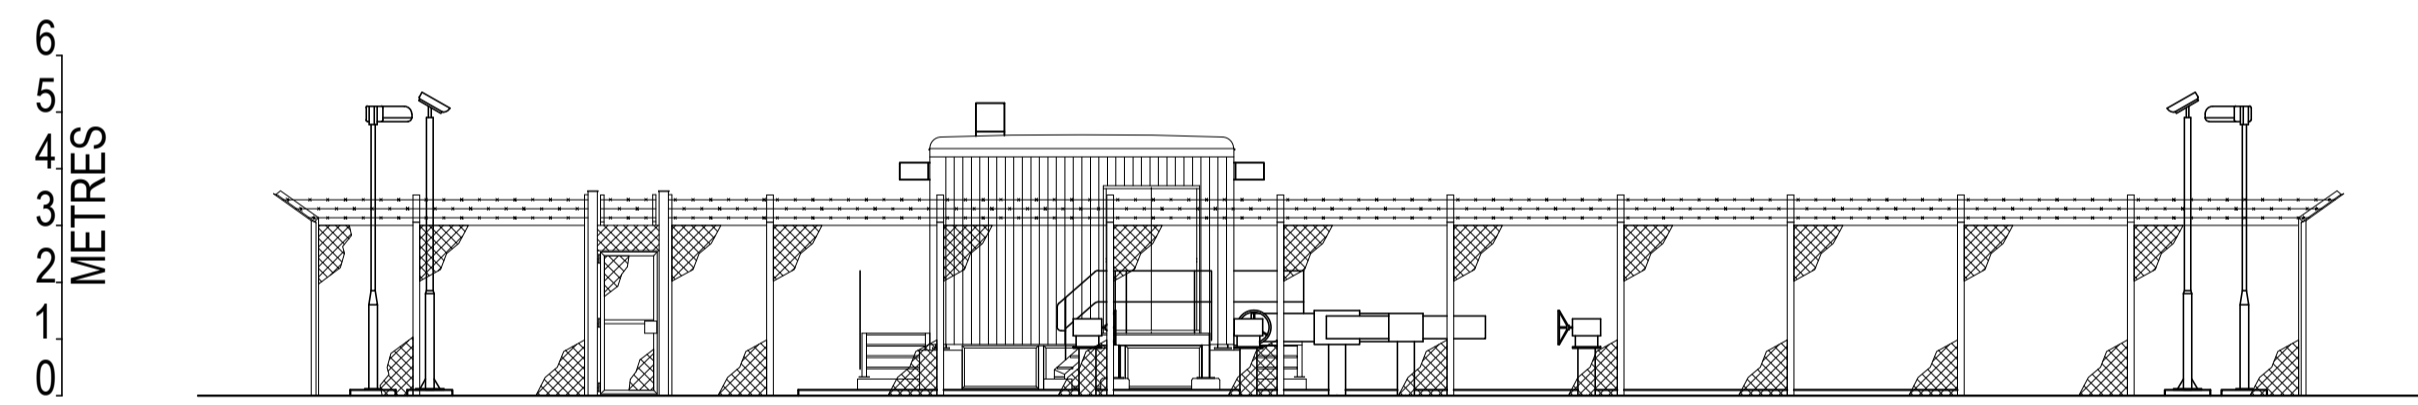


SOUTH ELEVATION B-B

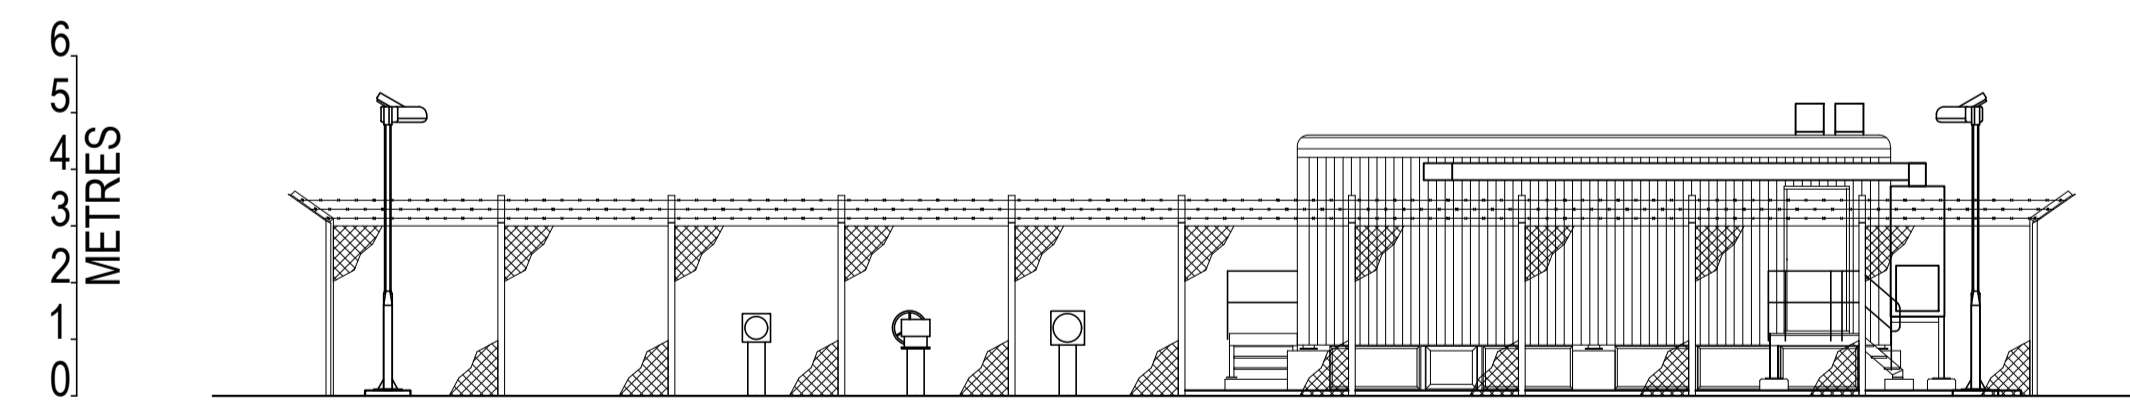

EAST ELEVATION C-C

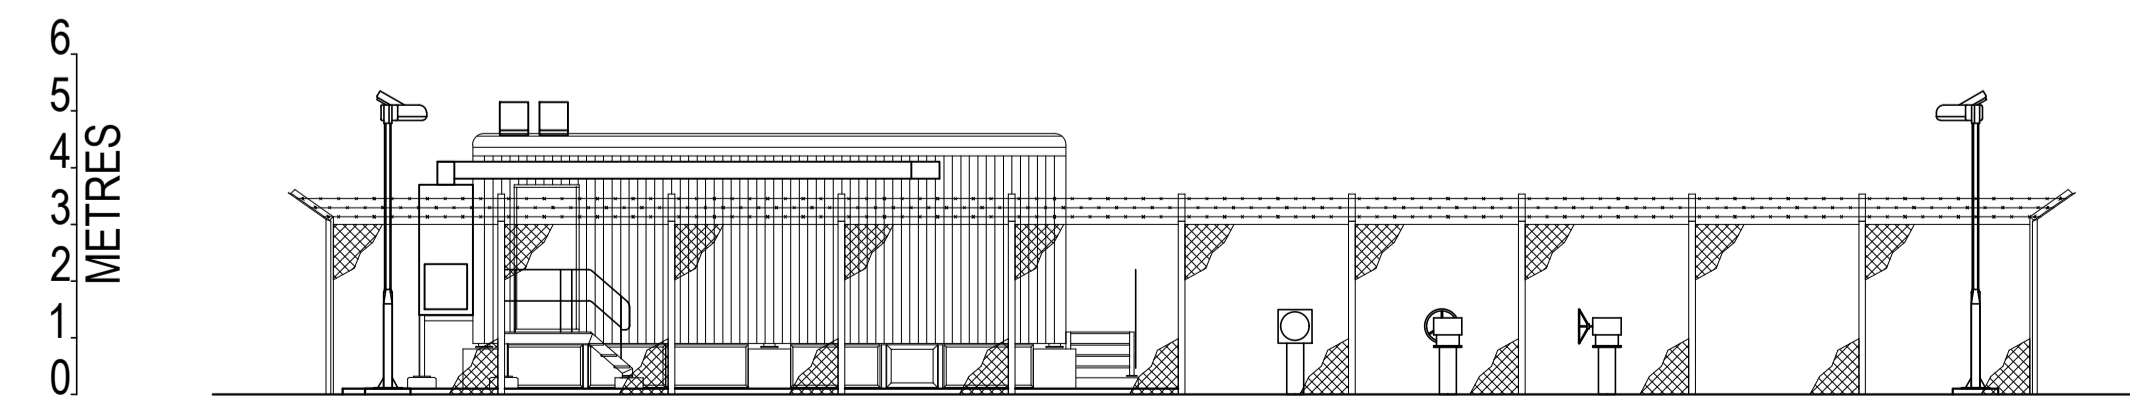

WEST ELEVATION D-D

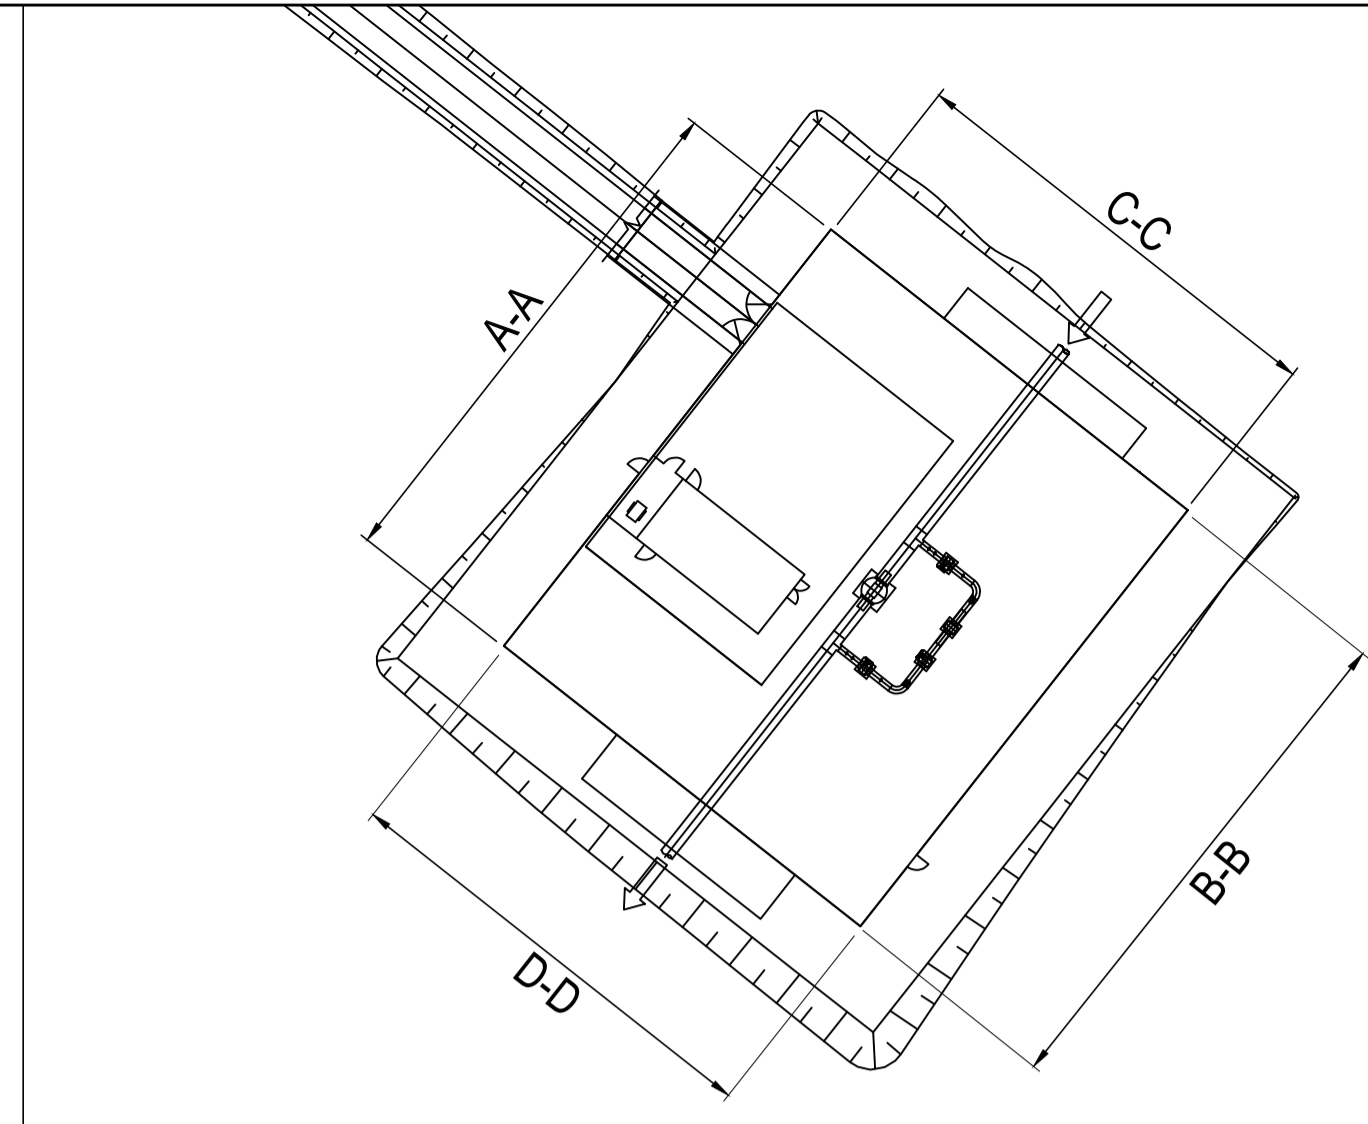

PLAN VIEW
(SCALE 1:500)
Pipeline and block valve are underground



SCALE: 1:2500
0 50 100
Metres

Contains OS data © Crown Copyright and database right 2020




PROJECT TITLE
HyNet Carbon Dioxide Pipeline DCO

DRAWING TITLE
ASTON HILL BVS
ELEVATION PLAN
REGULATION 5(2)(c)
APPLICATION DOCUMENT REFERENCE D.2.8
SHEET 3 OF 6


DRAWING STATUS
FOR DCO SUBMISSION

DRAWN TO	CHECKED JH	APPROVED VB	AUTHORISED AV
SCALE @ A1 SIZE 1:150	DATE 27/09/2022	REVISION A	


DRAWING NUMBER
EN070007-D.2.8-EL-Sheet 3

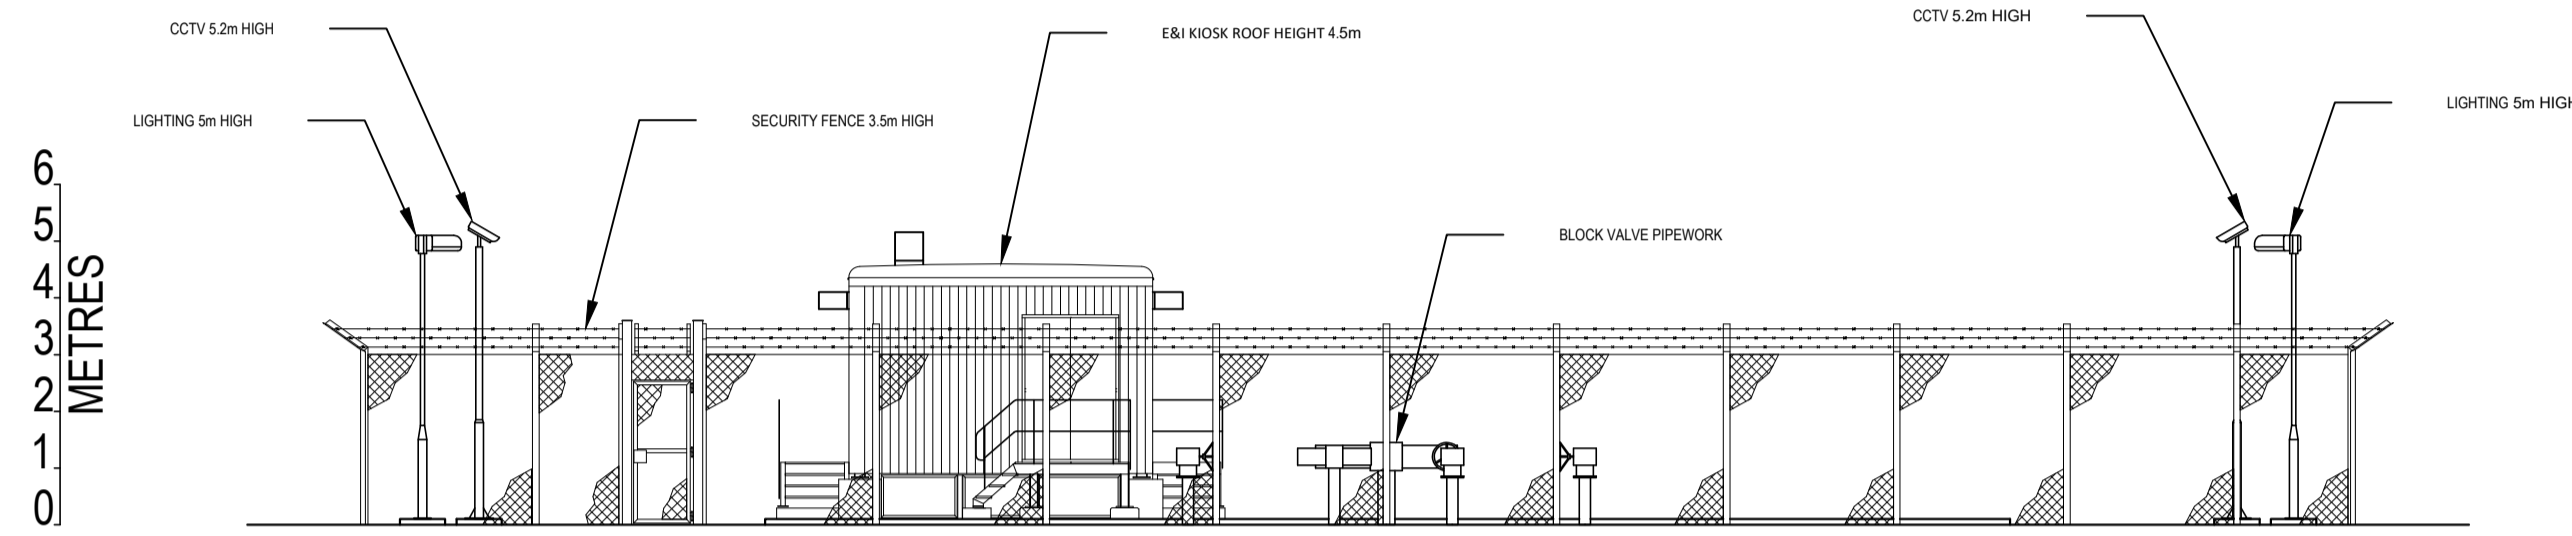


NORTH ELEVATION A-A

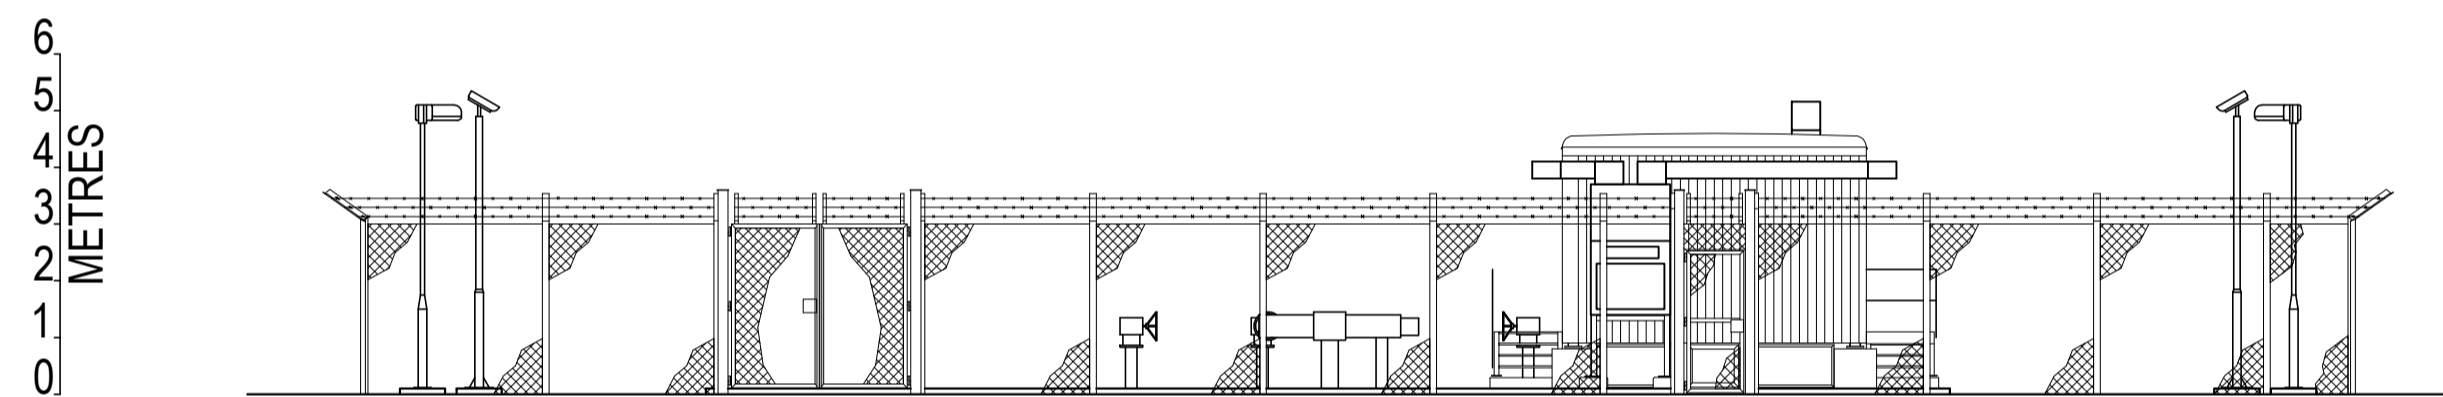


SOUTH ELEVATION B-B

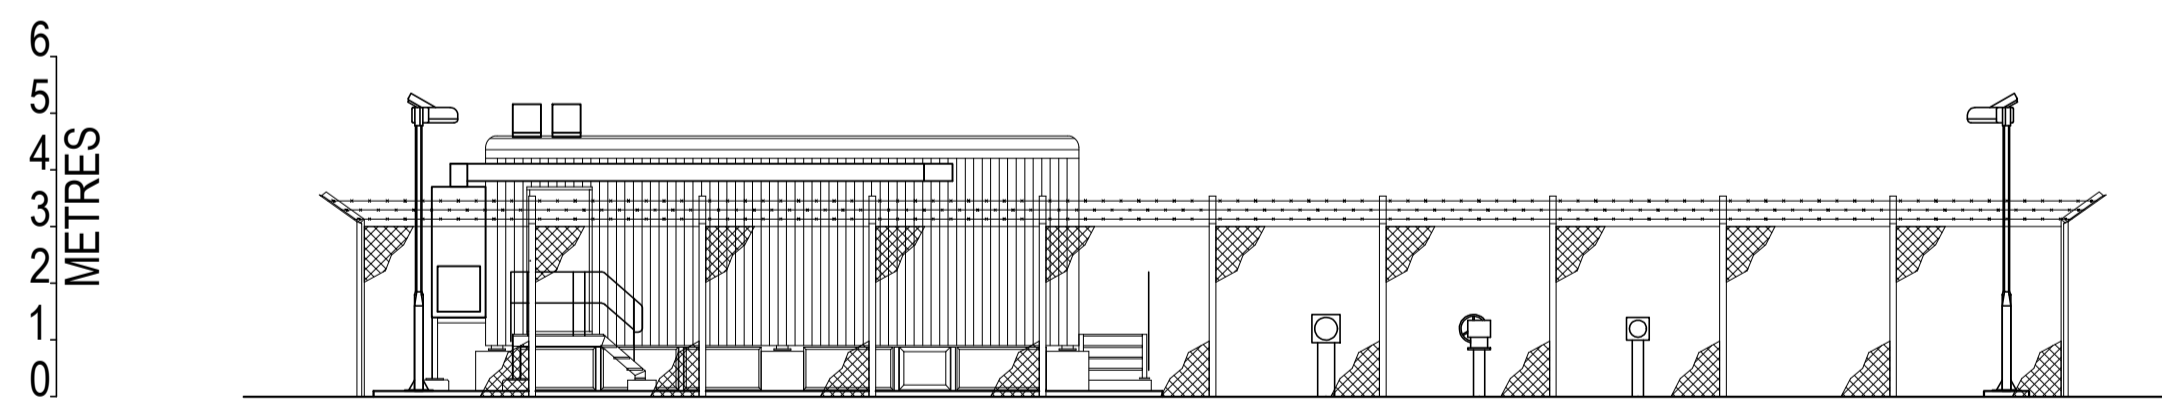

EAST ELEVATION C-C

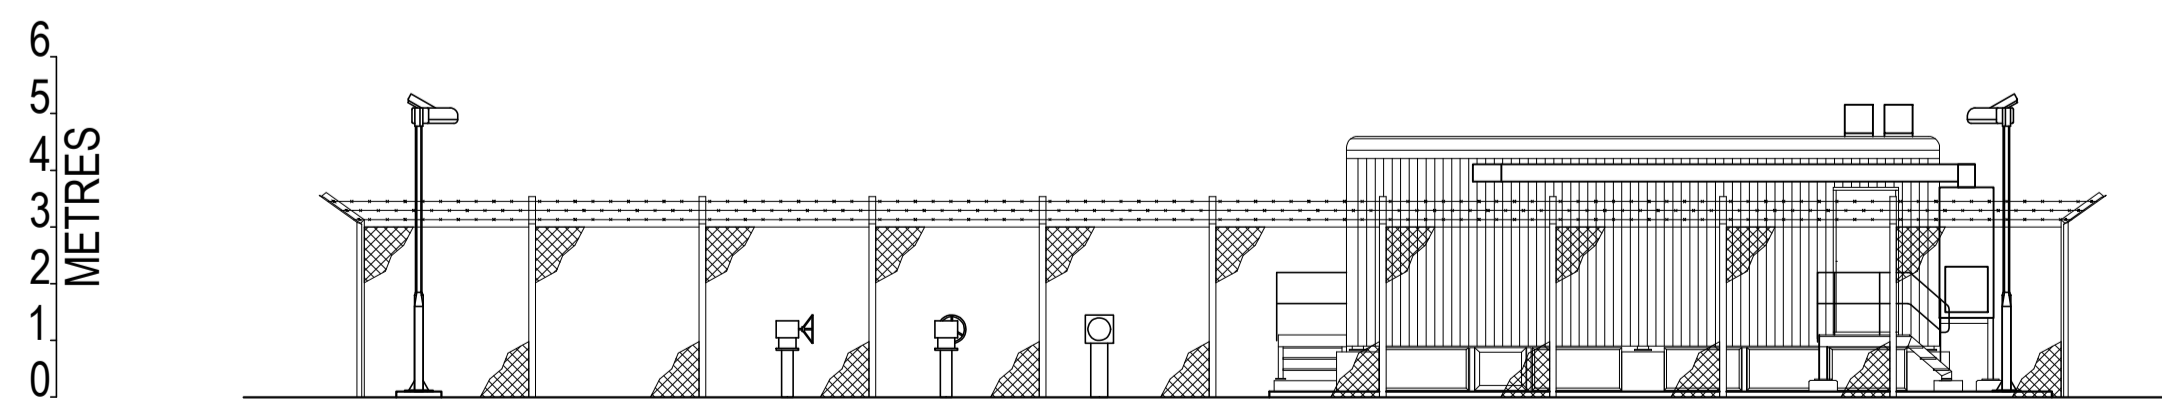

WEST ELEVATION D-D

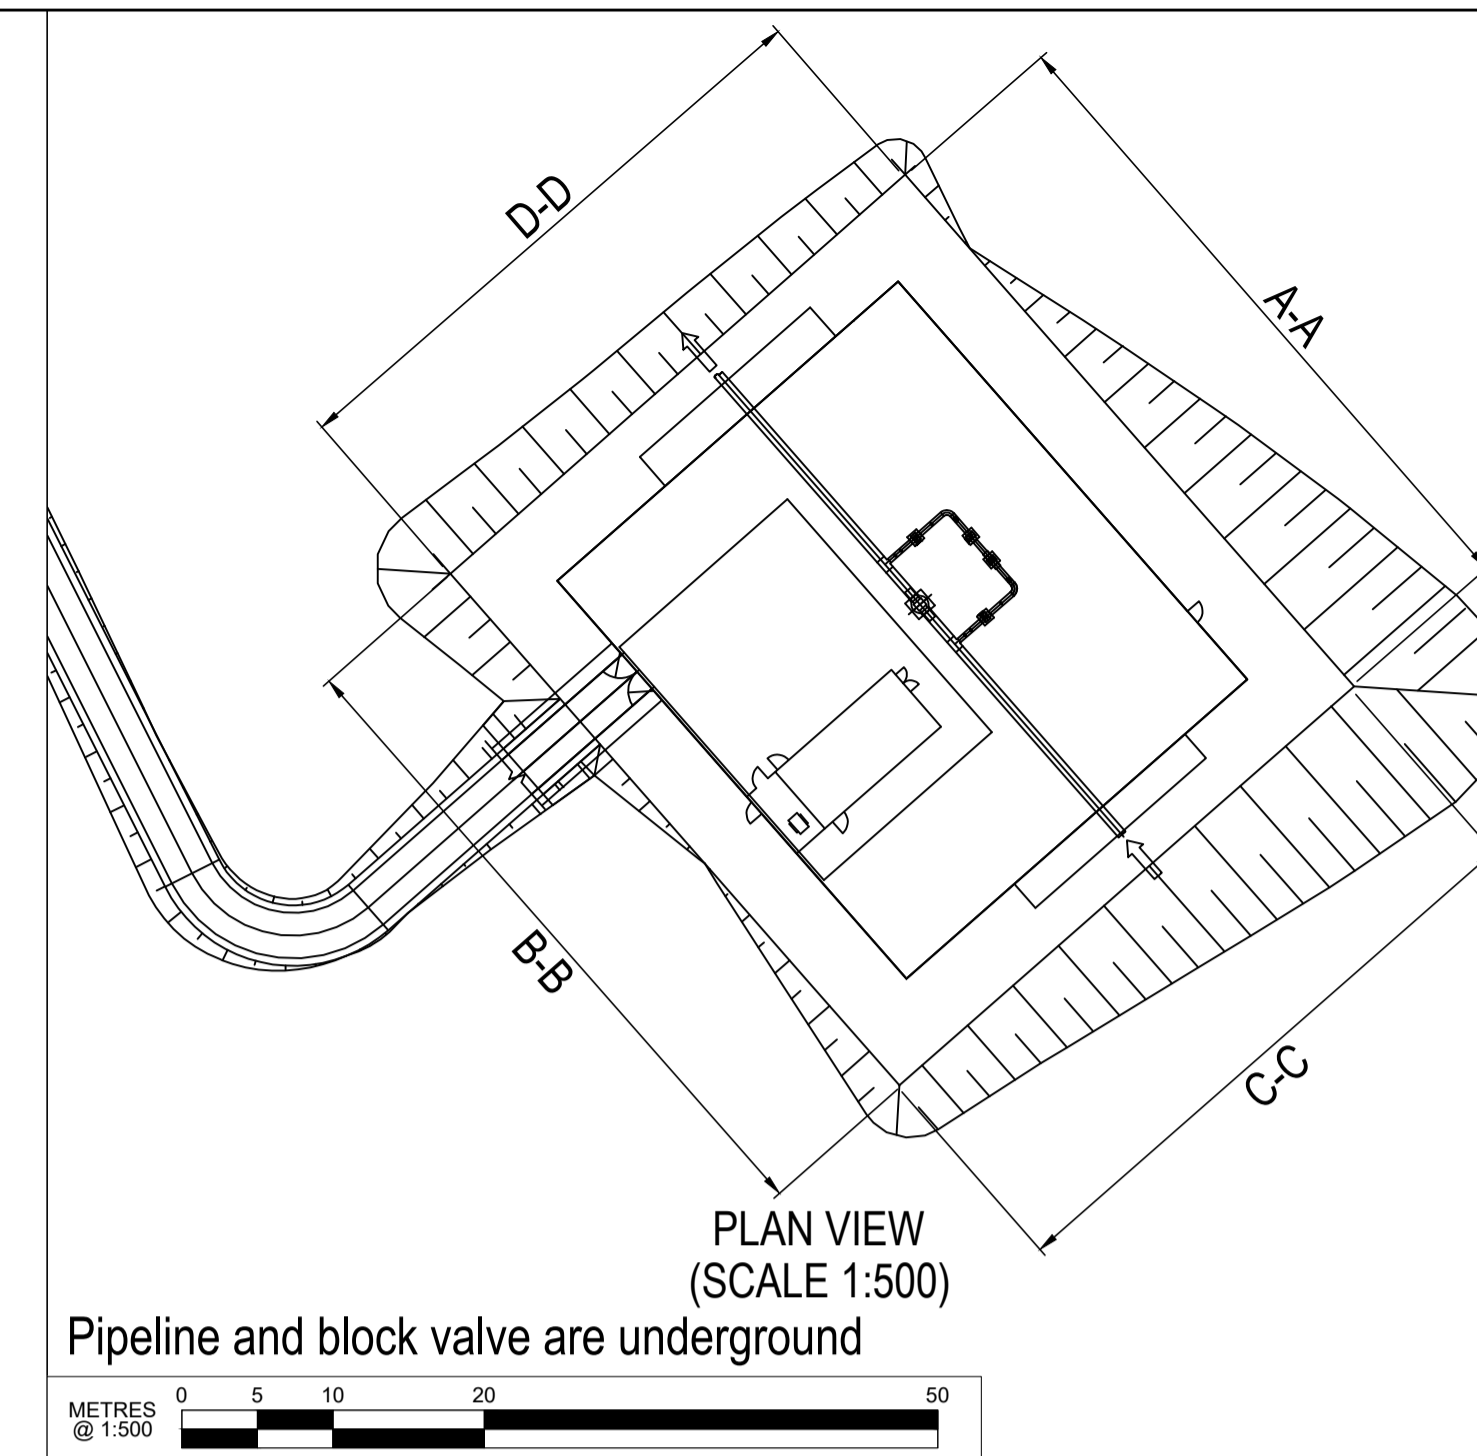

SCALE: 1:2500
0 50 100
Metres

Contains OS data © Crown Copyright and database right 2020

HyNet North West

PROJECT TITLE
HyNet Carbon Dioxide Pipeline DCO


DRAWING TITLE
CORNIST LANE BVS
ELEVATION PLAN
REGULATION 5(2)(o)
APPLICATION DOCUMENT REFERENCE D.2.8
SHEET 4 OF 6

DRAWING STATUS
FOR DCO SUBMISSION


DRAWN TO	CHECKED JH	APPROVED VB	AUTHORISED AV
----------	------------	-------------	---------------

SCALE @ A1 SIZE 1:150	DATE 27/09/2022	REVISION A
--------------------------	--------------------	---------------


DRAWING NUMBER
EN070007-D.2.8-EL-Sheet 4

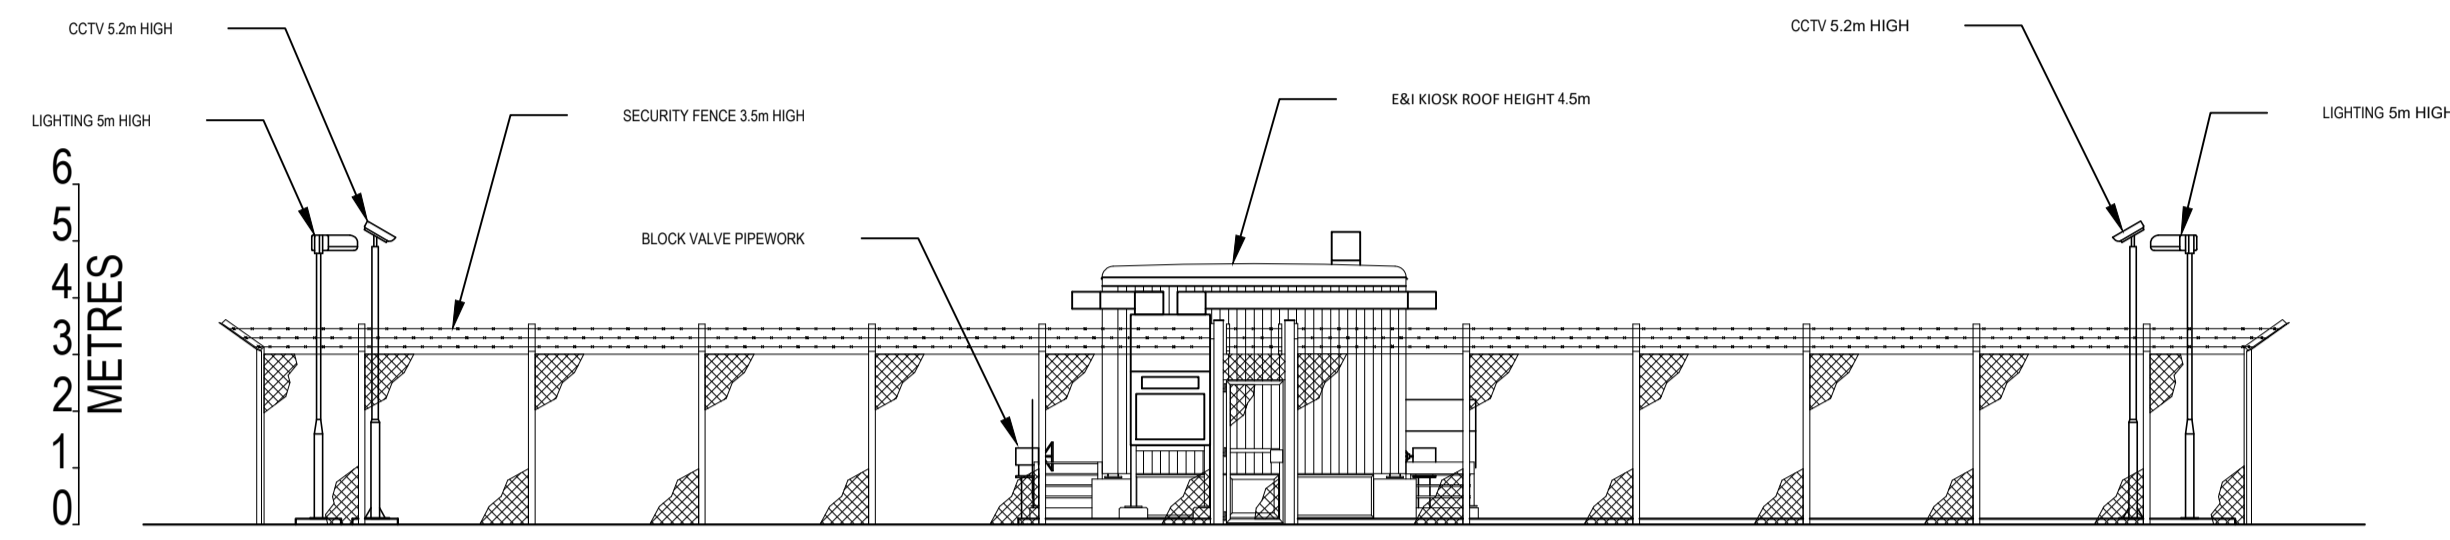


NORTH ELEVATION A-A

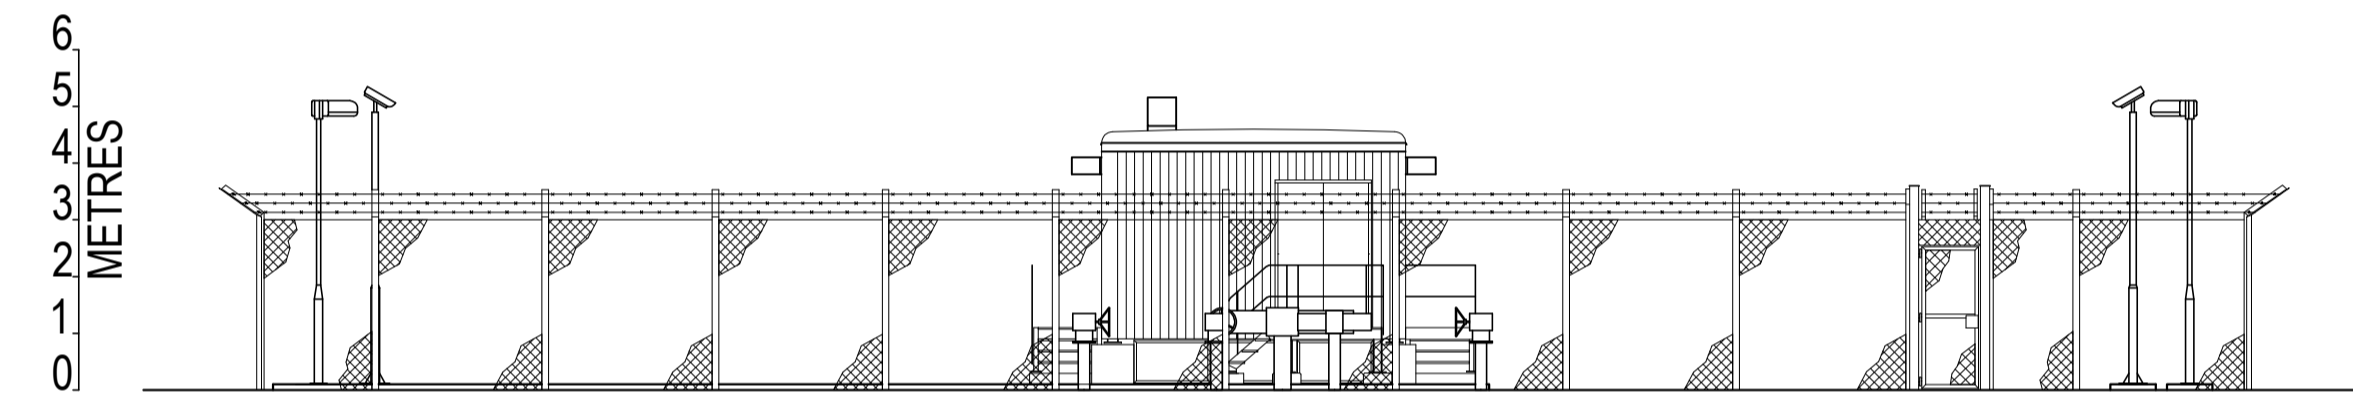


SOUTH ELEVATION B-B

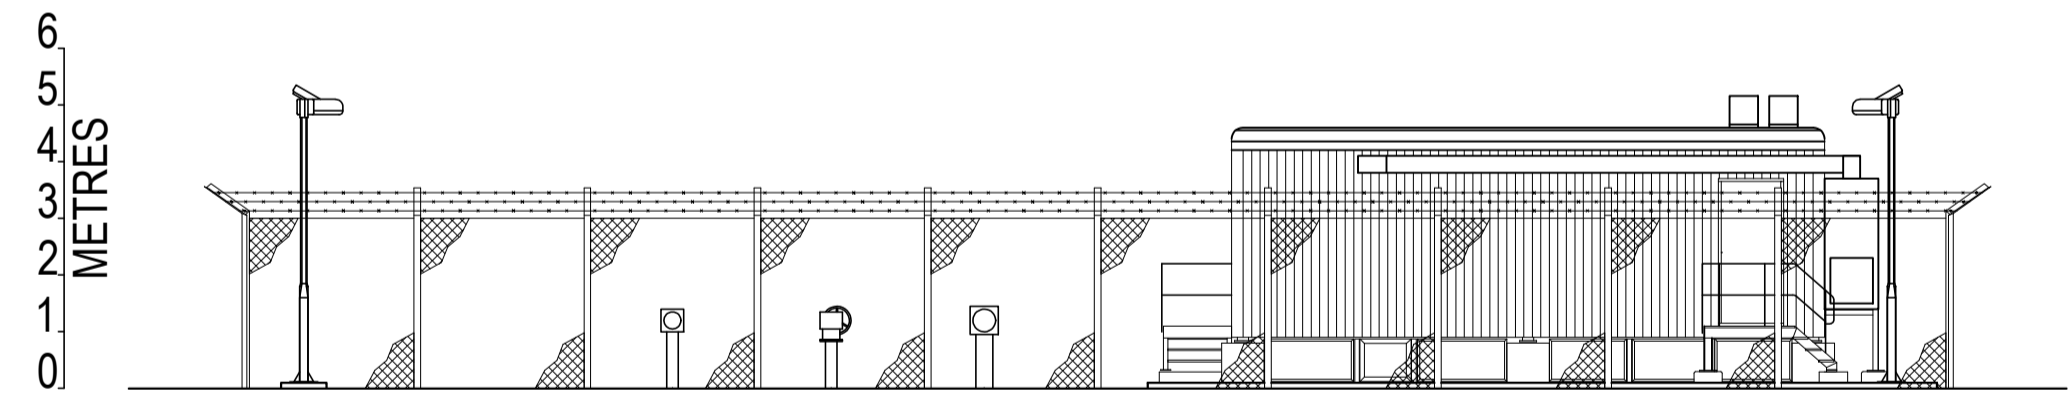


EAST ELEVATION C-C

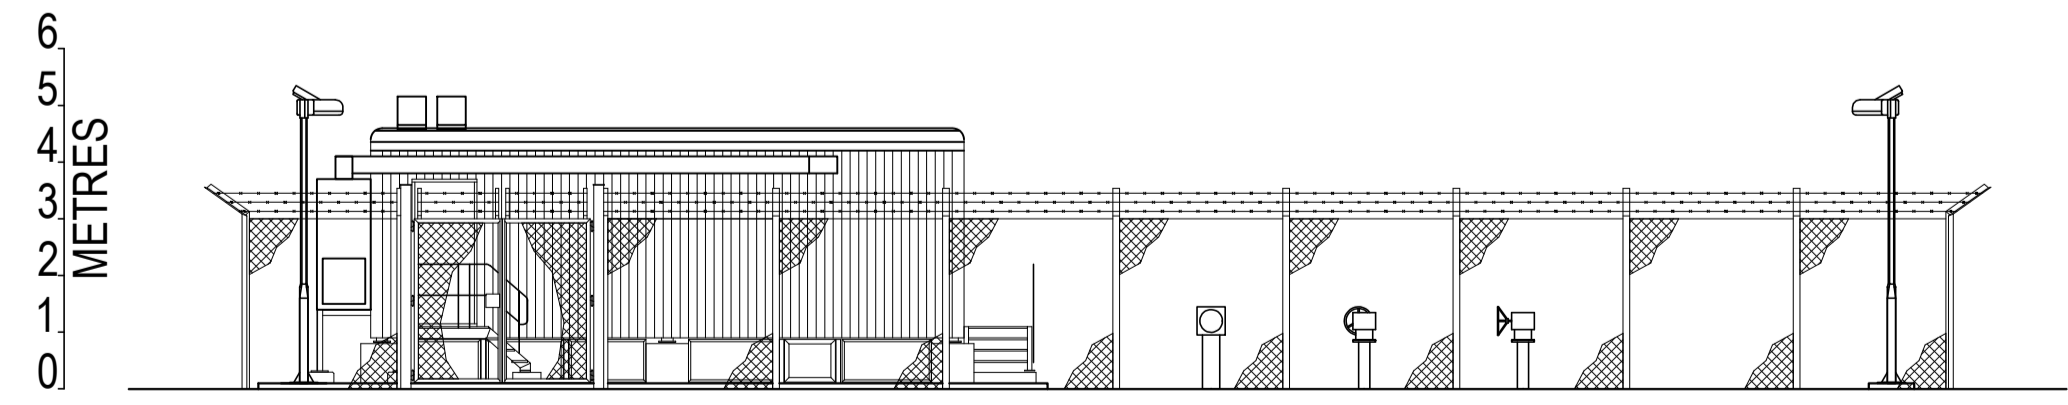

WEST ELEVATION D-D

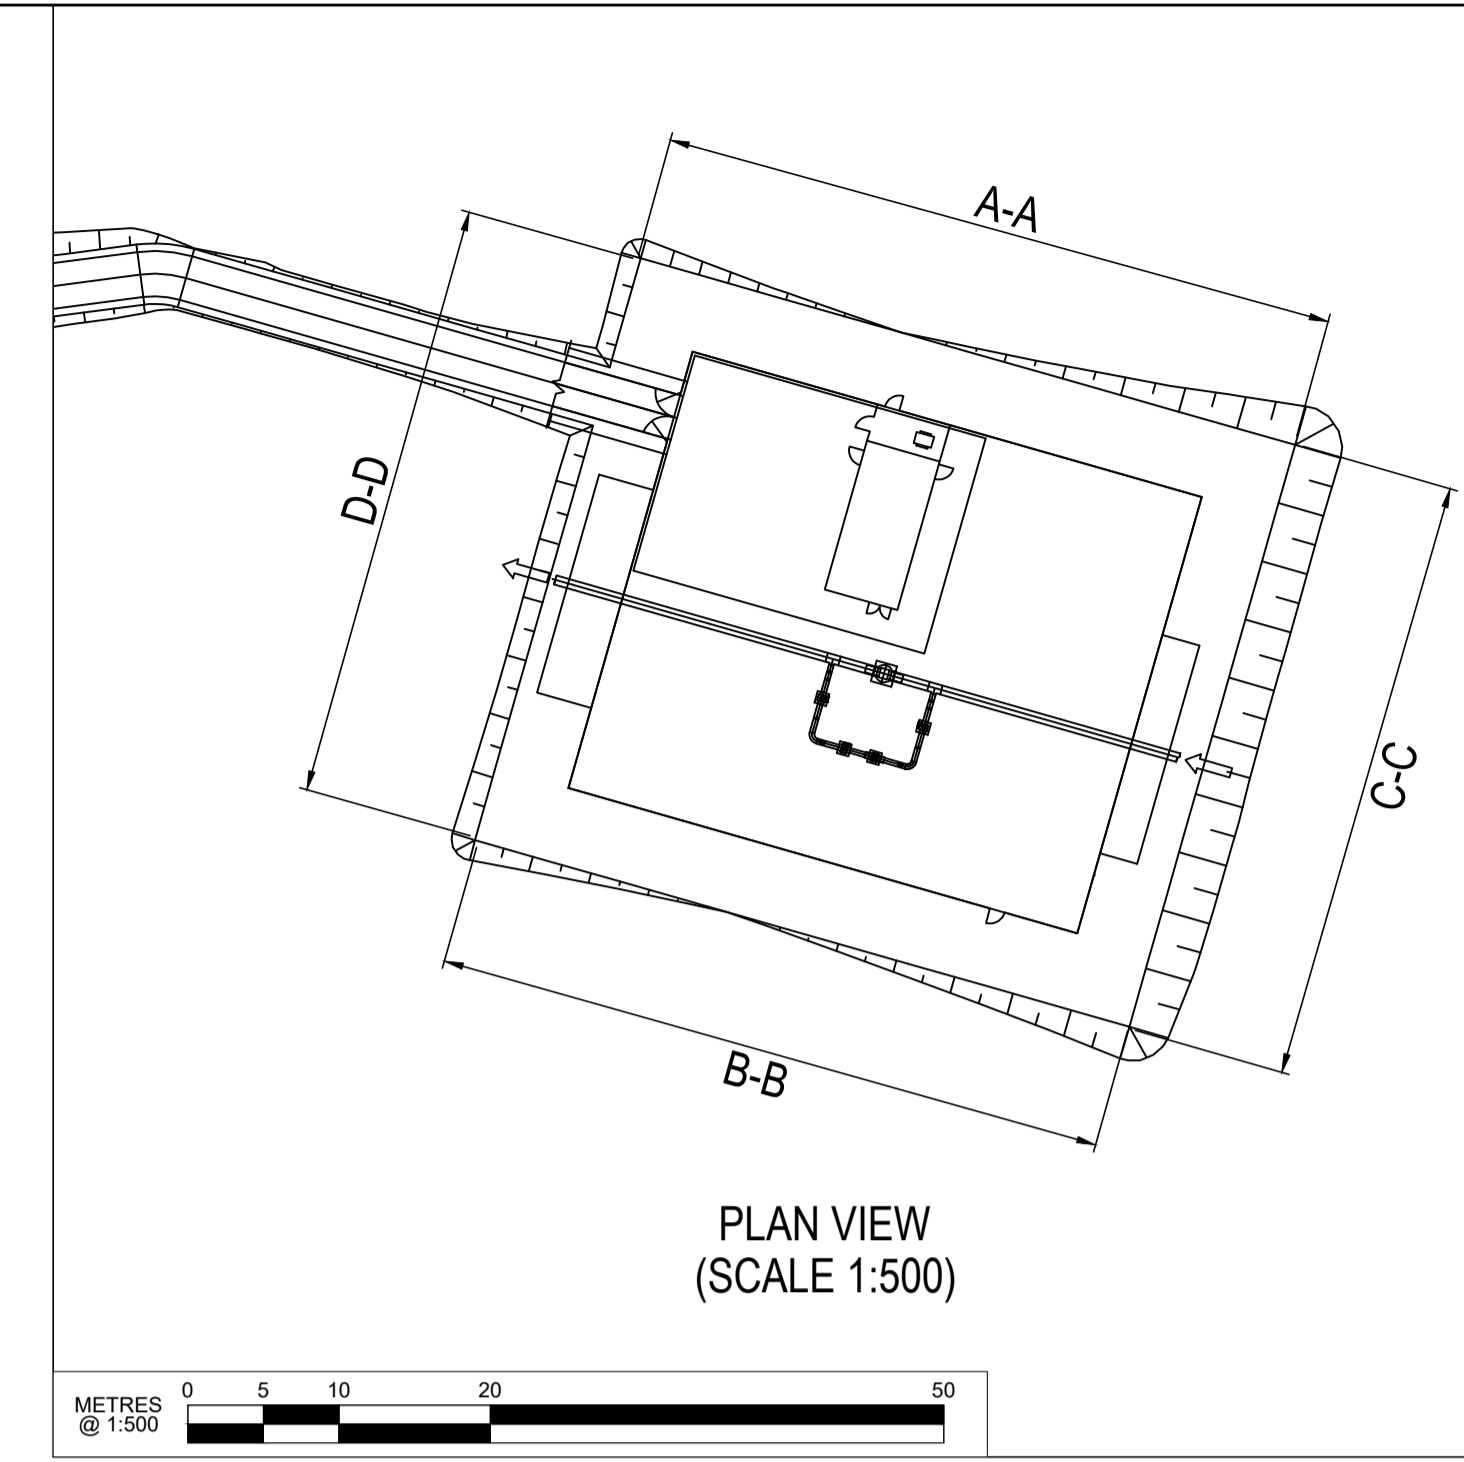

PLAN VIEW
(SCALE 1:500)

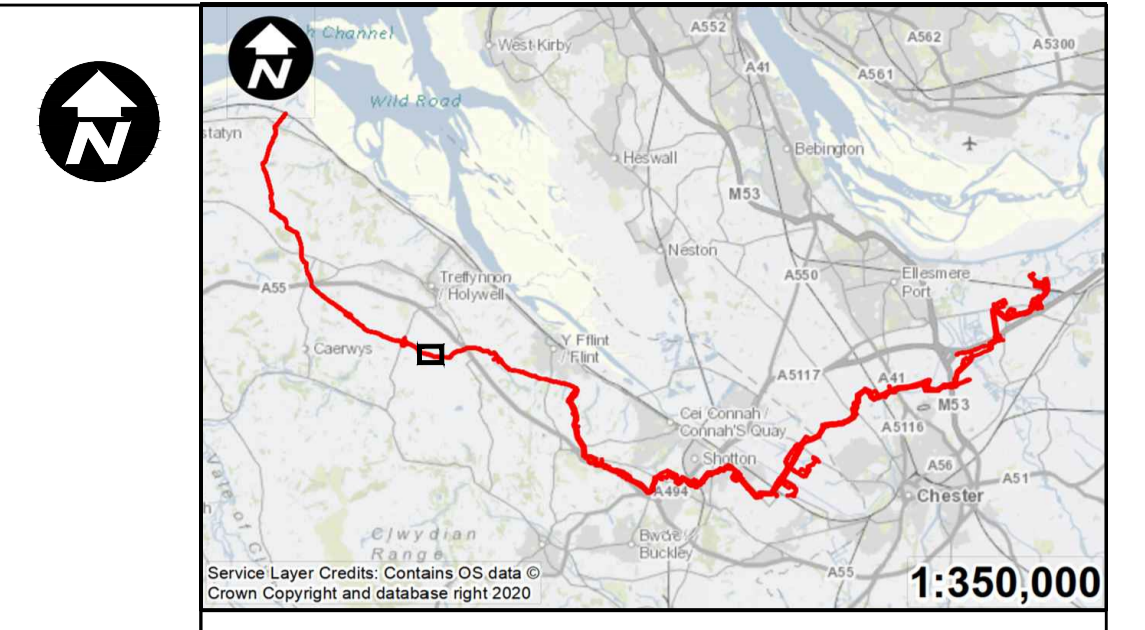

Contains OS data © Crown Copyright and database right 2020

HyNet North West


PROJECT TITLE
HyNet Carbon Dioxide Pipeline DCO

DRAWING TITLE
PENTRE HALKYN BVS
ELEVATION PLAN
REGULATION 5(2)(o)
APPLICATION DOCUMENT REFERENCE D.2.8
SHEET 5 OF 6


DRAWING STATUS
FOR DCO SUBMISSION

DRAWN TO	CHECKED JH	APPROVED VB	AUTHORISED AV
SCALE @ A1 SIZE 1:150	DATE 27/09/2022	REVISION A	


DRAWING NUMBER
EN070007-D.2.8-EL-Sheet 5

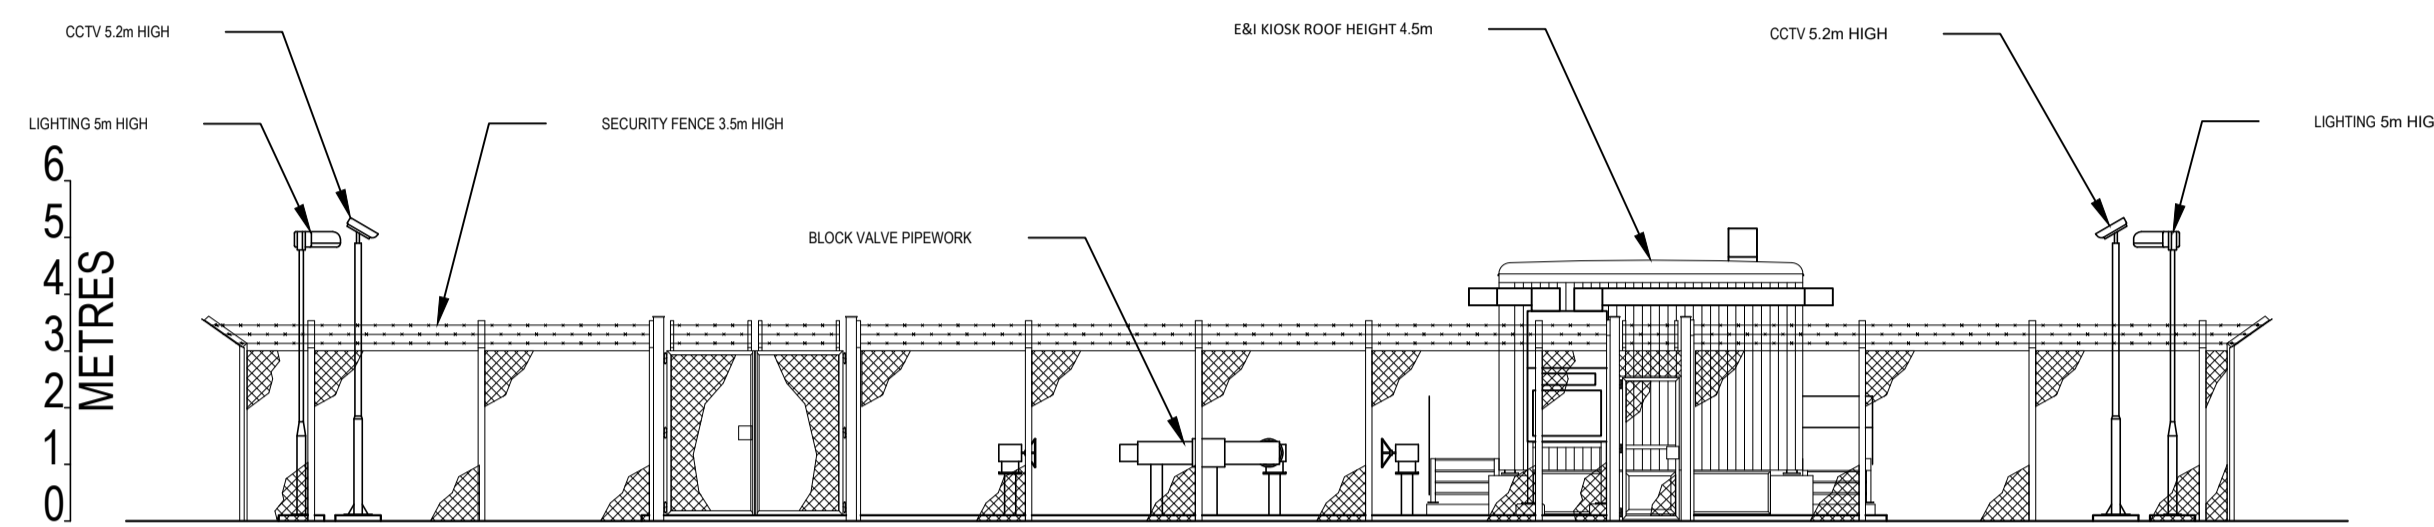


NORTH ELEVATION A-A

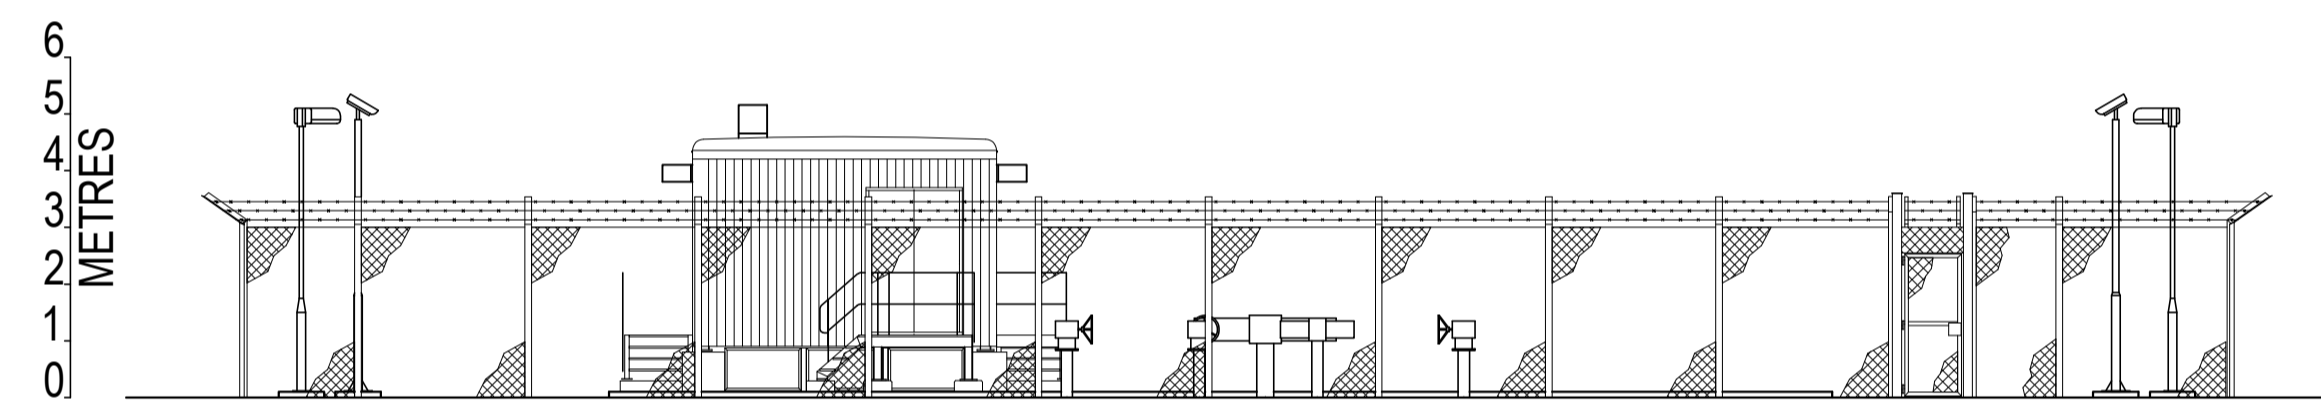



SOUTH ELEVATION B-B

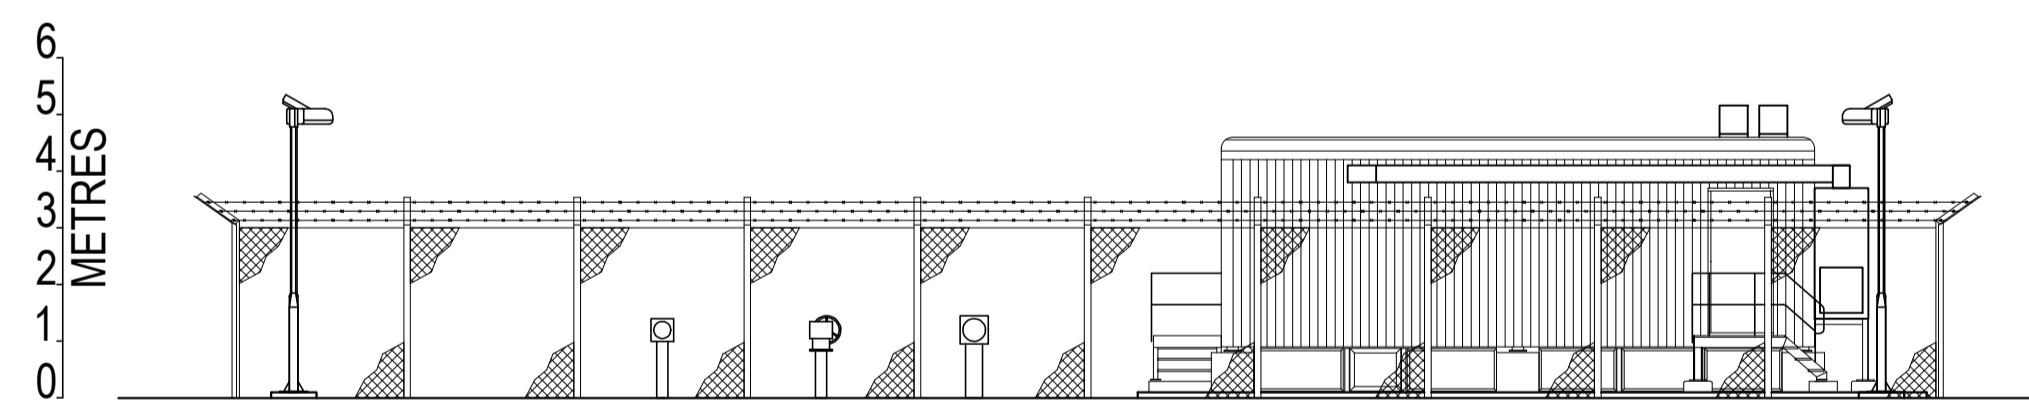

EAST ELEVATION C-C

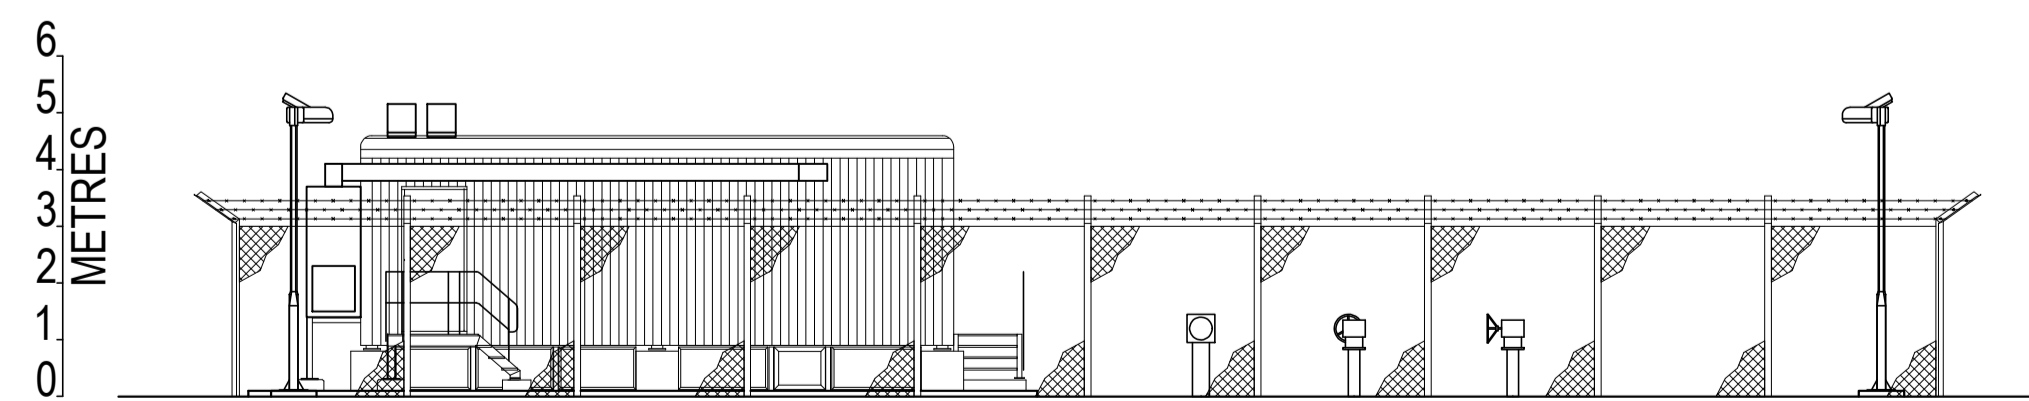

WEST ELEVATION D-D

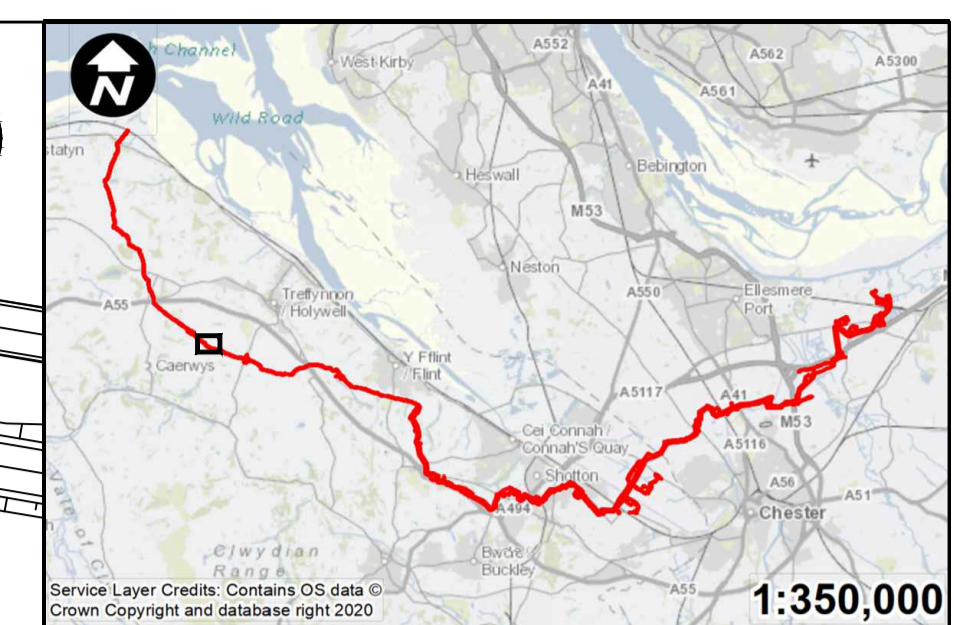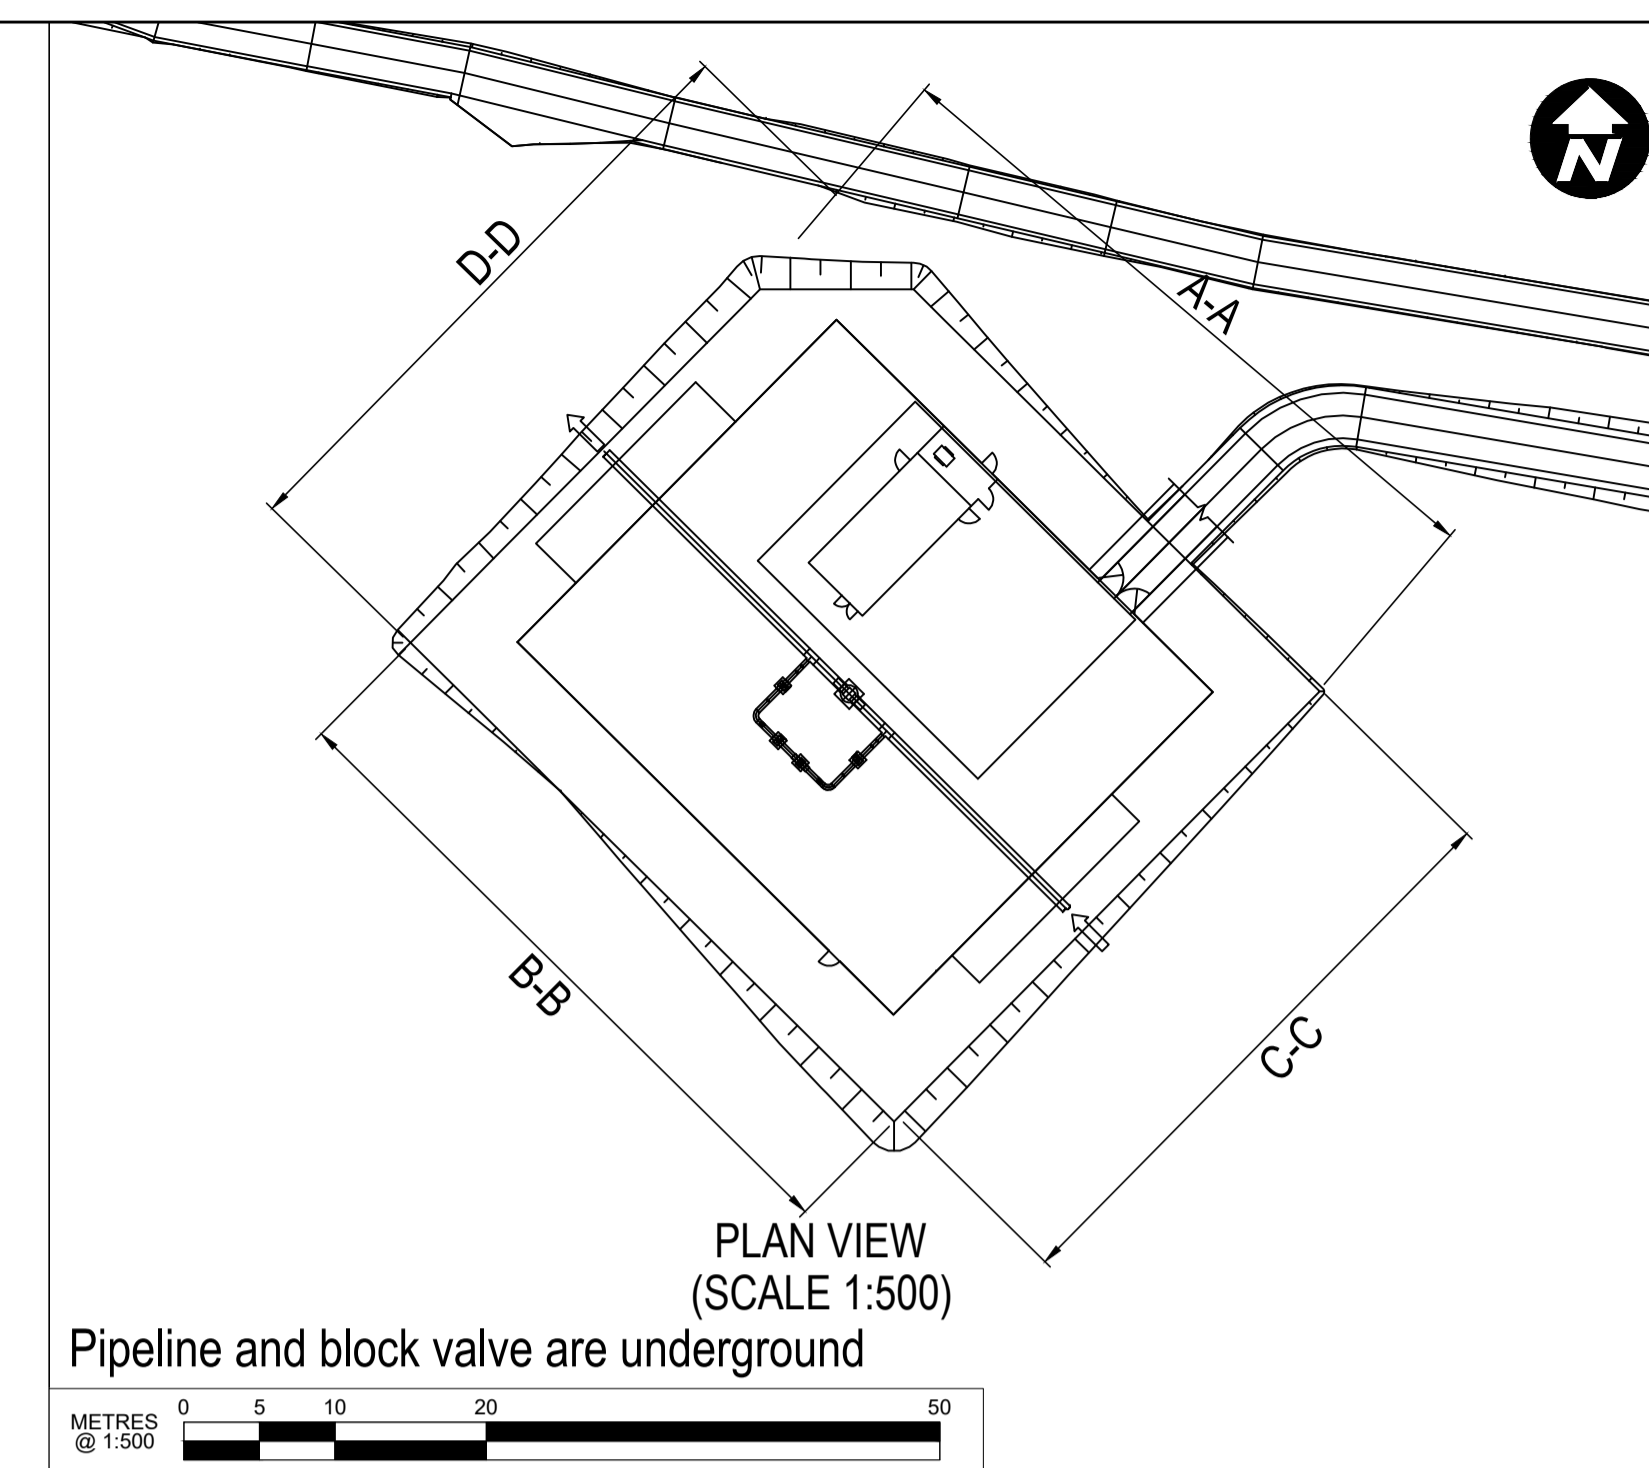

Contains OS data © Crown Copyright and database right 2020

HyNet North West

PROJECT TITLE
HyNet Carbon Dioxide Pipeline DCO

DRAWING TITLE
BABELL BVS
ELEVATION PLAN
REGULATION 5(2)(c)
APPLICATION DOCUMENT REFERENCE D.2.8
SHEET 6 OF 6

DRAWING STATUS
FOR DCO SUBMISSION

DRAWN TO	CHECKED JH	APPROVED VB	AUTHORISED AV
----------	------------	-------------	---------------

SCALE @ A1 SIZE 1:150	DATE 27/09/2022	REVISION A
--------------------------	--------------------	---------------

DRAWING NUMBER
EN070007-D.2.8-EL-Sheet 6