

# The Sizewell C Project

2.5 Main Development Site Nuclear Island (Unit 1) Plans For Approval

May 2020

Planning Act 2008 Infrastructure Planning (Applications: Prescribed Forms and Procedure) Regulations 2009 Revision: 1.0

Applicable Regulation: Regulation 5(2)(o)


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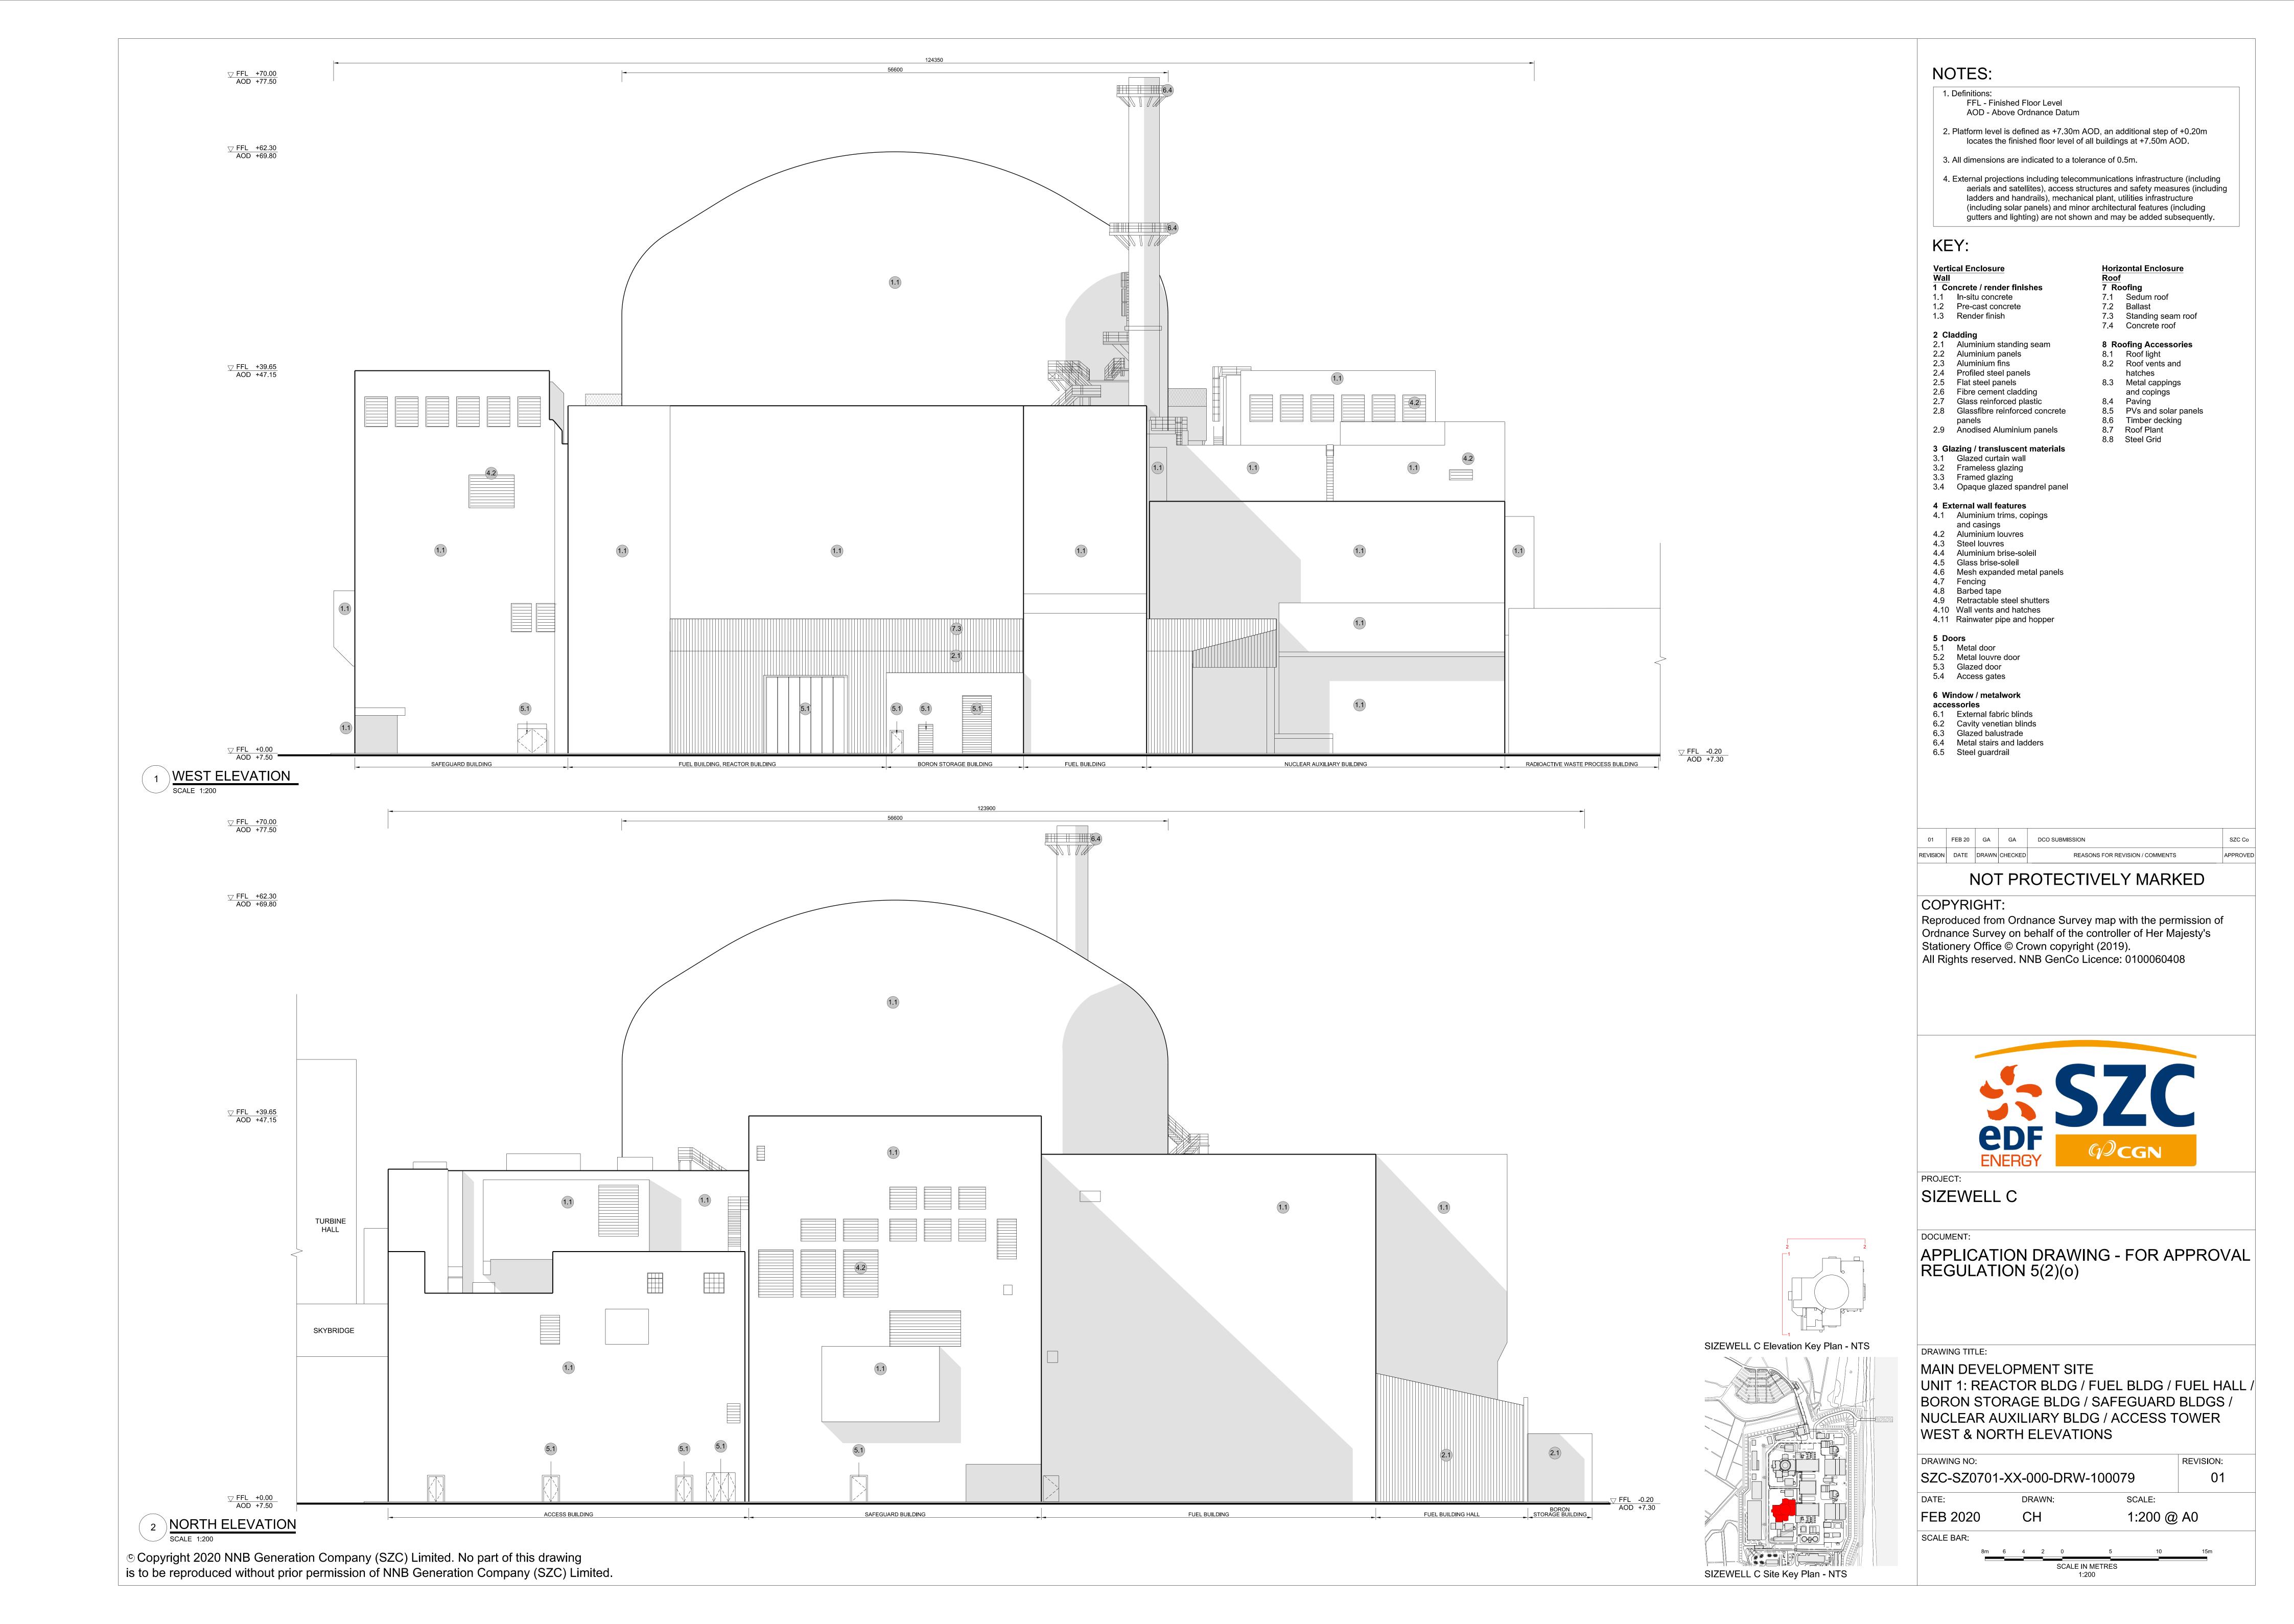



## Main Development Site, Nuclear Island Plans (Unit 1) – For Approval

Drawing Number	Revision	Drawing Title	Scale	Sheet Size			
Unit 1: Reactor Bldg / Fuel Bldg / Fuel Bldg Hall / Boron Storage / Safeguard Bldgs / Nuclear Auxiliary Bldg / Access Tower							
SZC-SZ0701-XX-000-DRW-100078	01	Roof Plan	1:200	A0			
SZC-SZ0701-XX-000-DRW-100079	01	West & North Elevations	1:200	A0			
SZC-SZ0701-XX-000-DRW-100080	01	East & South Elevations	1:200	A0			
Unit 1: Radioactive Waste Storage / Radioactive Waste Process Building							
SZC-SZ0701-XX-000-DRW-100081	01	Roof Plan	1:200	A1			
SZC-SZ0701-XX-000-DRW-100082	01	Elevations	1:200	A1			
Unit 1: Hot Laundry Building / Hot workshop / Hot warehouse / Facilities for Decontamination / Effluent Tanks/ Refuelling Water Storage Tank							
SZC-SZ0701-XX-000-DRW-100083	01	Roof Plan	1:200	A1			
SZC-SZ0701-XX-000-DRW-100084	01	Elevations	1:200	A1			
Unit 1: Emergency Diesel Generator Building - A/ Cooling Water Discharge Weir Building (Type 2)							
SZC-SZ0701-XX-000-DRW-100085	01	Roof Plan	1:200	A1			
SZC-SZ0701-XX-000-DRW-100086	01	Elevations	1:200	A1			
Unit 1: Emergency Diesel Generator Building – B/ Cooling Water Discharge Weir Building (Type 1)							
SZC-SZ0701-XX-000-DRW-100087	01	Roof Plan	1:200	A1			
SZC-SZ0701-XX-000-DRW-100088	01	Elevations	1:200	A1			






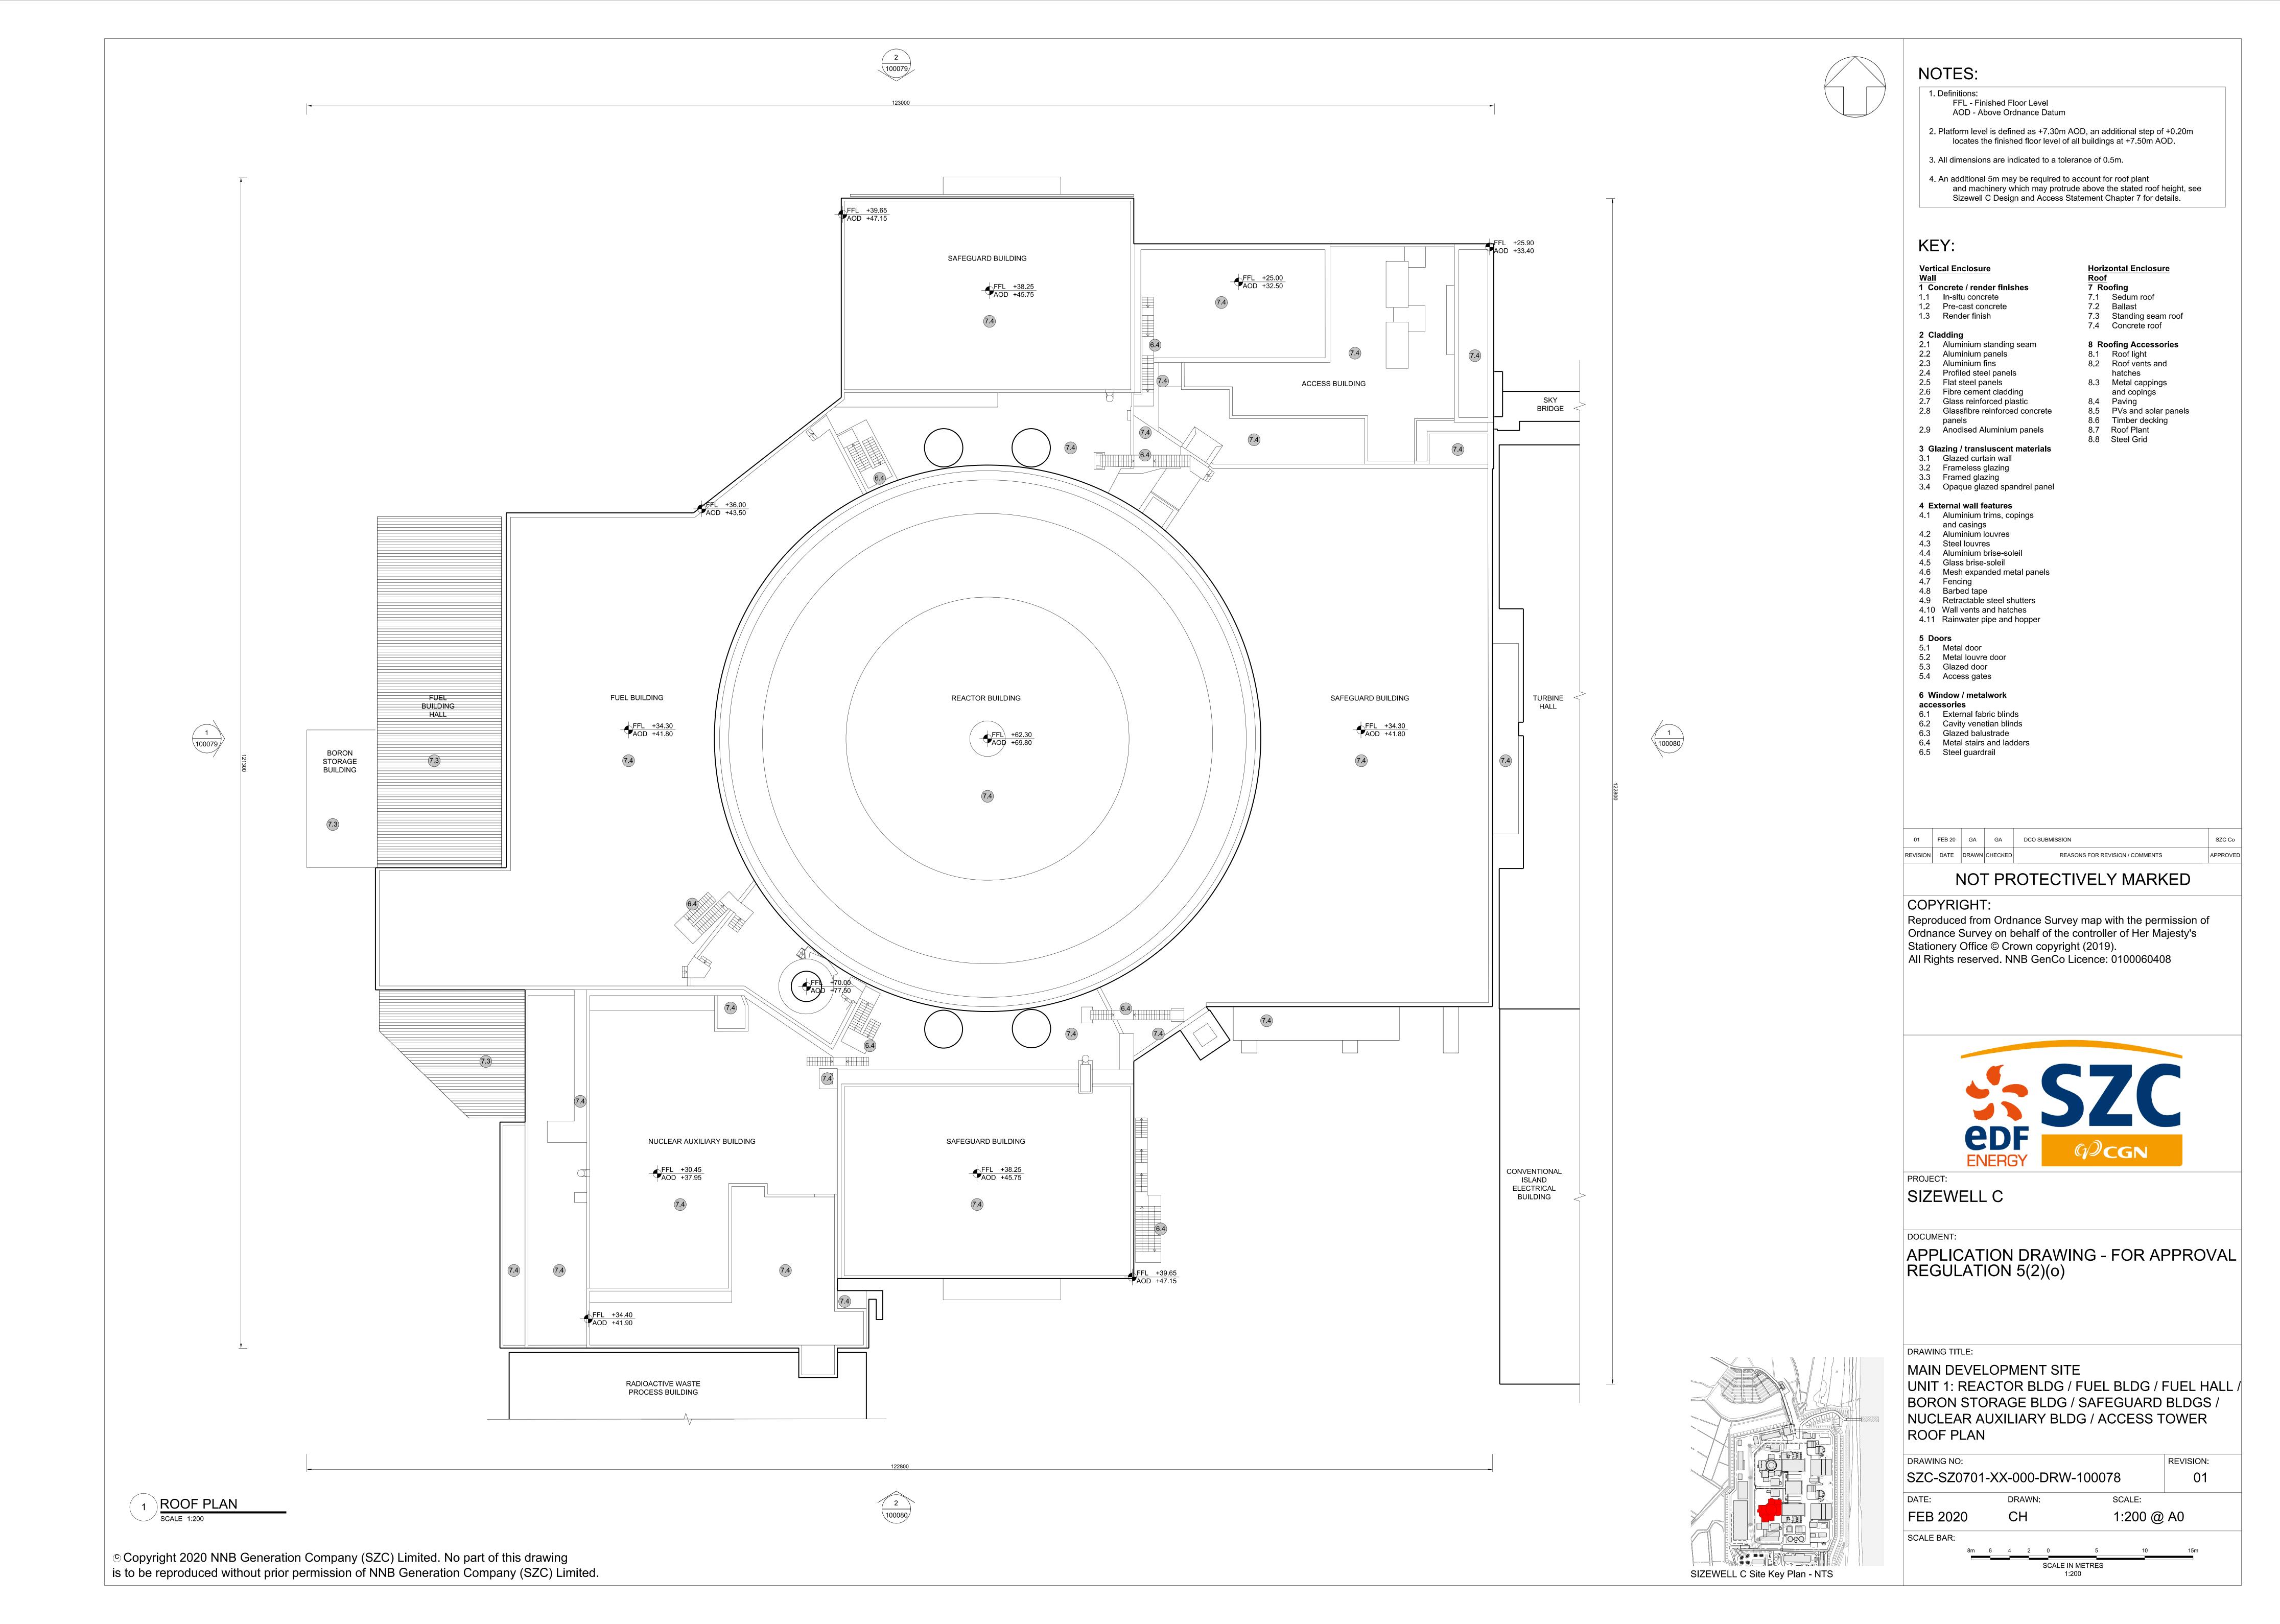

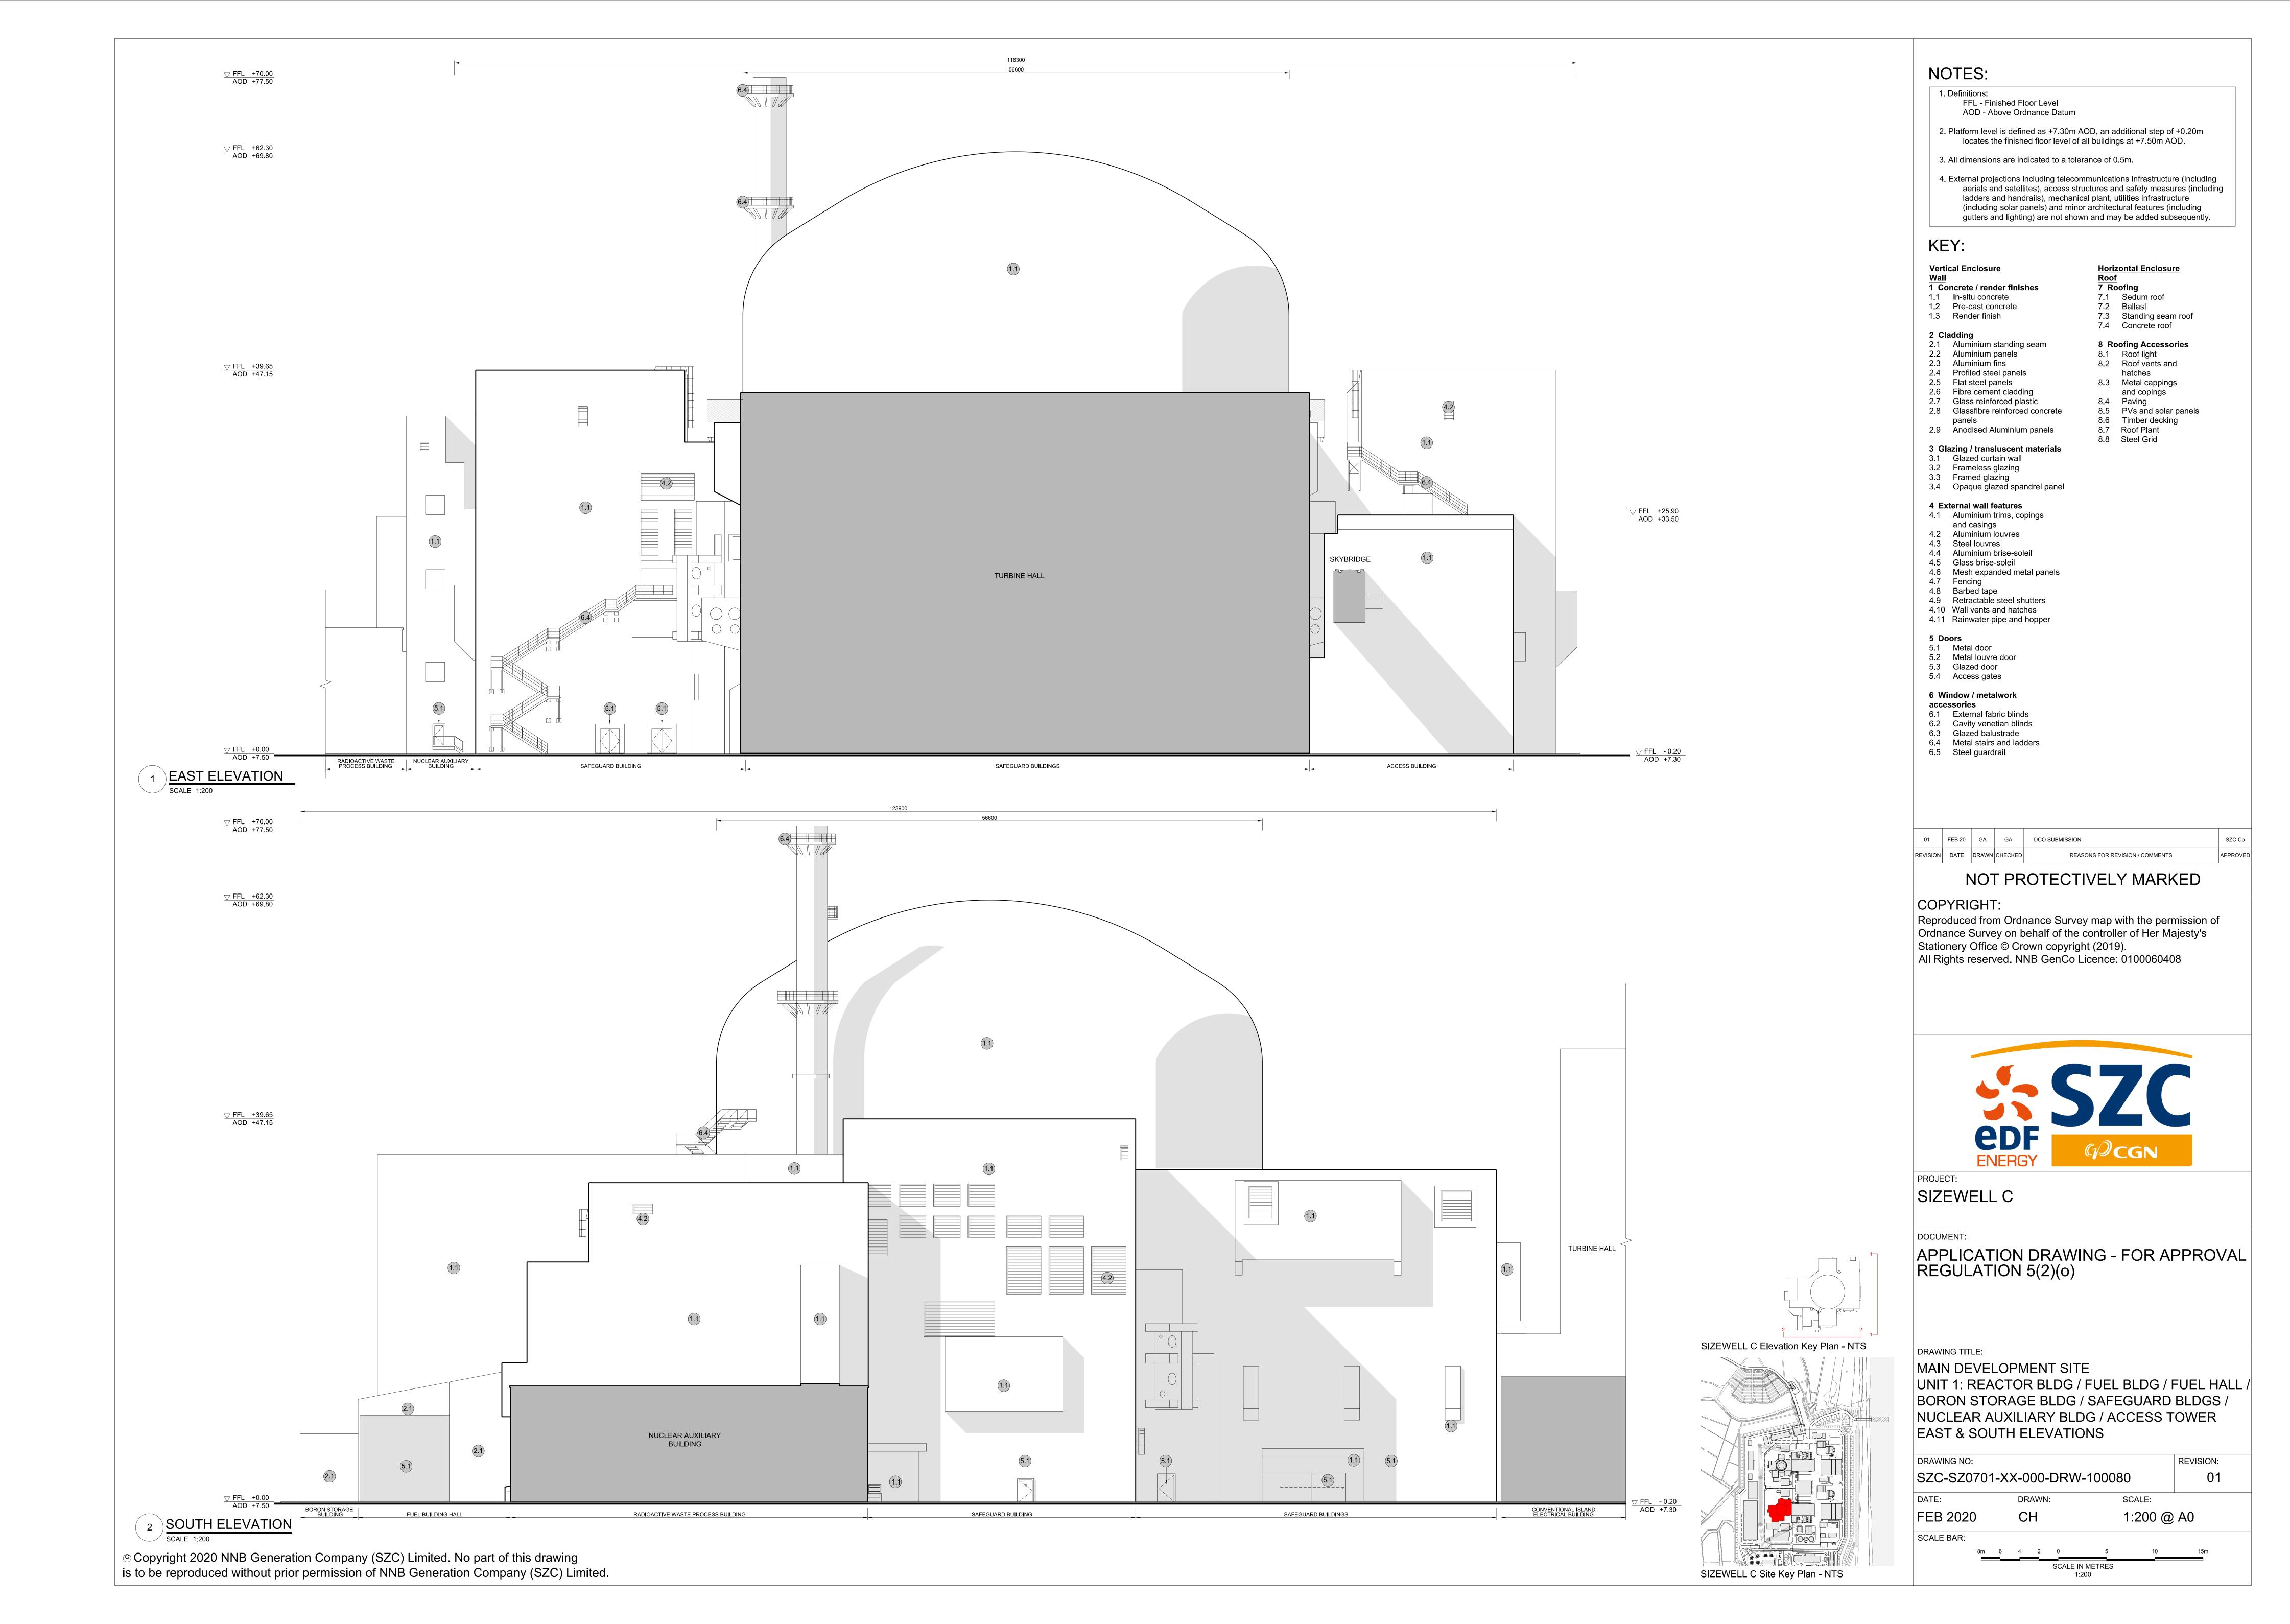





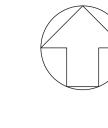

**NOTES:** 

1. Definitions: FFL - Finished Floor Level AOD - Above Ordnance Datum

2. Platform level is defined as +7.30m AOD, an additional step of +0.20m locates the finished floor level of all buildings at +7.50m AOD.

3. All dimensions are indicated to a tolerance of 0.5m.

4. An additional 5m may be required to account for roof plant and machinery which may protrude above stated roof height, see Sizewell C Design and Access Statement for details.

5 Doors

5.1 Metal door

5.3 Glazed door 5.4 Access gates

accessories

5.2 Metal louvre door

6.1 External fabric blinds 6.2 Cavity venetian blinds

6.3 Glazed balustrade

6.4 Metal stairs and

ladders

6.5 Steel guardrail

**Horizontal Enclosure** 

7.3 Standing seam roof

8 Roofing Accessories

8.2 Roof vents and

hatches

8.3 Metal cappings

8.6 Timber decking

8.4 Paving

8.7 Roof Plant

8.8 Steel Grid

and copings

8.5 PVs and solar panels

7.1 Sedum roof 7.2 Ballast

7.4 Concrete roof

7 Roofing

### KEY: Vertical Enclosure

1 Concrete / render finishes 1.1 In-situ concrete

1.2 Pre-cast concrete 1.3 Render finish

## 2 Cladding

2.1 Aluminium standing seam 6 Window / metalwork 2.2 Aluminium panels 2.3 Aluminium fins

2.4 Profiled steel panels 2.5 Flat steel panels 2.6 Fibre cement cladding

2.7 Glass reinforced plastic 2.8 Glassfibre reinforced concrete panels

### 2.9 Anodised Aluminium panels

### 3 Glazing / transluscent materials

3.1 Glazed curtain wall 3.2 Frameless glazing 3.3 Framed glazing

3.4 Opaque glazed spandrel panel

### 4 External wall features 4.1 Aluminium trims, copings 8.1 Roof light and casings

4.2 Aluminium louvres 4.3 Steel louvres

4.4 Aluminium brise-soleil 4.5 Glass brise-soleil 4.6 Mesh expanded metal

panels 4.7 Fencing 4.8 Barbed tape 4.9 Retractable steel shutters

4.10 Wall vents and hatches 4.11 Rainwater pipe and hopper

01 FEB 20 GA GA DCO SUBMISSION REVISION DATE DRAWN CHECKED REASONS FOR REVISION / COMMENTS

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SIZEWELL C

APPLICATION DRAWING - FOR APPROVAL REGULATION 5(2)(o)


### DRAWING TITLE:

MAIN DEVELOPMENT SITE UNIT 1:RADIOACTIVE WASTE STORAGE BLDG / RADIOACTIVE WASTE PROCESS BLDG **ROOF PLAN** 

REVISION: SZC-SZ0701-XX-000-DRW-100081 01 DRAWN: 1:200 @ A1 FEB 2020 CH


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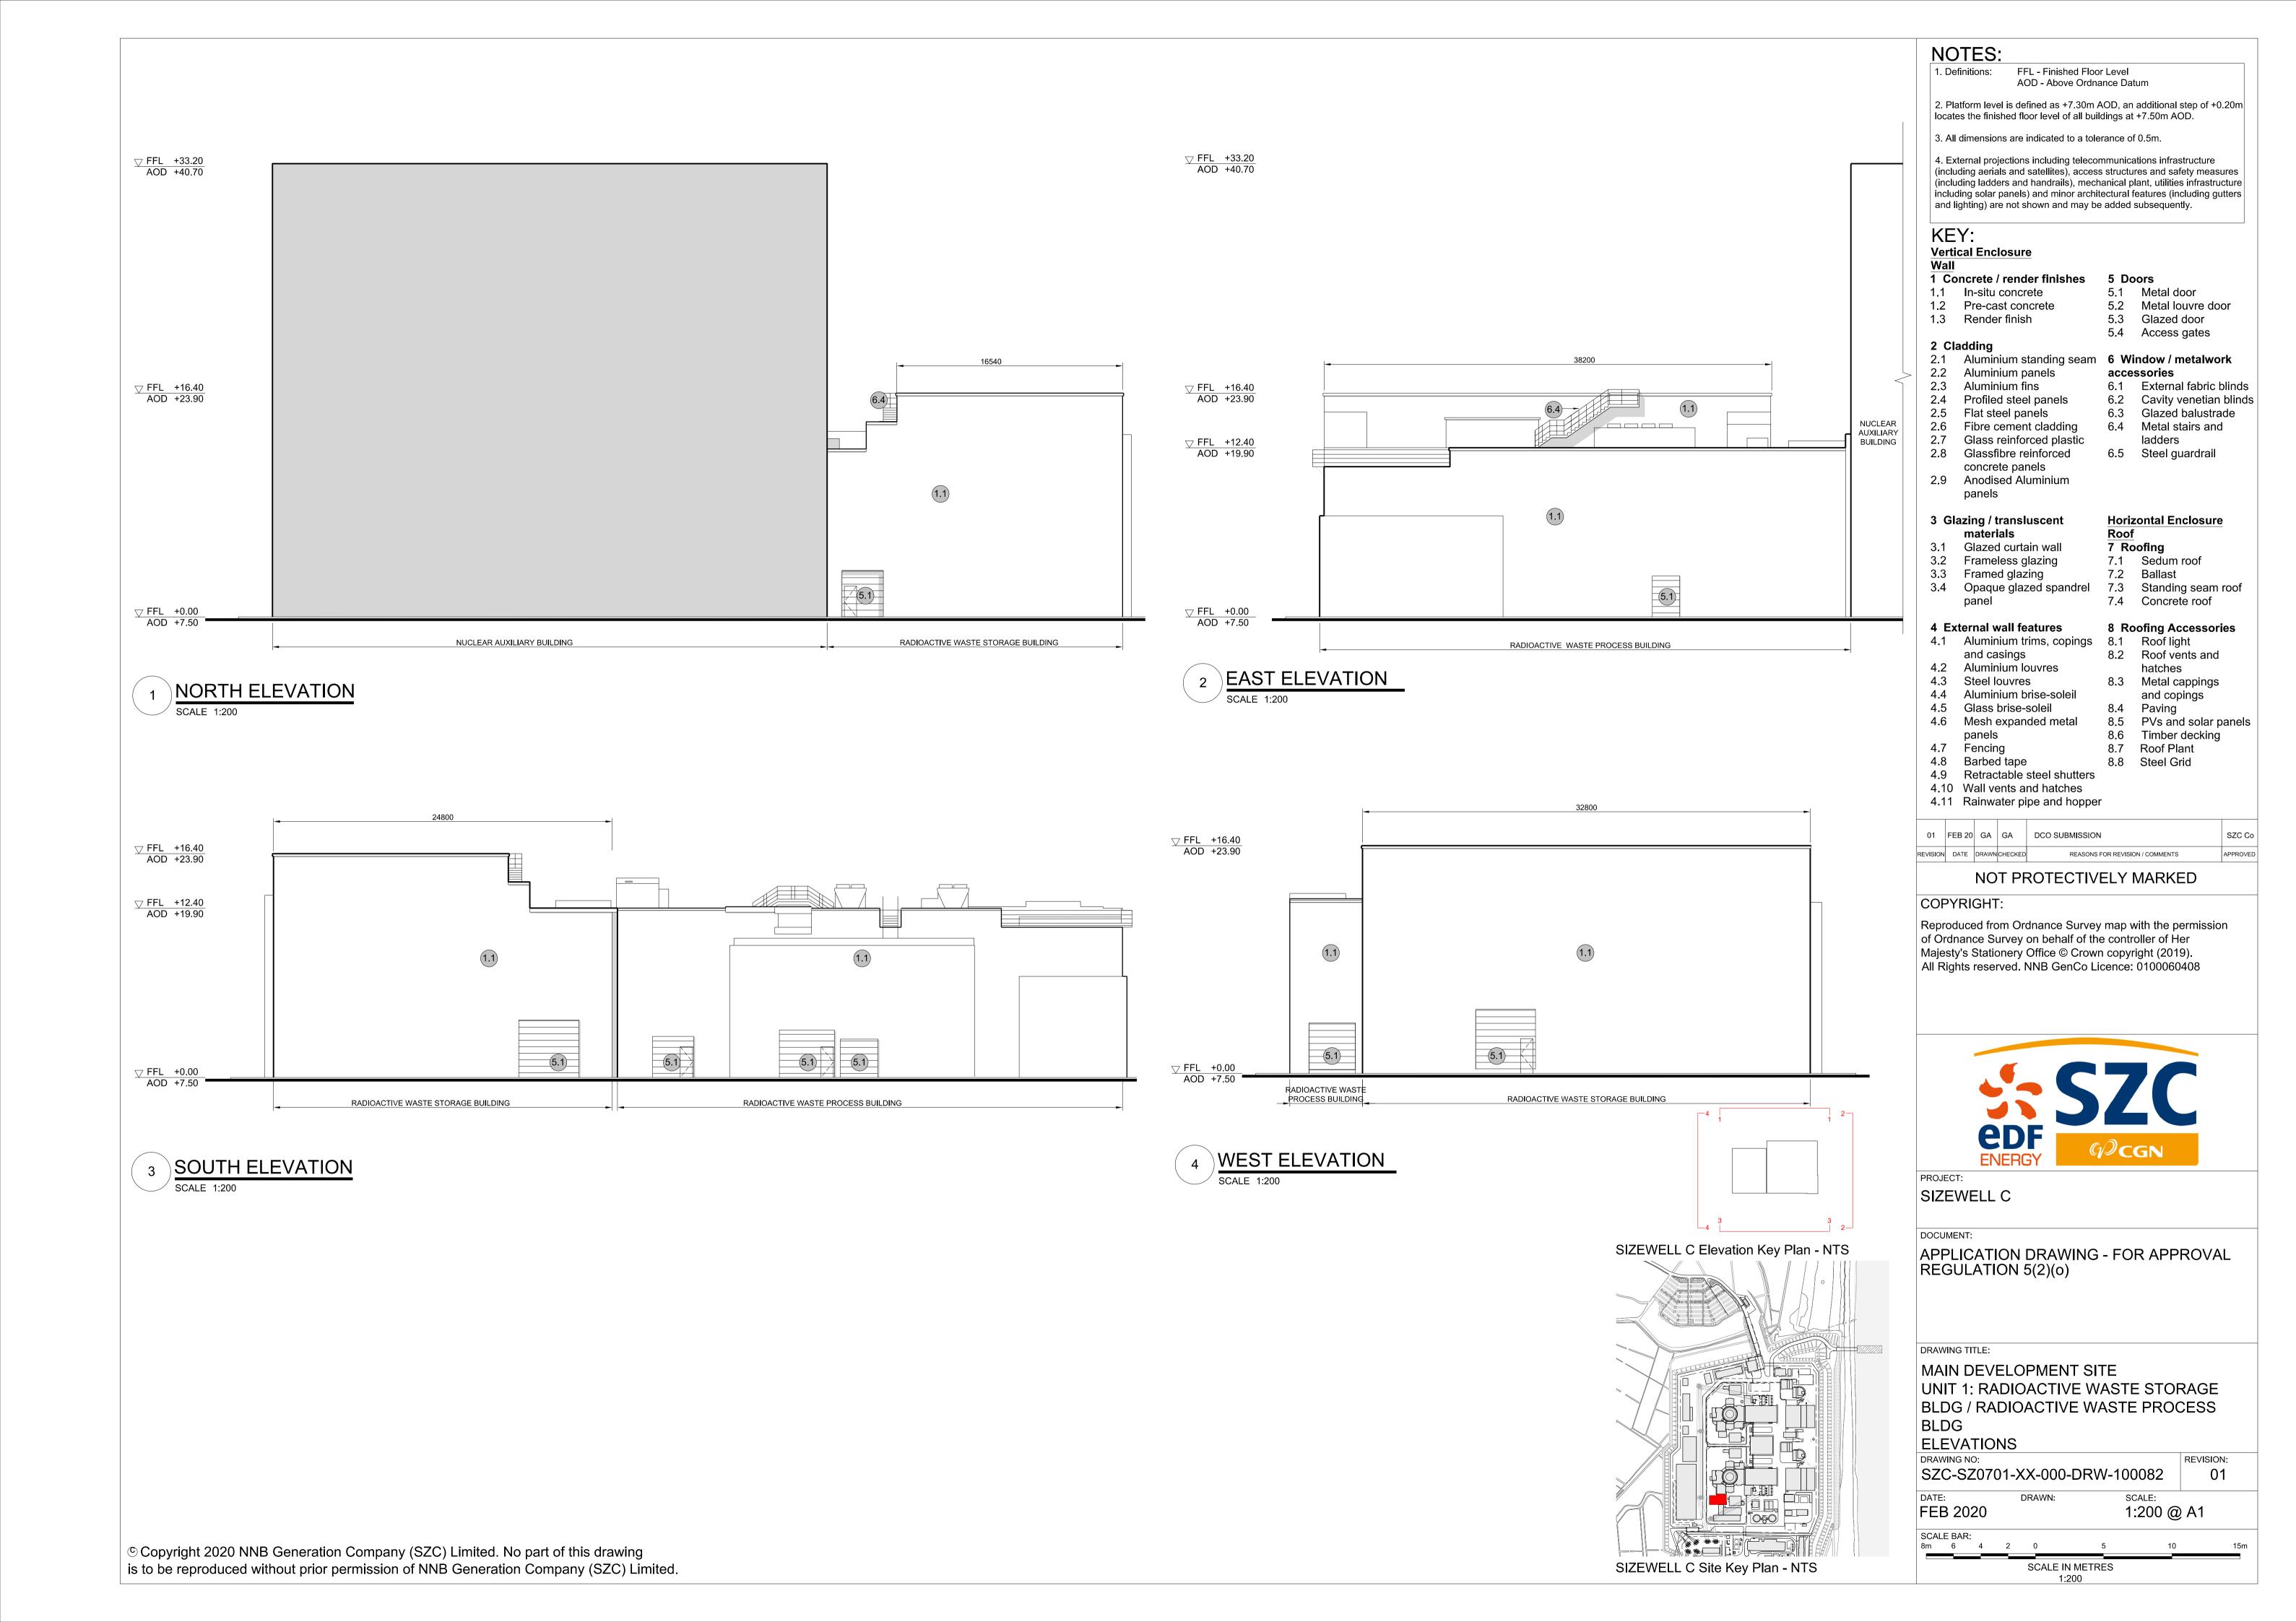





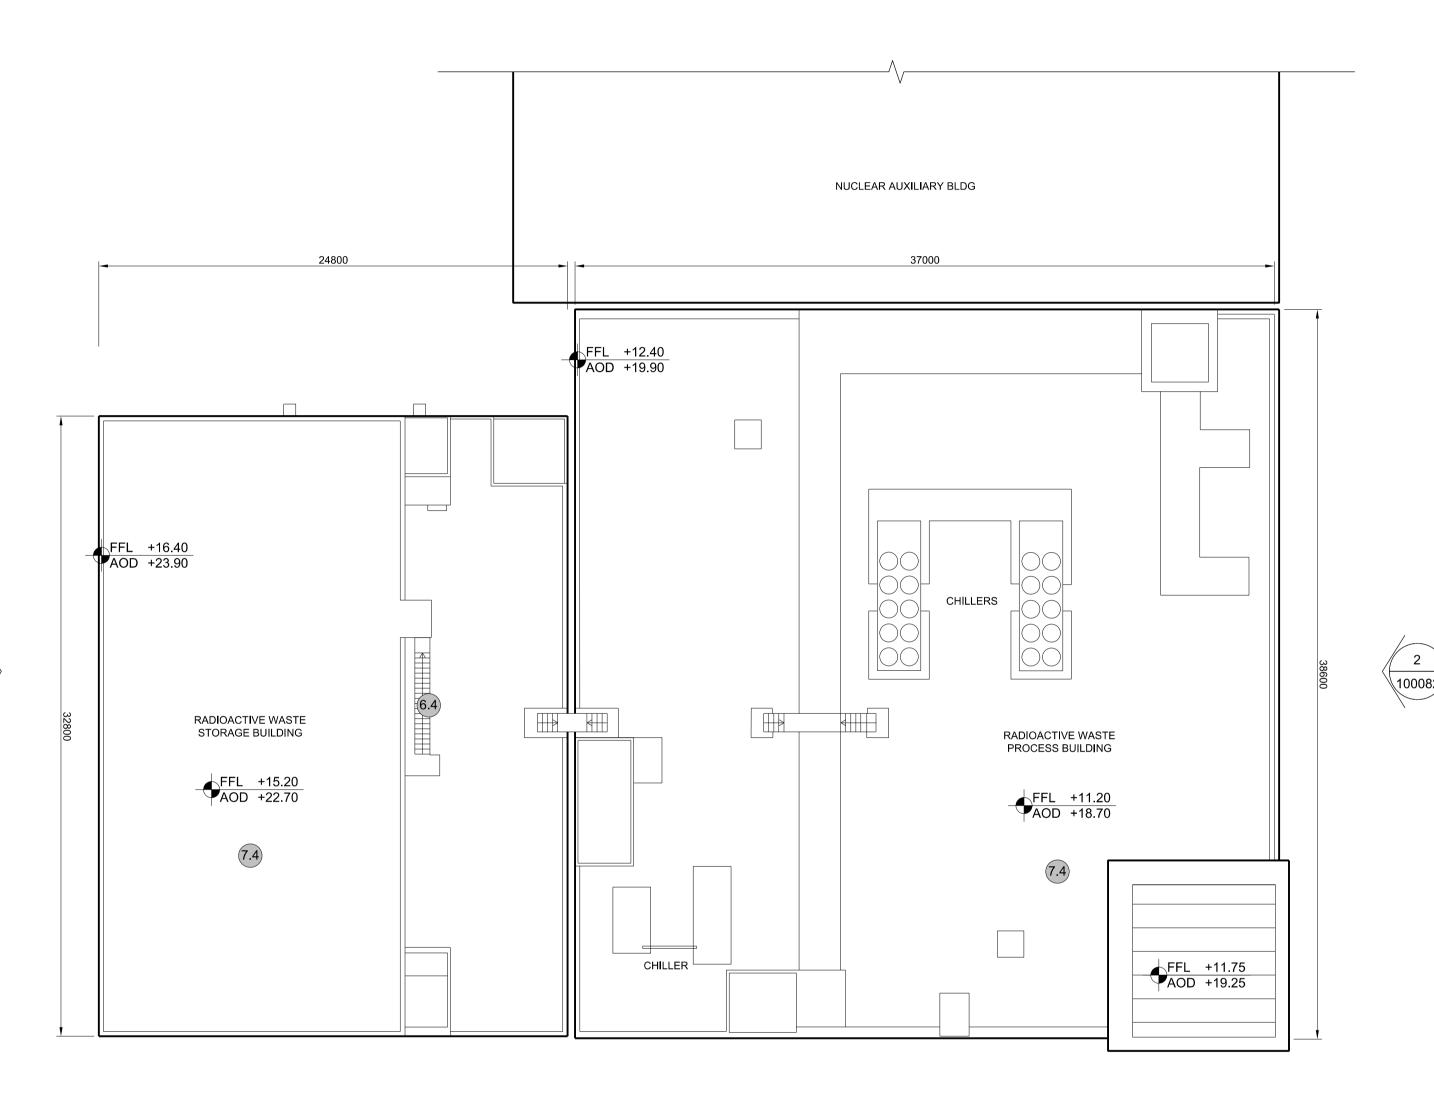





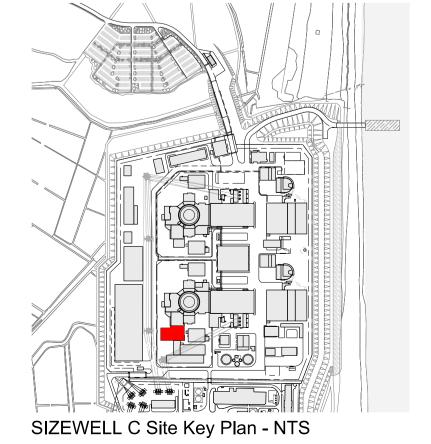


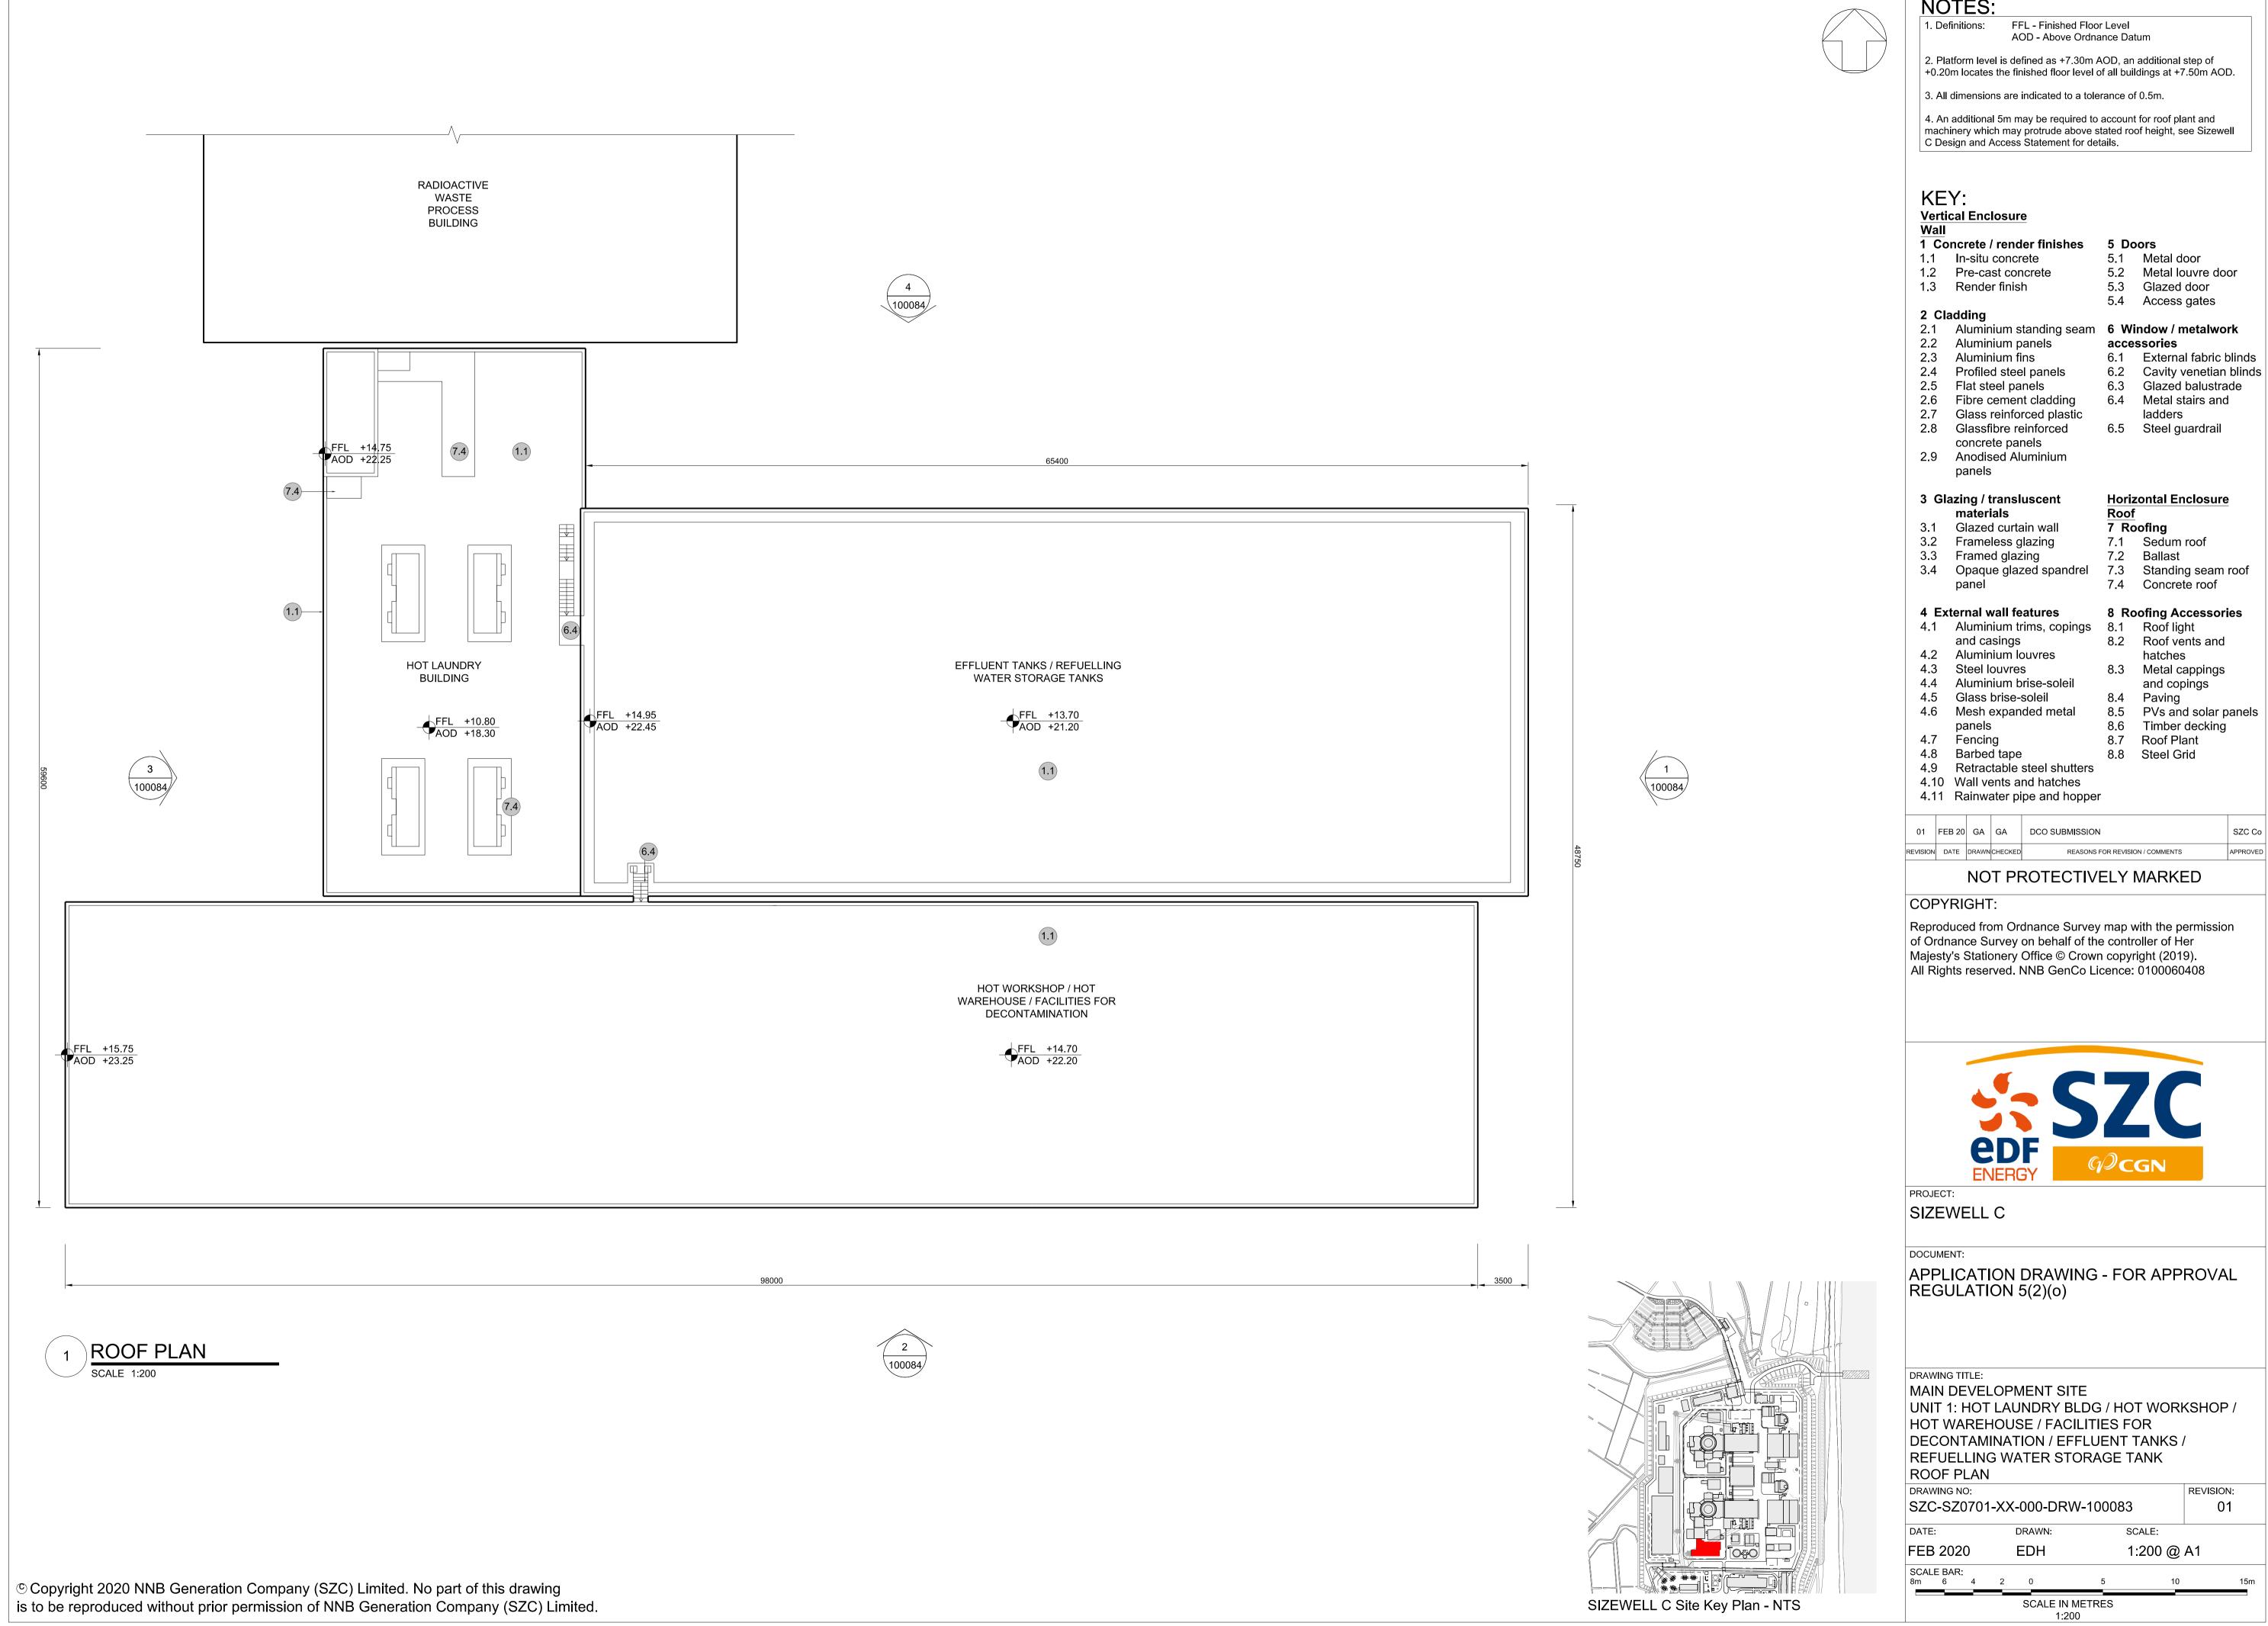

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### KEY: Vertical Enclosure

1.3 Render finish

1 Concrete / render finishes 1.1 In-situ concrete 1.2 Pre-cast concrete

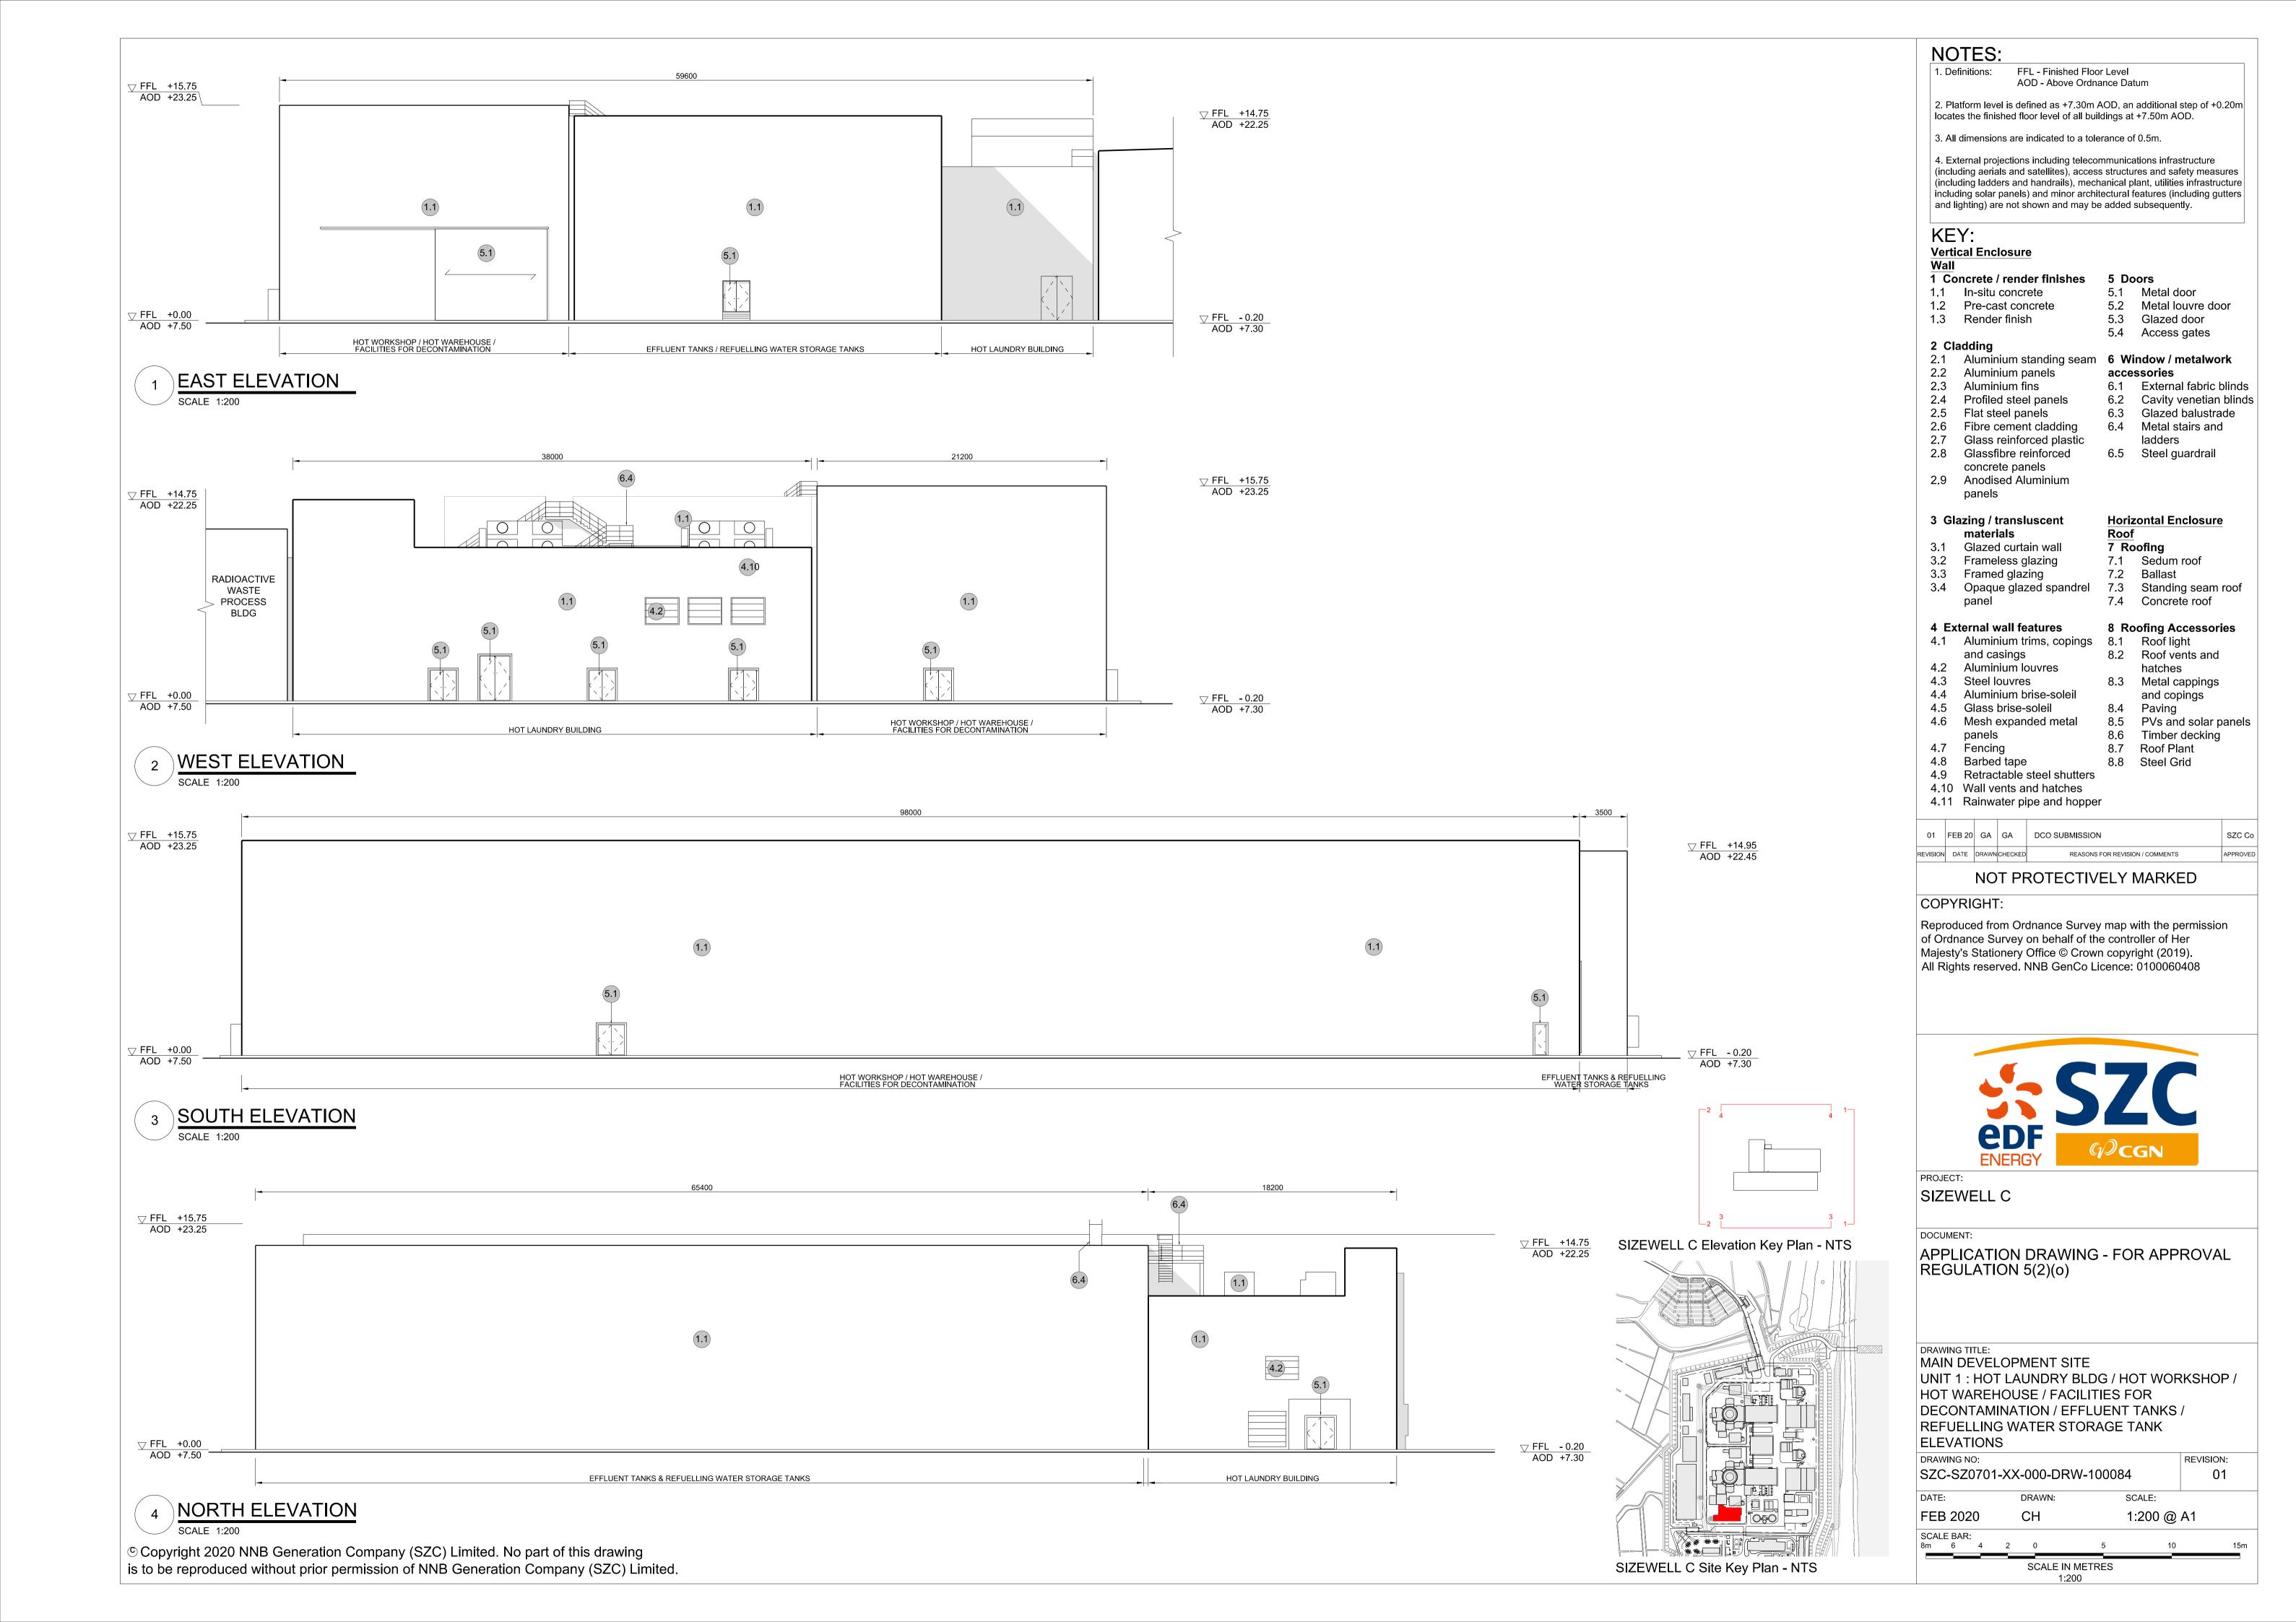5.2 Metal louvre door 5.3 Glazed door 5.4 Access gates

accessories

6.1 External fabric blinds 6.2 Cavity venetian blinds

6.3 Glazed balustrade

6.4 Metal stairs and

ladders

6.5 Steel guardrail

Horizontal Enclosure

7.4 Concrete roof

8.2 Roof vents and

hatches

8.3 Metal cappings

8.6 Timber decking

8.4 Paving

8.7 Roof Plant

8.8 Steel Grid

REASONS FOR REVISION / COMMENTS

and copings

8.5 PVs and solar panels

7 Roofing

5.1 Metal door

5 Doors

### 2 Cladding

2.1 Aluminium standing seam 6 Window / metalwork 2.2 Aluminium panels

2.3 Aluminium fins 2.4 Profiled steel panels 2.5 Flat steel panels

2.6 Fibre cement cladding 2.7 Glass reinforced plastic 2.8 Glassfibre reinforced

concrete panels 2.9 Anodised Aluminium panels

## 3 Glazing / transluscent

materials 3.1 Glazed curtain wall 3.2 Frameless glazing

panel

7.1 Sedum roof 3.3 Framed glazing 7.2 Ballast 3.4 Opaque glazed spandrel 7.3 Standing seam roof

### 4 External wall features 8 Roofing Accessories 4.1 Aluminium trims, copings 8.1 Roof light

and casings 4.2 Aluminium louvres 4.3 Steel louvres

4.4 Aluminium brise-soleil 4.5 Glass brise-soleil 4.6 Mesh expanded metal

panels 4.7 Fencing 4.8 Barbed tape

4.9 Retractable steel shutters 4.10 Wall vents and hatches 4.11 Rainwater pipe and hopper

01 FEB 20 GA GA DCO SUBMISSION

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REVISION DATE DRAWN CHECKED

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SIZEWELL C


DRAWING NO:

APPLICATION DRAWING - FOR APPROVAL REGULATION 5(2)(o)

MAIN DEVELOPMENT SITE UNIT 1: EMERGENCY DIESEL GENERATOR BLDG - A / COOLING WATER DISCHARGE WEIR BLDG (TYPE 2) **ROOF PLAN** 


SZC-SZ070		01		
DATE:	DRAWN:	SC	CALE:	
FEB 2020	CH	1:200 @ A1		
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REVISION:



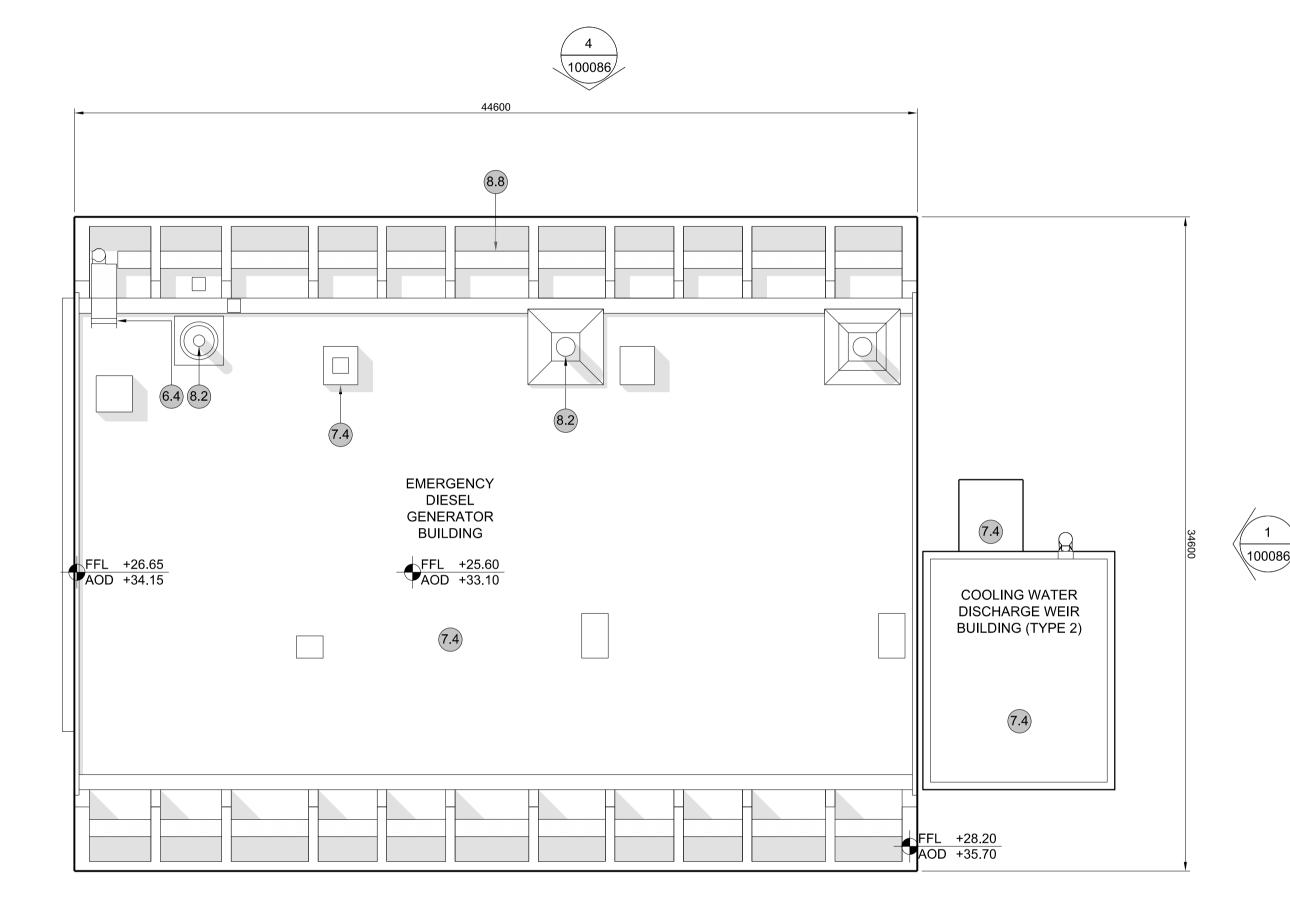



**ROOF PLAN** 

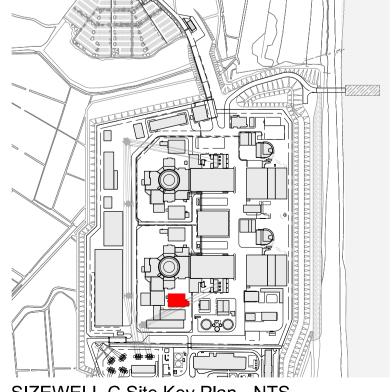


SIZEWELL C Site Key Plan - NTS

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SIZEWELL C

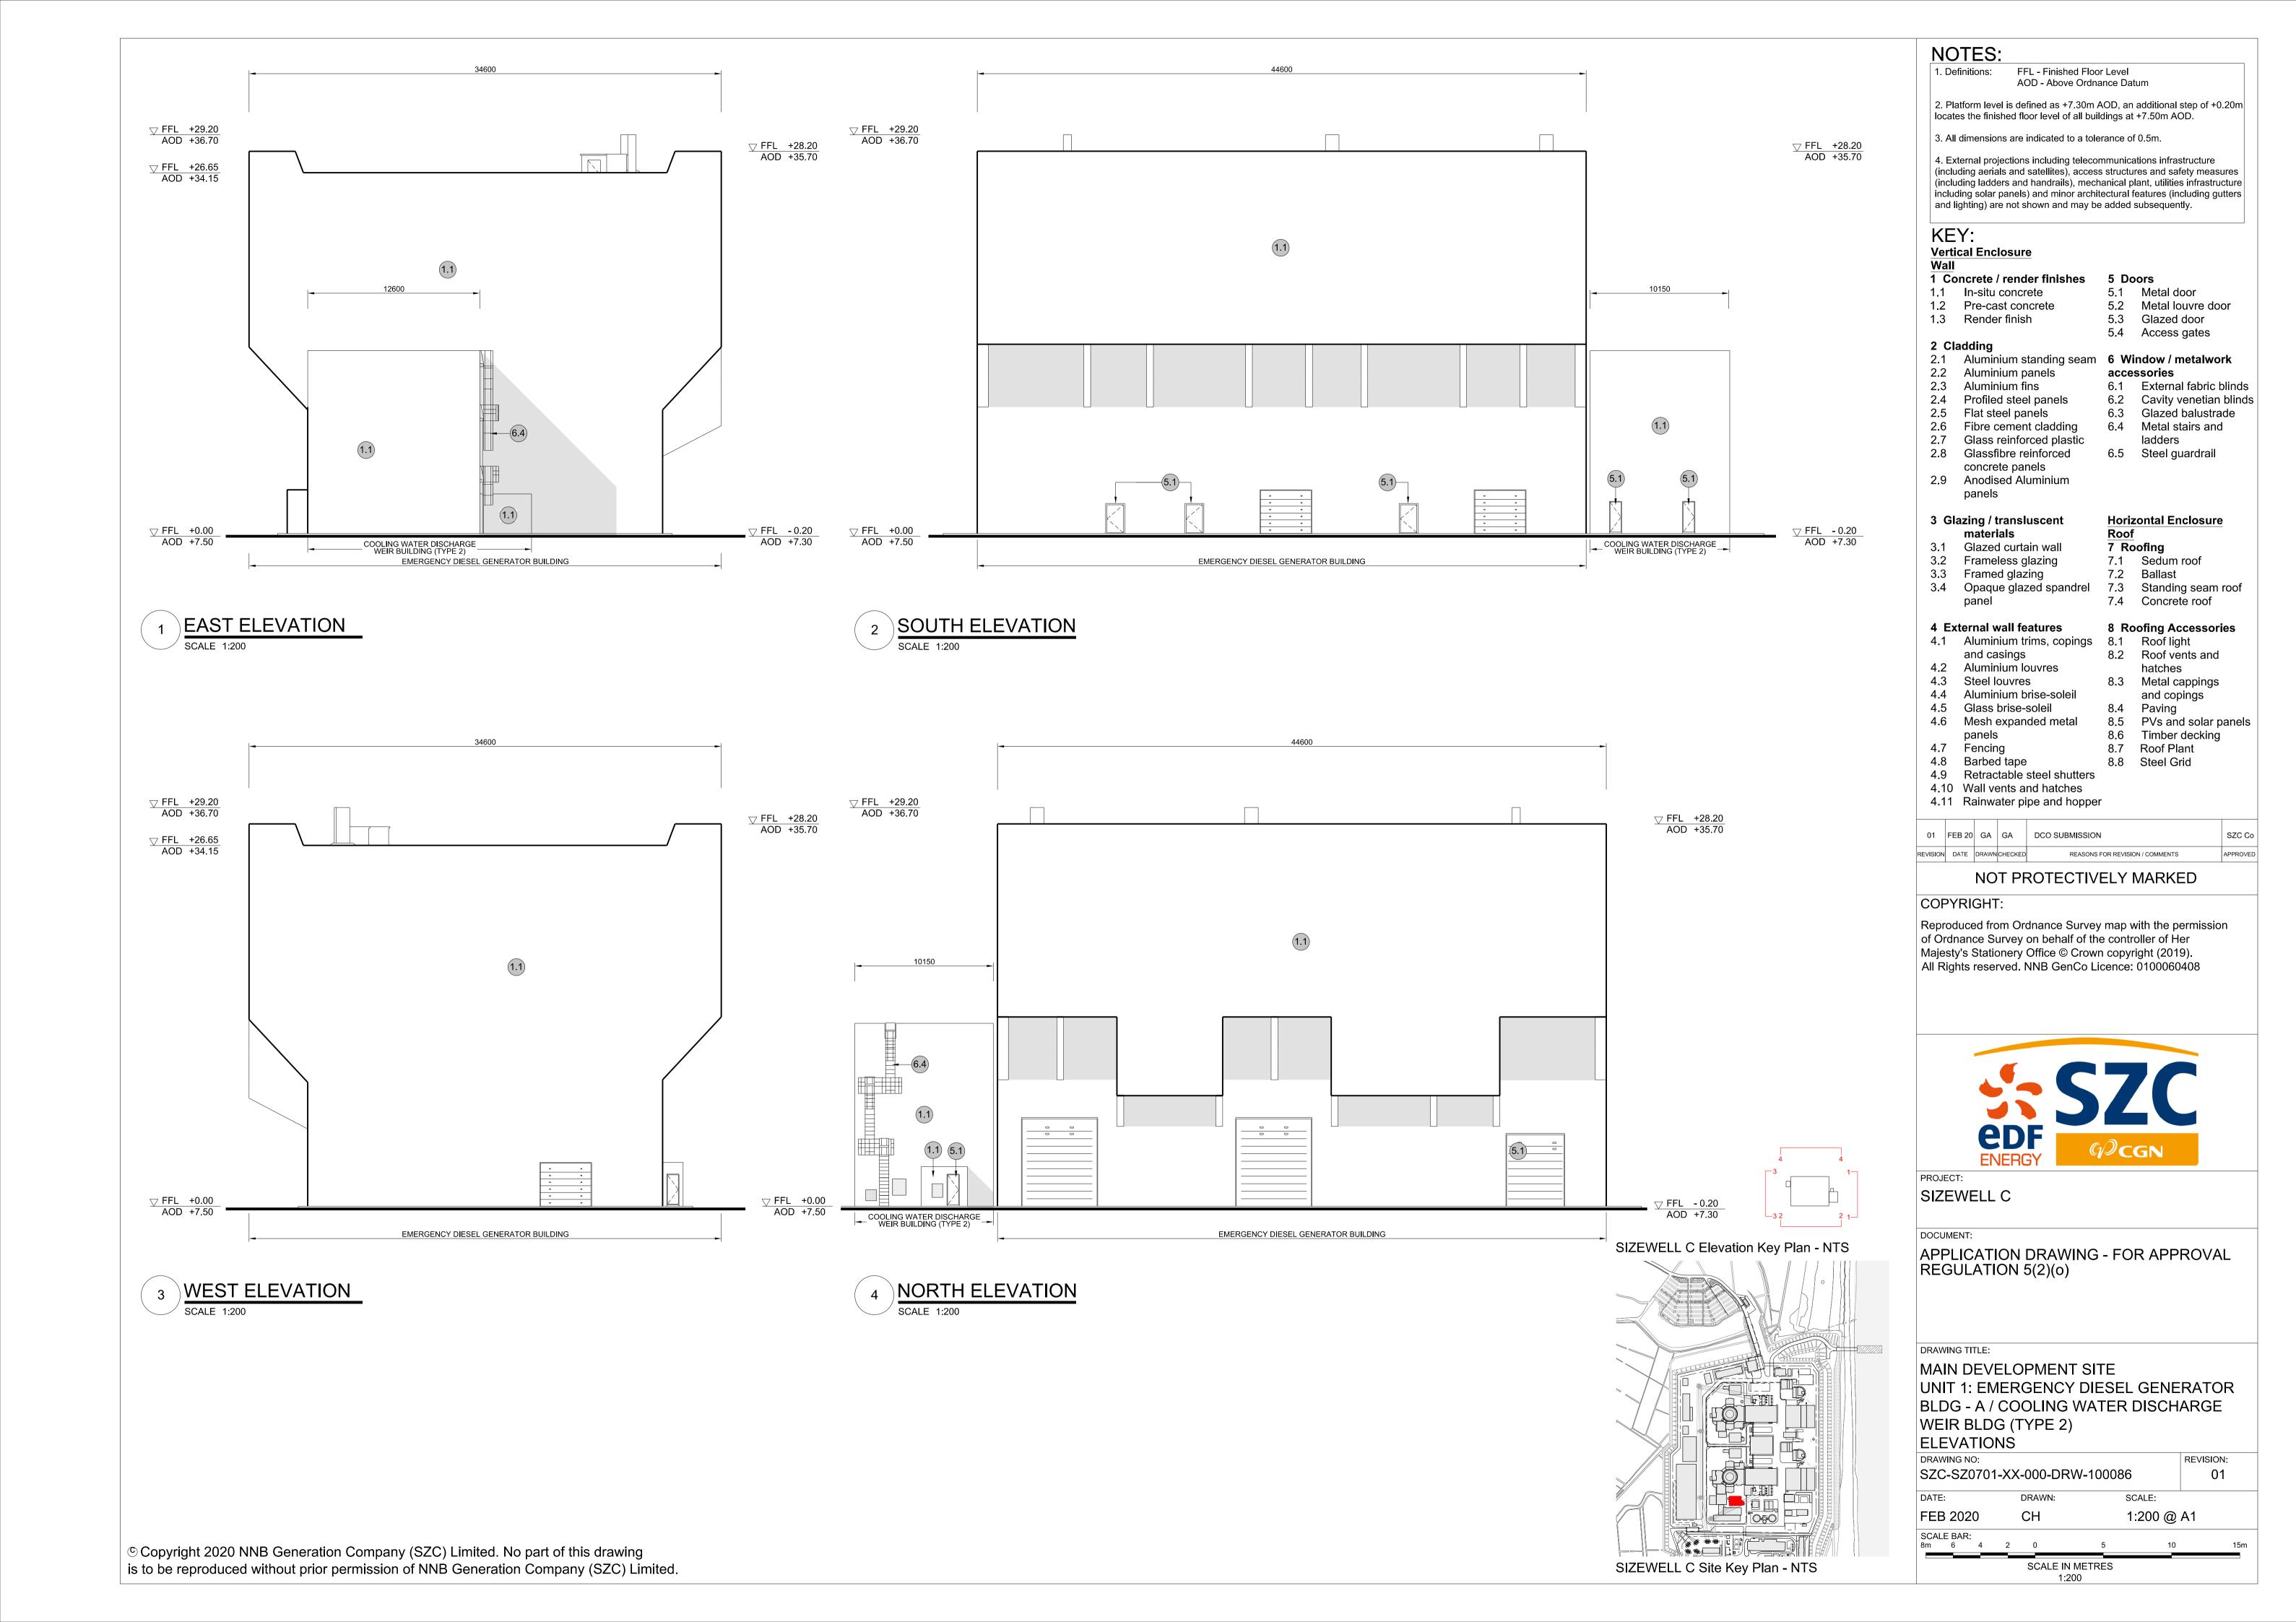APPLICATION DRAWING - FOR APPROVAL REGULATION 5(2)(o)
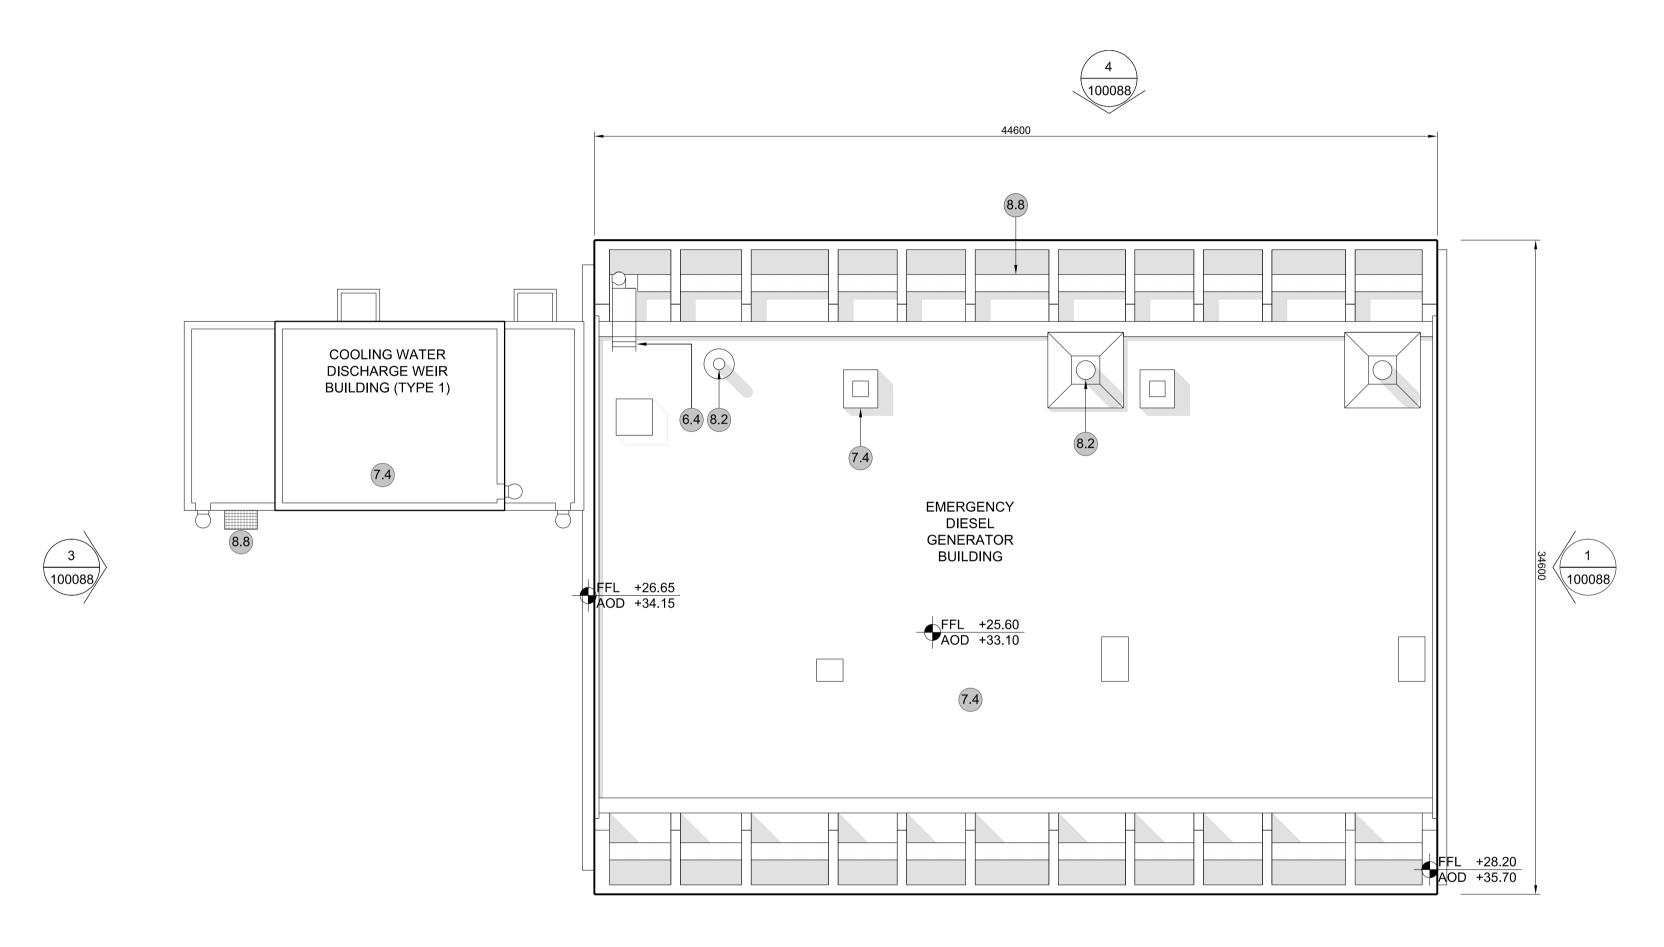
### DRAWING TITLE:

DATE:

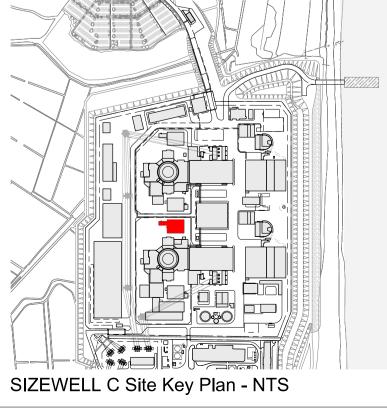MAIN DEVELOPMENT SITE UNIT 1: EMERGENCY DIESEL GENERATOR BLDG - B / COOLING WATER DISCHARGE WEIR BLDG (TYPE 1)

**ROOF PLAN** DRAWING NO: SZC-SZ0701-XX-000-DRW-100087

DRAWN: SCALE: 1:200 @ A1 FEB 2020 EDH

SCALE IN METRES 1:200

REVISION:

01

**ROOF PLAN** 

